# 5TH AVE-MCCOY DR-KAUTZ RD TRAFFIC SIGNAL INSTALLATION

AUGUST, 2021

GENERALLY LOCATED: T38N, R8E, SEC. 25, AURORA TWP, AND T38N, R9E, SEC. 30, NAPERVILLE TWP

#### FOR INDEX OF SHEETS, SEE SHEET NO. 2

#### FOR LIST OF HIGHWAY STANDARDS, SEE SHEET NO 2

#### TRAFFIC DATA

DESIGN DESIGNATION: KAUTZ ROAD = MAJOR COLLECTOR 5TH AVENUE = ARTERIAL MCCOY DRIVE DRIVE = ARTERIAL

#### EXISTING AADT:

KAUTZ ROAD = 3000 5TH AVENUE = 3900 MCCOY DRIVE DRIVE = 6300

#### DESIGN SPEED:

KAUTZ ROAD = 30 5TH AVENUE = 35 MCCOY DRIVE DRIVE = 35

#### POSTED SPEED:

KAUTZ ROAD = 30 MPH 5TH AVENUE = 35 MPH MCCOY DRIVE DRIVE = 35 MPH



### SECTION NUMBER : 21-00340-00-TL

FULL SIZE PLANS HAVE BEEN PREPARED USING STANDARD ENGINEERING SCALES. REDUCED SIZED PLANS WILL NOT CONFORM TO STANDARD SCALES. IN MAKING MEASUREMENTS ON REDUCED PLANS, THE SCALES PROVIDED ON PLAN PAGES MAY BE USED.

PLANS PREPARED BY:

CITY OF AURORA

DEPARTMENT OF PUBLIC WORKS, DIVISION OF ENGINEERING 77 S. BROADWAY – AURORA, IL

FAX: 630-256-3229

PHONE: 630-256-3200

### LOCATION MAP SCALE: N.T.S.



J.U.L.I.E. JOINT UTILITY LOCATION INFORMATION FOR EXCAVATION 1-800-892-0123 OR 811

REVISIONS:								
REVISED 4/25/20	019 BY GERARDO I.	LICON						
						STAMP		DATE
						Illinois registered profess	SIONAL	
						ENGINEER No.		
				HORIZ. SCALE: N/A		LICENSE EXPIRES		
DESIGNED BY: GIL	DRAWN BY: GIL	CHECKED BY: RG	APPROVED BY: RG	VERT. SCALE: N/A	DATE:7/30/2021			



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THIS IMPROVEMENT IS LOCATED IN THE CITY OF AURORA

### **INDEX OF SHEETS**

- 1 COVER SHEET
- 2 INDEX OF SHEETS / LIST OF HIGHWAY STANDARDS / GENERAL NOTES
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- 4 TYPICAL SECTIONS
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- 8 CURB, BIKE PATH, & STORM SEWER IMPROVEMENTS
- 9 TRAFFIC SIGNAL INSTALLATION PLAN -5TH AVE - MCCOY DR - KAUTZ RD
- 10 CABLE PLAN AND PHASE DESIGNATION DIAGRAM -5TH AVE - MCCOY DR - KAUTZ RD
- 11 STREET NAME SIGN DESIGN
- 12 41 MISCELLANEOUS STANDARD DETAILS

### LIST OF HIGHWAY STANDARDS

424016-05 MID-BLOCK CURB RAMPS FOR SIDEWALKs 424021-05 DEPRESSED CORNER FOR SIDEWALKS 606006-04 OUTLETS FOR CONCRETE CURB AND GUTTER TYPE B-6.24 (B-15.60) 701501-06 URBAN LANE CLOSURE. 2L, 2W, UNDIVIDED 701606-10 URBAN SINGLE LANE CLOSURE, MULITLANE, 2W W/ MOUNTABLE MEDIAN 701611-01 URBANHALF ROAD CLOSURE, MULTILANE, 2W W/ MOUNTABLE MEDIAN 701701-10 URBAN LANE CLOSURE, MULTILANE INTERSECTION 701801-06 SIDEWALK, CORNER OR CROSSWALK CLOSURE 728001-01 TELESCOPING STEEL SIGN SUPPORT 814001-03 HANDHOLES 814006-02 DOUBLE HANDHOLES 873001-02 TRAFFIC SIGNAL GROUNDING AND BONDING 876001-04 PEDESTRIAN PUSH BUTTON POST 877001-07 STEEL MAST ARM ASSEMBLY AND POLE 16'-55' 878001-10 CONCRETE FOUNDATION DETAILS, TYPE A,C,D,E 880006-01 TRAFFIC SIGNAL MOUNTING DETAILS

### DISTRICT 1 DETAILS

TC-13 TYPICAL PAVEMENT MARKINGS TC-24 TYPICAL PAVEMENT MARKINGS TS-02 MAST ARM MOUNTED STREET NAME SIGNS **TS-05 TRAFFIC SIGNAL LEGEND** TS-05 SIGNAL POST, MAST ARM LOCATIONS TS-05 CABINET, HANDHOLES, MAST ARM GROUNDING TS-05 EVP, FOUNDATION MODIFICATIONS TS-05 FOUNDATION TYPES, CABINET LENGTH/SLACK TS-05 PEDESTRIAN PUSH BUTTON POST, TYPE A

### CITY OF AURORA STANDARD DETAILS

COA-1 STREET SIGNAGE COA-2 VIDEO DETECTION CAMERA / PTZ MOUNTING DETAILS COA-3 MISCELLANEOUS CURB. GUTTER. SIDEWALK

### **GENERAL NOTES**

#### MISCELLANEOUS

IT IS THE CONTRACTORS RESPONSIBILITY TO ASCERTAIN EXISTING FIELD CONDITIONS BEFORE BIDDING ON THE CONTRACT.

CHANGEABLE MESSAGE SIGNS AND STATIC SIGNS ARE TO BE INCLUDED IN THE COST OF PAY ITEM "TRAFFIC CONTROL AND PROTECTION".

MOBILIZATION CONSISTS OF TRANSPORTATION AND SETUP OF VARIOUS EQUIPMENT NECESSARY TO COMPLETE THE PROJECT, AS WELL AS THE BREAK DOWN AND REMOVAL OF THE SAME EQUIPMENT. THIS ITEM SHALL ΒE

CONSIDERED INCIDENTAL TO THE CONTRACT AND WILL NOT BE PAID FOR SEPARATELY.

UTILITIES

THE CONTRACTOR SHALL COOPERATE WITH THE CITY OF AURORA IF ANY UTILITY IMPROVEMENTS ARE REQUIRED BY THE CITY WITHIN THE DURATION OF THE CONTRACT.

THE CONTRACTOR SHALL BE RESPONSIBLE FOR CONTACTING THE OWNERS OF ALL UTILITIES PRIOR TO CONSTRUCTION TO DETERMINE THE LOCATION OF ALL UTILITY EQUIPMENT. THE CONTRACTOR SHALL COOPERATE WITH ALL UTILITY OWNERS IN ACCORDANCE WITH THE STANDARD SPECIFICATIONS IF UTILITY RELOCATION, ADJUSTMENT, OR PROTECTION IS NECESSARY.

THE LOCATION OF EXISTING DRAINAGE STRUCTURES. STORM SEWERS, WATER MAINS, SANITARY SEWERS, AND ANY OTHER PUBLIC OR PRIVATE UTILITIES AS SHOWN ON THE PLANS IS APPROXIMATE AND THEIR EXACT LOCATION IS TO BE DETERMINED IN THE FIELD BY THE CONTRACTOR. THIS WORK SHALL BE CONSIDERED AS INCLUDED IN THE UNIT BID PRICES OF THE CONTRACT, AND NO ADDITIONAL COMPENSATION WILL BE ALLOWED, INCLUDING CLAIMS BY THE CONTRACTOR FOR TIME LOST (LABOR AND EQUIPMENT) DUE TO UTILITIES LOCATIONS OR RELOCATING UTILITIES.

CHANGEABLE MESSAGE BOARD TO BE PLACED BY CONTRACTOR AS SPECIFIED ON SITE BY ENGINEER, 7 DAYS BEFORE AND AFTER TRAFFIC SIGNALS ARE ENERGIZED. RELOCATION OF CMS OR STATIC SIGNS AS NEED TO BE DEEMED BY ENGINEER AT NO ADDITIONAL COMPENSATION

RESTORATION

RESTORATION TO BE COMPLETED BY CONTRACTOR TO MATCH EXISTING CONDITIONS AND TO INCLUDE TOPSOIL, AURORA SEEDING MIX, AND/OR SOD AS DIRECTED BY ENGINEER. RESTORATION ALSO INCLUDES, BUT IS NOT LIMITED TO THE FOLLOWING ITEMS: CURB AND GUTTER, SIDEWALK, FOUNDATION ITEMS, AND AT/NEAR TRAFFIC SIGNAL HANDHOLES, FOUNDATIONS AND CONDUIT. THIS WORK SHALL BE CONSIDERED AS INCLUDED IN THE UNIT BID PRICES OF THE CONTRACT, AND NO ADDITIONAL COMPENSATION WILL BE ALLOWED

						ADDITIONAL COMPENSATION WILL BE ALLOWE
	CITY OF AURORA ENGINEERING DIVISION	REVISIONS:				5TH AVE-MCCOY E TRAFFIC SIGNAL IN
	77 S. BROADWAY	DESIGNED BY: GIL	CHECKED BY: $RG$	SCALE:	SHEET TITLE	
CITY OF LIGHTS		DRAWN BY: GIL	APPROVED BY: RG	DATE: 7/2021		INDEX OF SHEETS, LIST OF HIGHWAY ST

### **DR-KAUTZ RD** ISTALLATION

ANDARDS, AND GENERAL NOTES

FOTAL SHEETS

SHEET NUMBER

41

		ITENA		TOTAL QUANTITY
IOTE	CODE NUMBER	ITEM EARTH EXCAVATION	CU YD	25
	2	TOPSOIL FURNISH AND PLACE	SQYD	245
	3	SEEDING, CLASS 2A	ACRE	0.25
	4	NITROGEN FERTILIZER NUTRIENT	POUND	5
	5	POTASSIUM FERTILIZER NUTRIENT	POUND	5
	6	EROSION CONTROL BLANKET	SQ YD	245
	7	AGGREGATE BASE COURSE, TYBE B 6"	SQ YD	125
	8	HOT-MIX ASPHALT SURFACE REMOVAL, BUTT JOINT	SQ YD	15
	9	HOT-MIX ASPHALT BINDER COURSE, IL-9.5, N70 AT 1.5"	TON	55
	10	HOT-MIX ASPHALT SURFACE COURSE, MIX "D", IL-9.5, N70 AT 1.5"	TON	55
	11	PORTLAND CEMENT CONCRETE SIDEWALK 5 INCH	SQ FT	360
	12	DETECTABLE WARNINGS	SQ FT	20
	13	PAVEMENT REMOVAL	SQ YD	130
	14	HOT-MIX ASPHALT SURFACE REMOVAL, 2 1/4"	SQ YD	55
	15	COMBINATION CONCRETE CURB AND GUTTER REMOVAL	FOOT	100
	16	SIDEWALK REMOVAL	SQ FT	100
	17	CLASS D PATCHES, TYPE 1, 3 INCH	SQ YD	20
		STORM SEWERS, CLASS A, TYPE 4 12"	FOOT	100
	18		EACH	1
	19	CATCH BASINS, TYPE C, TYPE 8 GRATE		
	20	INLETS, TYPE A, TYPE 2 FRAME AND GRATE	EACH	1
	21	MANHOLES TO BE ADJUSTED WITH NEW TYPE & GRATE	EACH	1
	22	COMBINATION CONCRETE CURB AND GUTTER, TYPE B-6.12	FOOT	150
	23	MOBILIZATION	LSUM	1
	24	CHANGEABLE MESSAGE SIGN	CAL DA	42
	25	SHORT TERM PAVEMENT MARKINGS	FOOT	2300
	26	TEMPORARY PAVEMENT MARKINGS- LETTETS & SYMBOLS	SQ FT	100
	27	SIGN PANEL - TYPE 1	SF	42
	28	SIGN PANEL - TYPE 2	SF	32
	29	INSTALL EXISTING SIGN PANEL	SQ FT	8
	30	REMOVE SIGN PANEL - TYPE 1	SF	23
	31	TELESCOPING STEEL SIGN SUPPORT	FT	90
	32	BASE FOR TELESCOPING STEEL SIGN SUPPORT	EA	6
	33	THERMOPLASTIC PAVEMENT MARKINGS - LETTERS AND SYMBOLS	SF	175
	34	THERMOPLASTIC PAVEMENT MARKINGS, 4" (YELLOW)	FT	1030
	35	THERMOPLASTIC PAVEMENT MARKINGS, 4" (WHITE)	FT	605
	36	THERMOPLASTIC PAVEMENT MARKINGS, 6" (WHITE)	FT	595
	37	THERMOPLASTIC PAVEMENT MARKINGS, 12" (WHITE)	FT	440
	38	THERMOPLASTIC PAVEMENT MARKINGS, 24" (WHITE)	FT	100
	39	SERVICE INSTALLATION - POLE MOUNTED	EACH	1
	40	UNDERGROUND CONDUIT, GALVANIZED STEEL, 2° DIA	FOOT	100
	41	UNDERGROUND CONDUIT, GALVANIZED STEEL, 3" DIA	FOOT	50
	42	UNDERGROUND CONDUIT, GALVANIZED STEEL, 4" DIA	FOOT	275
	43	HANDHOLE	EACH	3
	44	DOUBLE HANDHOLE	EACH	1

**REVISIONS:** 

		SUMMARY OF QUANTITIES		
NOTE	CODE NUMBER 45	ITEM ELECTRIC CABLE IN CONDUIT, 600V (XLP-TYPE USE) 3-1/C NO. 10	UNITY FOOT	TOTAL QUANTIT 515
	46	LUMINAIRE, LED, ROADWAY, OUTPUT DESIGNATION H	EACH	1
	47	FULL-ACTUATED CONTROLLER AND TYPE IV CABINET	EACH	1
	48	ELECTRIC CABLE IN CONDUIT, SIGNAL NO. 14 2C	FOOT	530
	49	ELECTRIC CABLE IN CONDUIT, SIGNAL NO. 14 3C	FOOT	1230
	50	ELECTRIC CABLE IN CONDUIT, SIGNAL NO. 14 5C	FOOT	1540
	51	ELECTRIC CABLE IN CONDUIT, SIGNAL NO. 147C	FOOT	1420
	52	ELECTRIC CABLE IN CONDUIT, SERVICE, NO. 6 2C	FOOT	100
	53	ELECTRIC CABLE IN CONDUIT, EQUIPMENT GROUNDING CONDUCTER, NO. 6 1C	FOOT	410
	54	TRAFFIC SIGNAL POST, GALVANIZED STEEL 16 FT	EACH	2
	55	STEEL MAST ARM ASSEMBLY AND POLE, 20 FT	EACH	1
	56	STEEL MAST ARM ASSEMBLY AND POLE, 26 FT	EACH	1
	57	STEEL MAST ARM ASSEMBLY AND POLE, 36 FT	EACH	1
	58	STEEL COMBINATON MAST ARM ASSEMBLY AND POLE, 38 FT (20 FT. LUMINAIRE ARM)	EACH	1
	59	CONCRETE FOUNDATION, TYPE A	FOOT	12
	60		FOOT	4
		CONCRETE FOUNDATION, TYPE C		
	61	CONCRETE FOUNDATION, TYPE E 30-INCH DIAMETER	FOOT	45
	62	CONCRETE FOUNDATION, TYPE E 36-INCH DIAMETER	FOOT	15
	63	SIGNAL HEAD, LED, 1-FACE, 3 SECTION, MAST-ARM MOUNTED	EACH	5
	64	SIGNAL HEAD, LED, 1 FACE, 3 SECTION, BRACKET MOUNTED	EACH	3
	65	SIGNAL HEAD, LED, 1-FACE, 5 SECTION, BRACKET MOUNTED	EACH	3
	66	SIGNAL HEAD, LED, 1-FACE, 5 SECTION, MAST-ARM MOUNTED	EACH	3
	67	PEDESTRAIN SIGNAL HEAD, LED, 1-FACE, BRACKET MOUNTED WITH COUNTDOWN TIMER	EACH	4
	68	TRAFFIC SIGNAL BACKPLATE, LOUVERED, FORMED PLASTIC	EACH	8
	69	LIGHT DETECTOR (INCLUDE CONFIRMATION BEACON)	EACH	4
	70	LIGHT DETECTOR AMPLIFIER	EACH	1
	71	PEDESTRIAN PUSH-BUTTON	EACH	4
	72	EMERGENCY VEHICLE PRIORITY SYSTEM LINE SENSOR CABLE, NO. 20 3/C	FOOT	710
	73	ETHERNET SWITCH	EACH	1
	74		EACH	
				1
	75	CAT. 6 ETHERNET CABLE	FOOT	155
*	76	UNINTERUPTABLE POWER SUPPLY, SPECIAL	EACH	1
	77	PEDESTRIAN PUSH-BUTTON POST	EACH	1
	78	CONNECTING TO EXISTING MANHOLES BY CORE DRILLING	EACH	2
	79	INTERSECTION VIDEO TRAFFIC MONITORING SYSTEM WITH PTZ CAMERA	EACH	1
	80	CENTRALIZED SYSTEM FIELD INTEGRATION / SETUP	LSUM	1
	81	CONSTRUCTION LAYOUT	LSUM	1
***	82	ITEMS ORDERED BY ENGINEER	ALLOWANCE	1
*	83	TRAFFIC CONTROL AND PROTECTION, STANDARD 701501	LSUM	1
*	84	TRAFFIC CONTROL AND PROTECTION, STANDARD 701606	LSUM	1
*	85	TRAFFIC CONTROL AND PROTECTION, STANDARD 701611	LSUM	1
*	86	TRAFFIC CONTROL AND PROTECTION, STANDARD 701701	LSUM	1
		TRAFFIC CONTROL AND PROTECTION, STANDARD 701801	LSUM	1




CITY OF AURORA ENGINEERING DIVISION 77 S. BROADWAY


5TH AVE-MCCOY D TRAFFIC SIGNAL IN DESIGNED BY: RA CHECKED BY: RG SCALE: SHEET TITLE SUMMARY OF QU DRAWN BY: GIL/AH APPROVED BY: RG DATE: 7/2021

PROJECT

EACH	1
EACH	1
FOOT	530
FOOT	1230
FOOT	1540
FOOT	1420
FOOT	100
FOOT	410
EACH	2
EACH	1
FOOT	12
FOOT	4
FOOT	45
FOOT	15
EACH	5
EACH	3
EACH	3
EACH	3
EACH	4
EACH	8
EACH	4
EACH	1
EACH	4
FOOT	710
EACH	1
EACH	1
FOOT	155
EACH	1
EACH	1
EACH	2
EACH	1
LSUM	1
LSUM	1
OWANCE	1
LSUM	1
R-K	KAUTZ
	ALLAT
517	<b>LLAI</b>
JAN	<b>FITIES</b>

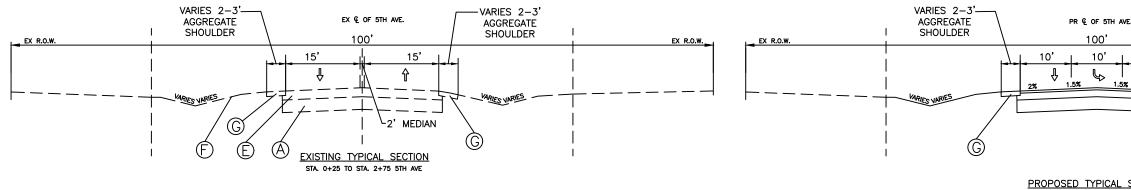


STA. 0+25 TO STA. 2+75

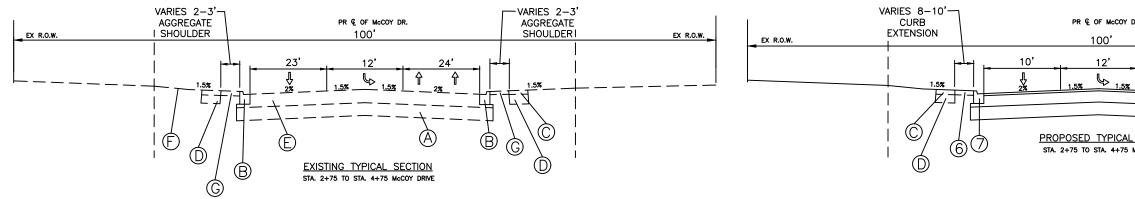


	LEGEND	PROPOSED			
EXISTING	(	1) PAVEMENT REMOVAL			
A EXISTING BASE	(	CURB EXTENSION			HOT-MIX ASPHALT MIXTURE
B CONCRETE CURB & GUT	TER TYPE B-6.12	3 SIDEWALK REMOVAL			MIXTURE TYPE
C PORTLAND CEMENT CON	CRETE SIDEWALK (	4 portland cement concrete sidewalk 5"			PAVEMENT RESURFACING: 5TH AVE
D SIDEWALK BASE		5) AGGREGATE BASE COURSE, TYPE B, 6"			HOT-MIX ASPHALT SURFACE COURSE, MIX "D", IL-9.5, $1-1/2$ "
<ul> <li>(F) HOT-MIX ASPHALT PAVE</li> <li>(F) EXISTING GROUND</li> </ul>	MENT (VARIES 5" TO 9") (	6 TOPSOIL (DEPTH VARIES) SEEDING CLASS 2A FERTILIZER & EROSION CONTROL BLANKET			HOT-MIX ASPHALT BINDER COURSE. IL-9.5, N70; 1-1,
G AGGREGATE SHOULDER	(	COMBINATION CONCRETE CURB & GUTTER, TYPE B-6.12			PATCHING AND CLASS D PATCHING
H STRIPED DIAGONALS	(	(B) HOT-MIX ASPHALT SURFACE COURSE, MIX "D",IL-9.5, N70; 1.5"			CLASS D (HMA BINDER IL-19 MM)
	(	(9) HOT-MIX ASPHALT BINDER COURSE, IL-9.5, N70; 1.5"			
	CITY OF AURORA	REVISIONS:		PROJECT	5TH AVE-MCCOY DI
	ENGINEERING DIVISIO	DN			TRAFFIC SIGNAL INS
CITY OF LIGHTS	77 S. BROADWAY	DESIGNED BY: GIL CHECKED BY: RA SC DRAWN BY: GIL/AH APPROVED BY: RG DA	CALE:         NTS           ATE:         7/2021	SHEET TITLE	TYPICAL SECT


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we. [		1	
			EX R.O.W.
8	MARIES VARIES	   	
9	G	1	
SECTION 5 5TH AVE			
Y DR.	VARIES 2- AGGREGA SHOULDE	re R	ex r.o.w.
24'	= <sup></sup>		
<u>x 2%</u>			
AL SECTION 5 McCOY DRIVE		   	
(	9) () <u>NOTE</u>	s:	
	TEMP	ORARY PAVEMENT RMINED BY R.E.	MARKINGS TO BE
			MENT REMOVAL
E REQUIR	MENTS AIR VOIDS		
9.5, N70;	4% @ 70 GYR. 4% @ 70 GYR.		
-1/2"	4% @ 70 GYR.		
	4% @ 70 GYR.		
	·		
DR-KAU NSTALI	JTZ RD LATION		SHEET NUMBER
CTIONS			total sheets <b>41</b>

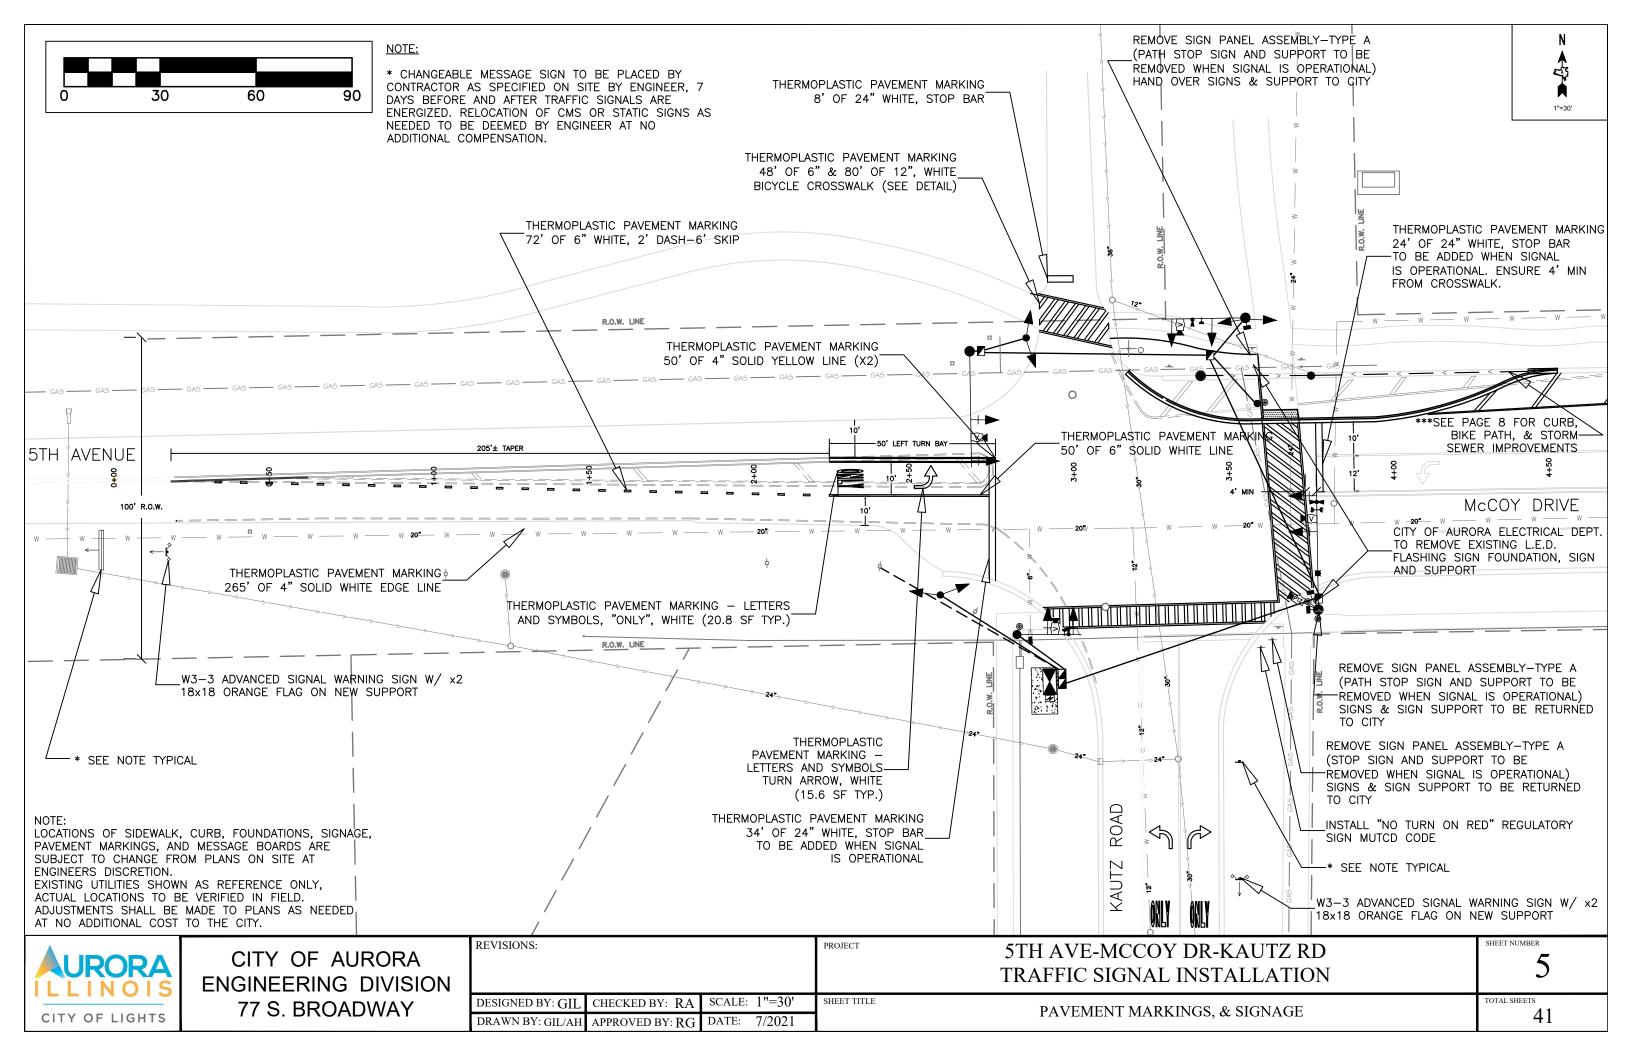



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	I // //				RELOCATIO
	<b> </b>    /				TO BE DEEMED BY ENG
			THORNWOOD COU	PT	W
					W
				W	W THERMOPLASTIC PAVEMENT - LETTERS AND
			W	W	LANE MERGE ARR
			W W W		
	· · · · · · · · · · · · · · · · · · ·		RMOPLASTIC PAVEMENT MARKING ' OF 4" SOLID WHITE		2
			RGE EDGE LINE	>>	
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	4 4				
					99+1
		Λ	K	00+2	·
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	V c			20 <b>*</b> w w	W W 20° W W
w w w w	W W W W W W W	W W W	_ w w \ "		
McCOY DRIVE					
	۶ ۴		ę	R.O.W. LINE	
				R.O.W. Link	$\langle  $
				$\mathbf{n}$	REMOVE SIGN FR
	AVEMENT MARK	SOLID WHITE			POST
	LANE L	NE (3.30 SF)		∣	MOPLASTIC PAVEMENT MARKING TTERS AND SYMBOLS
	$\backslash$			(14.5	MERGE ARROW, WHITE SF)
NOTE:					
PAVEMENT MARKINGS, A	K, CURB, FOUNDATIONS, SIGNAGE, ND MESSAGE BOARDS ARE ROM PLANS ON SITE AT				
ENGINEERS DISCRETION.	WN AS REFERENCE ONLY.				
ACTUAL LOCATIONS TO	BE VERIFIED IN FIELD. E MADE TO PLANS AS NEEDED T TO THE CITY.				
AT NO ADDITIONAL COS					
	CITY OF AURORA	REVISIONS:		PROJECT	5TH AVE-MCCOY D
	ENGINEERING DIVISION				TRAFFIC SIGNAL IN
CITY OF LIGHTS	77 S. BROADWAY	DESIGNED BY: GIL		SHEET TITLE	PAVEMENT MARKIN
CIT OF LIGHTS		DRAWN BY: GIL/AH	APPROVED BY: RG DATE: 7/2021		




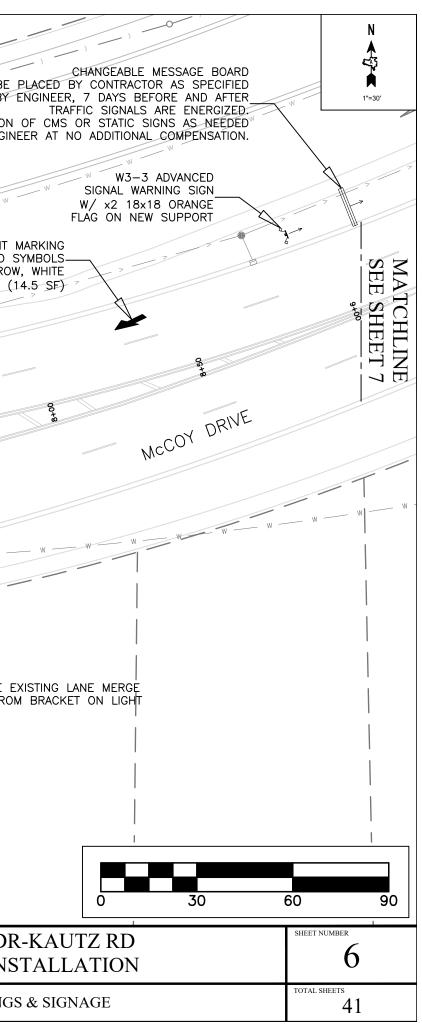

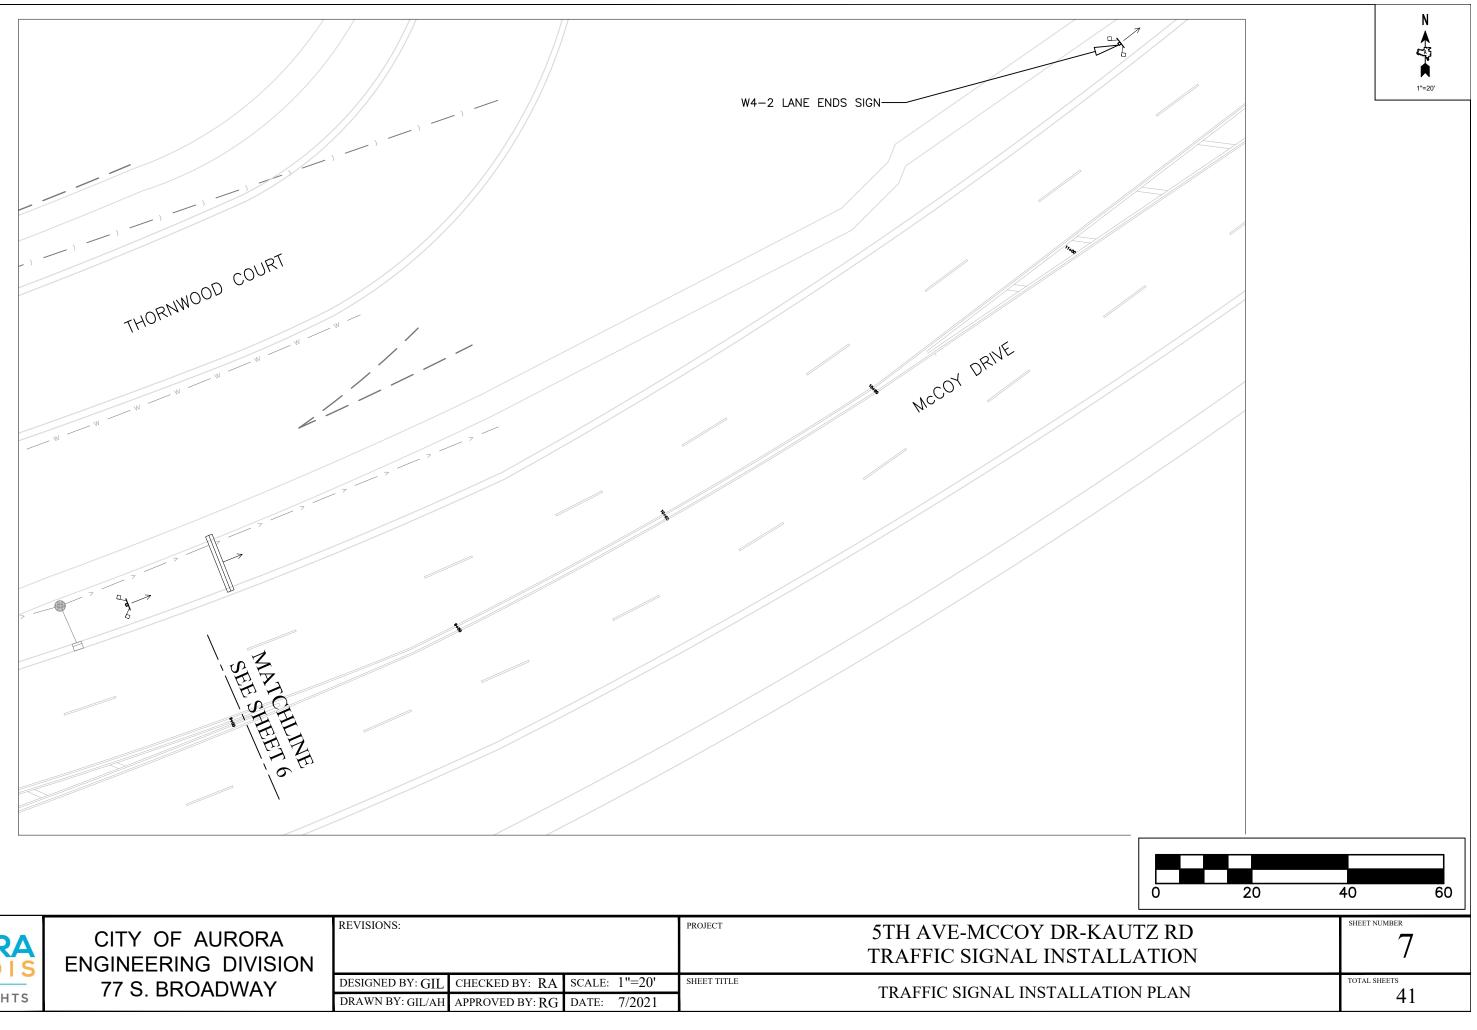	CITY OF AURORA ENGINEERING DIVISION	REVISIONS:			PROJECT	5TH AVE-MCCOY DF TRAFFIC SIGNAL INS
	77 S. BROADWAY	DESIGNED BY: GIL	CHECKED BY: RA	SCALE: 1"=20'	SHEET TITLE	TRAFFIC SIGNAL INSTAI
CITY OF LIGHTS		DRAWN BY: GIL/AH	APPROVED BY: RG	DATE: 7/2021	]	TRAFTIC SIGNAL INSTAL

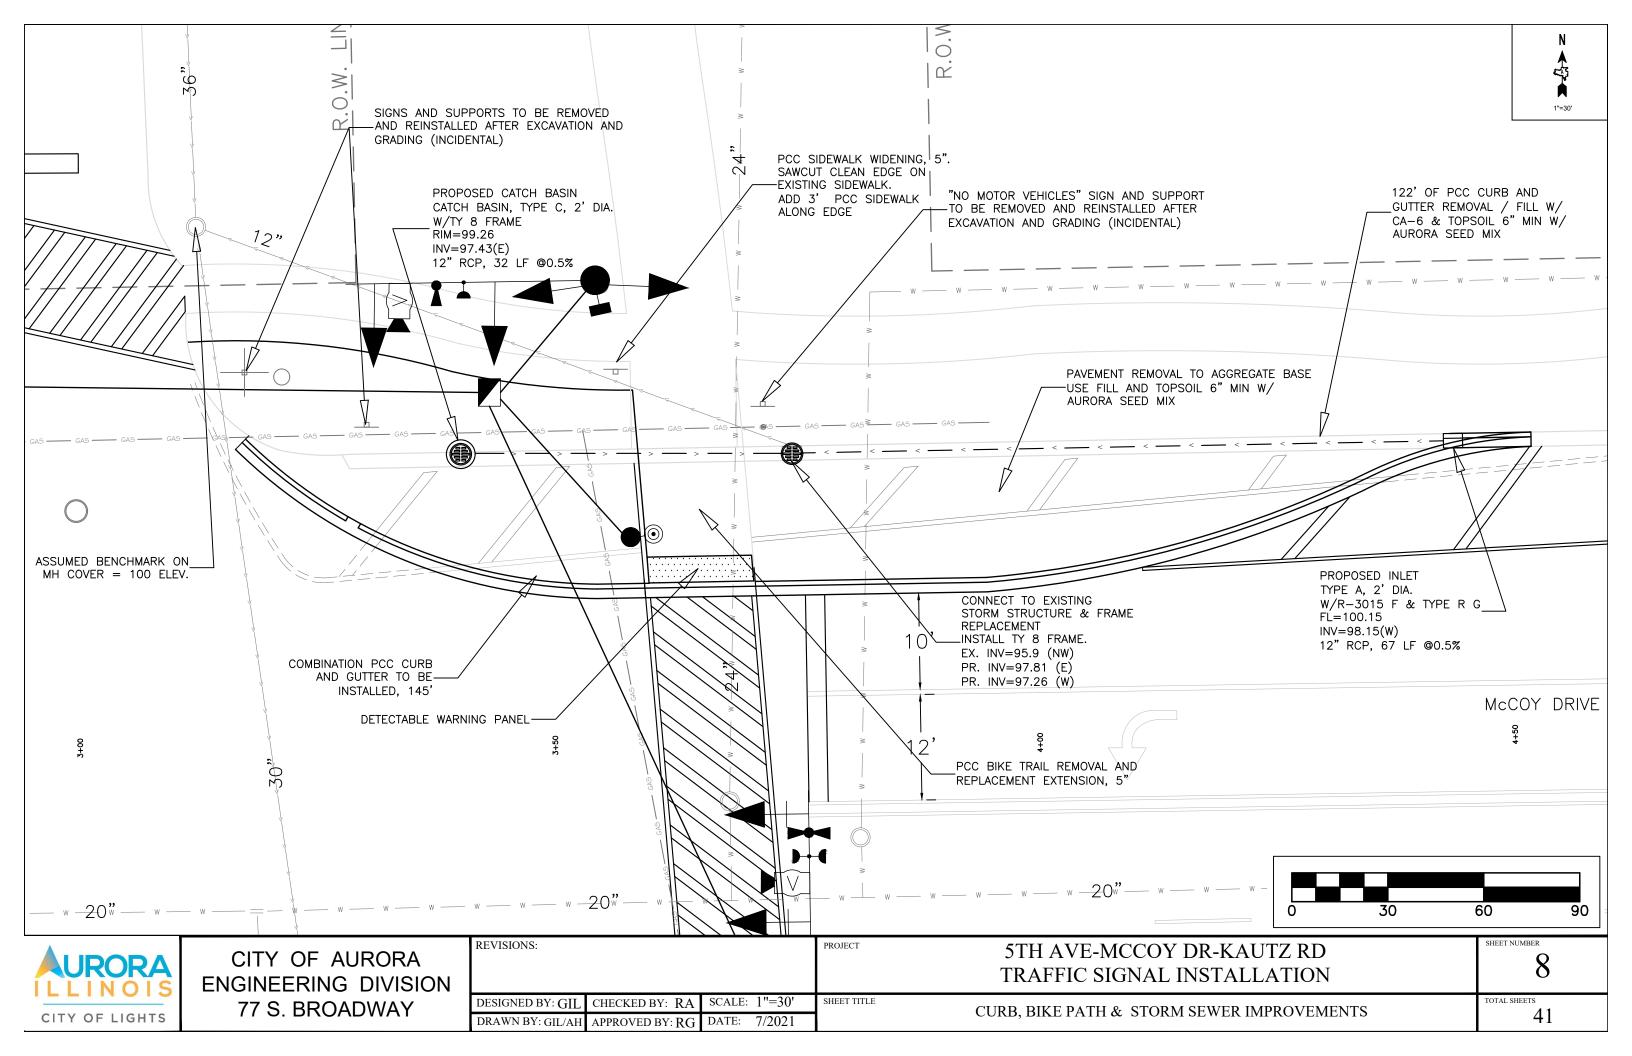

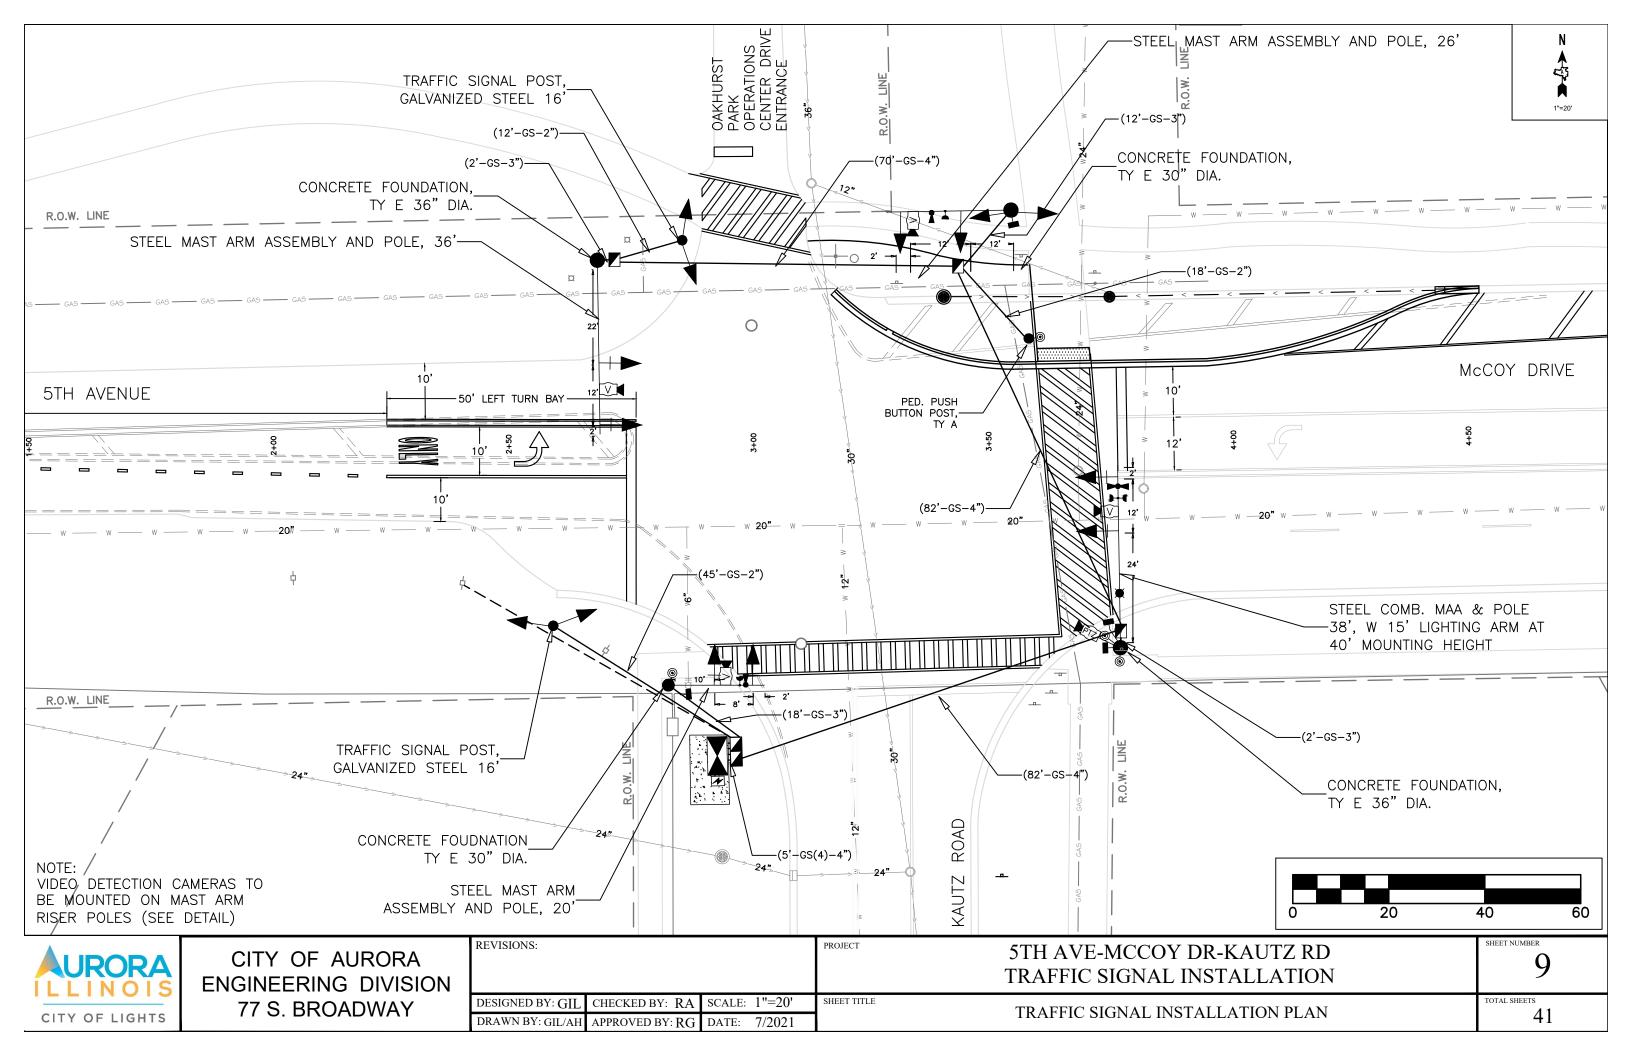

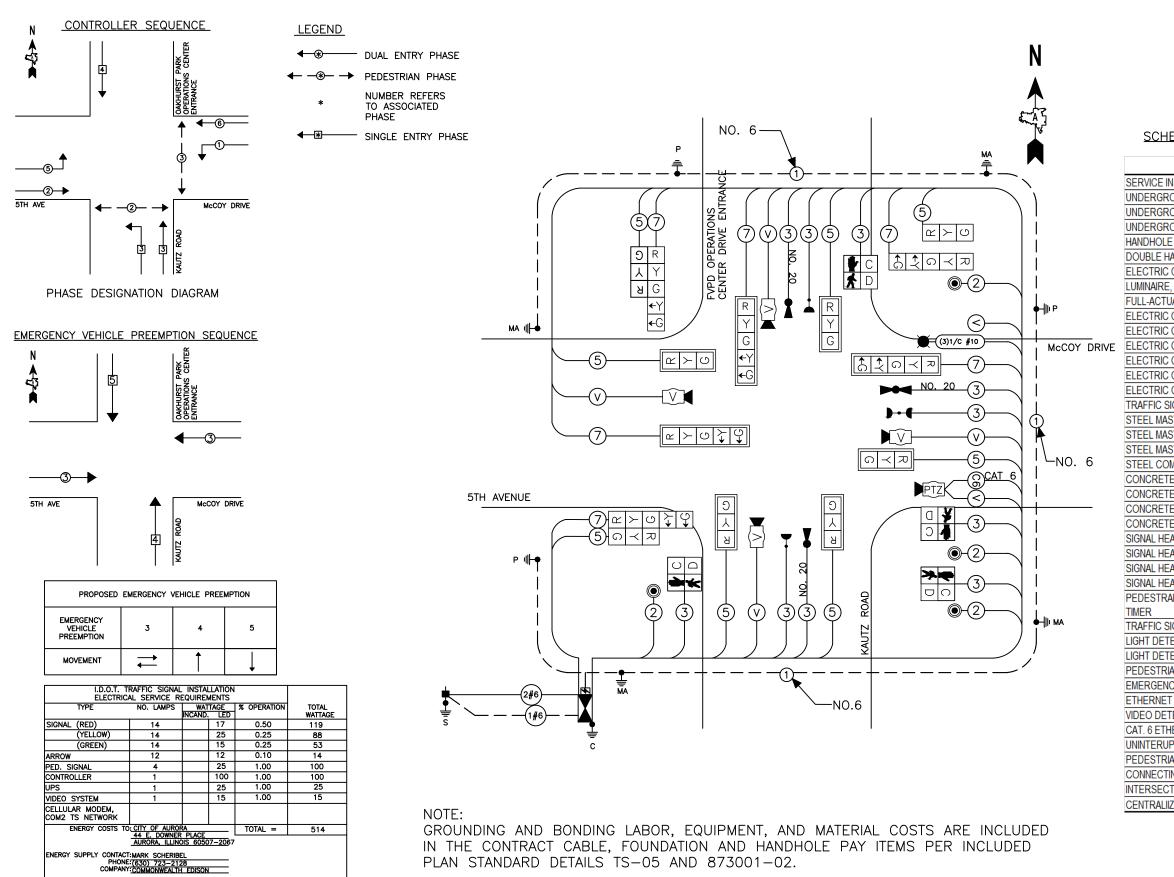


	CITY OF AURORA ENGINEERING DIVISION	REVISIONS:	PROJECT	5TH AVE-MCCOY DR TRAFFIC SIGNAL INS
		DESIGNED BY: GIL CHECKED BY: RA SCALE: NTS	SHEET TITLE	SCHEDULE OF QUANTITIES, CABLE PLAN, PL
CITY OF LIGHTS		DRAWN BY: GIL/AH APPROVED BY: <b>RG</b> DATE: 7/2021		AND EMERGENCY VEHICLE PREE

#### SCHEDULE OF QUANTITIES

PAY ITEM DESCRIPTION	UNIT	QUANTITY
NSTALLATION - POLE MOUNTED	EACH	1
OUND CONDUIT, GALVANIZED STEEL, 2" DIA.	FOOT	100
OUND CONDUIT, GALVANIZED STEEL, 3" DIA.	FOOT	50
OUND CONDUIT, GALVANIZED STEEL, 4" DIA.	FOOT	275
E	EACH	3
IANDHOLE	EACH	1
CABLE IN CONDUIT, 600V (XLP-TYPE USE) 3-1/C NO. 10	FOOT	515
, LED, ROADWAY, OUTPUT DESIGNATION H	EACH	1
UATED CONTROLLER AND TYPE IV CABINET	EACH	1
CABLE IN CONDUIT, SIGNAL NO. 14 2C	FOOT	530
CABLE IN CONDUIT, SIGNAL NO. 14 3C	FOOT	1230
CABLE IN CONDUIT, SIGNAL NO. 14 5C	FOOT	1540
CABLE IN CONDUIT, SIGNAL NO. 14 7C	FOOT	1420
CABLE IN CONDUIT, SERVICE, NO. 6 2C	FOOT	100
CABLE IN CONDUIT, EQUIPMENT GROUNDING CONDUCTER, NO. 6 1C	FOOT	410
SIGNAL POST, GALVANIZED STEEL 16 FT	EACH	2
ST ARM ASSEMBLY AND POLE, 20 FT	EACH	1
ST ARM ASSEMBLY AND POLE, 26 FT	EACH	1
ST ARM ASSEMBLY AND POLE, 36 FT	EACH	1
MBINATON MAST ARM ASSEMBLY AND POLE, 38 FT (20 FT. LUMINAIRE ARM)		1
E FOUNDATION, TYPE A	FOOT	12
E FOUNDATION, TYPE C	FOOT	4
E FOUNDATION, TYPE E 30-INCH DIAMETER	FOOT	45
	FOOT	15
EAD, LED, 1-FACE, 3 SECTION, MAST-ARM MOUNTED	EACH	5
EAD, LED, 1 FACE, 3 SECTION, BRACKET MOUNTED	EACH	3
AD, LED, 1-FACE, 5 SECTION, BRACKET MOUNTED	EACH	3
EAD, LED, 1-FACE, 5 SECTION, MAST-ARM MOUNTED	EACH	3
AIN SIGNAL HEAD, LED, 1-FACE, BRACKET MOUNTED WITH COUNTDOWN	EACH	4
SIGNAL BACKPLATE, LOUVERED, FORMED PLASTIC	EACH	8
TECTOR (INCLUDE CONFIRMATION BEACON)	EACH	4
TECTOR AMPLIFIER	EACH	1
IAN PUSH-BUTTON	EACH	4
CY VEHICLE PRIORITY SYSTEM LINE SENSOR CABLE, NO. 20 3/C	FOOT	710
T SWITCH	EACH	1
TECTION SYSTEM	EACH	1
HERNET CABLE	FOOT	155
PTABLE POWER SUPPLY, SPECIAL	EACH	100
IAN PUSH-BUTTON POST	EACH	1
ING TO EXISTING MANHOLES BY CORE DRILLING	EACH	2
TION VIDEO TRAFFIC MONITORING SYSTEM WITH PTZ CAMERA	EACH	1
IZED SYSTEM FIELD INTEGRATION / SETUP	L SUM	1

OR-KAUTZ RD ISTALLATION	sheet number 10
, PHASE DESIGNATION DIAGRAM EEMPTION SEQUENCE	total sheets 41

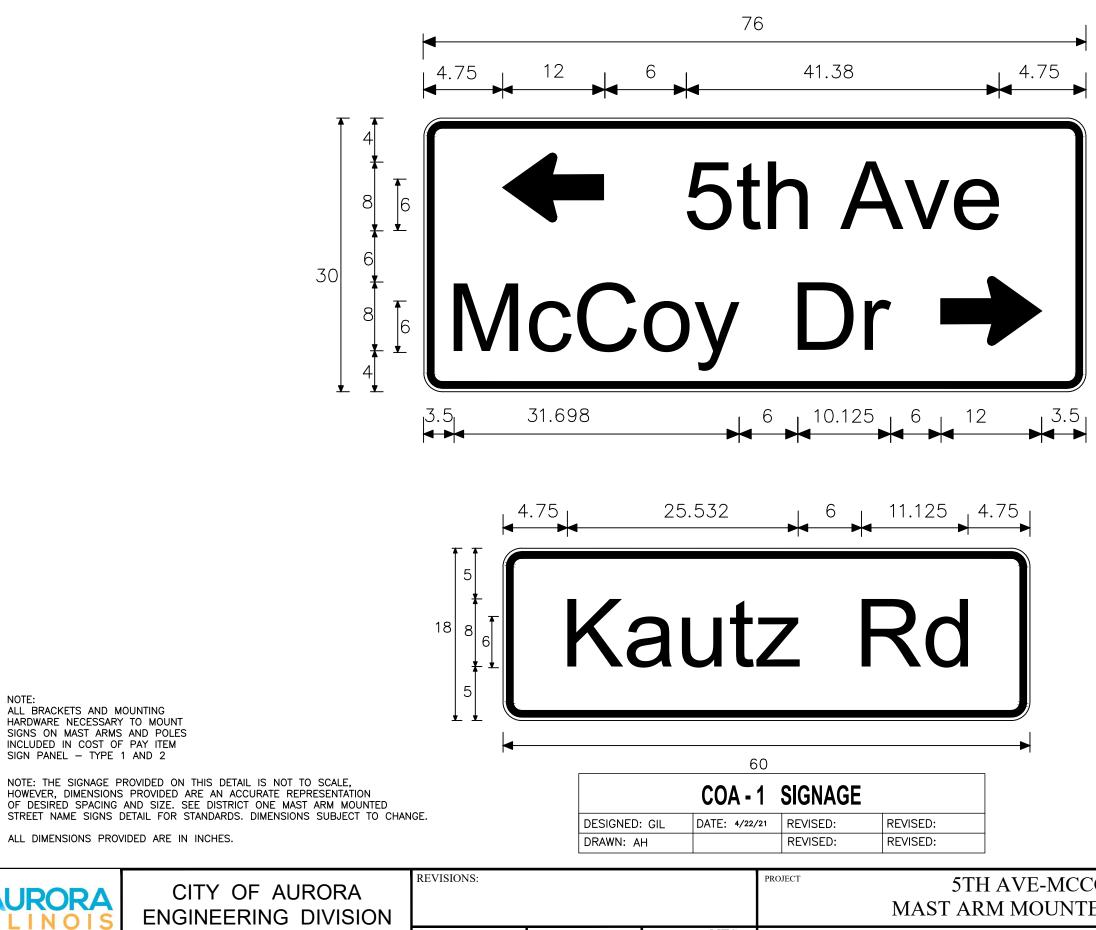

CITY OF LIGHTS


CITY OF AURORA	REVISIONS:			PROJECT	5TH AVE-MCCOY DR-KAUTZ RD MAST ARM MOUNTED STREET NAME SIGNS	SHEEI NUMBER
	DESIGNED BY: GIL CH	THECKED BY: RA	SCALE: NTS	SHEET TITLE	SHEET TITLE STREET NAME SIGN DESIGNS	
	DRAWN BY: GIL/AH AH	PPROVED BY: RG	DATE: 7/2021			


			5-2-	(NOT TO SCALE)	<u>n</u>	
TEM	EXISTING	PROFOSED	TEM	EXISTING	PROPOSED	LITEM
CONTROLLER CABINET	$\boxtimes$	×	HANDHOLE -SQUARE	0 0		SIGNAL HEAD (P) PROGRAMMABLE SIGNAL HEAD
COMMUNICATION CABINET	ECC	cc	-ROUND		100 CO	·(r) PROGRAMMAGE SIGNAL READ
MASTER CONTROLLER	EMC.	MC,	HEAVY DUTY HANDHOLE -SQUARE -ROUND	•	•	
MASTER MASTER CONTROLLER	Exec	kessed	DOUBLE HANDHOLE	NN	122	
JNINTERRUPTABLE POWER SUPPLY	Ø	æ	JUNCTION BOX		-	SIGNAL HEAD WITH BACKPLATE (P) PROGRAMMABLE SIGNAL HEAD (RB) RETROREFLECTIVE BACKPLATE
SERVICE INSTALLATION	- <b>D</b> - <sup>P</sup>		RAILROAD CANTILEVER MAST ARM	X <del>ox - R X</del>	I <del>-I I</del>	(RB) REINOREFLECTIVE BACKPLATE
(P) POLE MOUNTED			RAILROAD FLASHING SIGNAL	XoX	I+I	
SERVICE INSTALLATION (G) GROUND MOUNTED (GM) GROUND MOUNTED METERED		© GM	RAILROAD CROSSING GATE	<del>Xox</del> >	1+2-	PEDESTRIAN SIGNAL HEAD
FELEPHONE CONNECTION	<b>E1</b>	E.	RALROAD CROSSBUCK	ъ	*	AT RAILROAD INTERSECTIONS
STEEL MAST ARM ASSEMBLY AND POLE	o	•	RAILROAD CONTROLLER CABINET		16-4E	PEDESTRIAN SIGNAL HEAD WITH COUNTDOWN TIMER
ALUMINUM MAST ARM ASSEMBLY AND POLE	<u>a</u>		UNDERGROUND CONDUCT (UC), GALVANIZED STEEL	<u> 27</u>		
STEEL COMBINATION MAST ARM ASSEMBLY AND POLE WITH LUMINAIRE	o <del>¤</del> —	•×	TEMPORARY SPAN WIRE, TETHER WIRE, AND CABLE	1	<del>6 6</del>	NO LEFT TURN I NO RIGHT TURN
SIGNAL POST (BM) BARREL MOUNTED - TEMPORARY	0	• • • BM	SYSTEM ITEM	5	SP	NUMBER OF CONDUCTORS, ELECTRIC CABLE NO, 14, UNLESS NOTED OTHERWIS
			INTERSECTION ITEM	1	IP	ALL DETECTOR LOOF CABLE TO BE SHIEL
NOOD FOLE	* ~	e ≻-	REMOVE ITEM		現日	GROUND CABLE IN CONDUIT, NO. 6 SOLID COPPER (GREEN)
SIGNAL HEAD	->	+	RELOCATE ITEM		RL	ELECTRIC CABLE IN CONDUIT, TRACER NO. 14 1/C
SIGNAL HEAD WITH BACKPLATE	+>	++-	ABANDON ITEM CONTROLLER CABINET AND		<u>^</u>	COAXIAL CABLE
SIGNAL HEAD OPTICALLY PROGRAMMED	-1> <sup>P</sup> +1> <sup>P</sup>	- <b>•</b> <sup>P</sup> + <b>•</b> <sup>P</sup>	FOUNDATION TO BE REMOVED		RCF	
LASHER INSTALLATION	0-1> <sup>1</sup> 0-1> <sup>15</sup>	••• <sup>F</sup> ••• <sup>F5</sup>	MAST ARM POLE AND FOUNDATION TO BE REMOVED		RMP	VENDOR CABLE
(FS) SOLAR POWERED	œ⊳ <sup>r</sup> œ⊳ <sup>FS</sup>	■→ <sup>1</sup> ■→ <sup>85</sup>	SIGNAL POST AND FOUNDATION TO BE REMOVED		RPF	COPPER INTERCONNECT CABLE, NO, 18, 3 PAIR TWISTED, SHIELDED
PEDESTRIAN SIGNAL HEAD	-0	<b>.</b>	DETECTOR LOOP, TYPE I			FIBER OFFIC CABLE •NO. 62.5/125, MM12F
PEDESTRIAN PUSH BUTTON (APS) ACCESSIBLE PEDESTRIAN PUSH BUTTON	😫 🏶 APS		PREFORMED DETECTOR LOOP	ē 0	0	<ul> <li>NO. 62.5/125, MM12F 5M12F</li> <li>NO. 62.5/125, MM12F 5M24F</li> </ul>
RADAR DETECTION SENSOR	<b>E</b> 1	3	SAMPLING (SYSTEM) DETECTOR	50	56	
/IDEO DETECTION CAMERA			INTERSECTION AND SAMPLING	E 6		
RADAR/VIDEO DETECTION ZONE		 ■	(SYSTEM) DETECTOR	1000 C 200	<u>a</u> (a)	GROUND ROD (C) CONTROLLER
	 		QUEUE AND SAMPLING (SYSTEM) DETECTOR	05 🚳	os (6)	(M) MAST ARM     (P) POST
AN, TILT, ZOOM (PTZ) CAMERA		<b>F</b> TZ <b>1</b>	WIRELESS DETECTOR SENSOR	0	0	(5) SERVICE
EMERGENCY VEHICLE LIGHT DETECTOR	∞		WIRELESS ACCESS POINT		-	
CONFINATION BEACON	<b>⊷</b> 0					
WRELESS INTERCONNECT	<del>∞-# </del>					
WIRELESS INTERCONNECT RADIO REPEATER.	ERE	RR				

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(	сіт	Y	0	F	LI	G	ΗТ	S

DESIGNED BY: RA	CHECKED BY: RG	SCALE:	SHEET TITLE
DRAWN BY:GIL/AH	APPROVED BY: RG	DATE: 7/2021	

MISCELLANEOUS STANDARD DETAILS

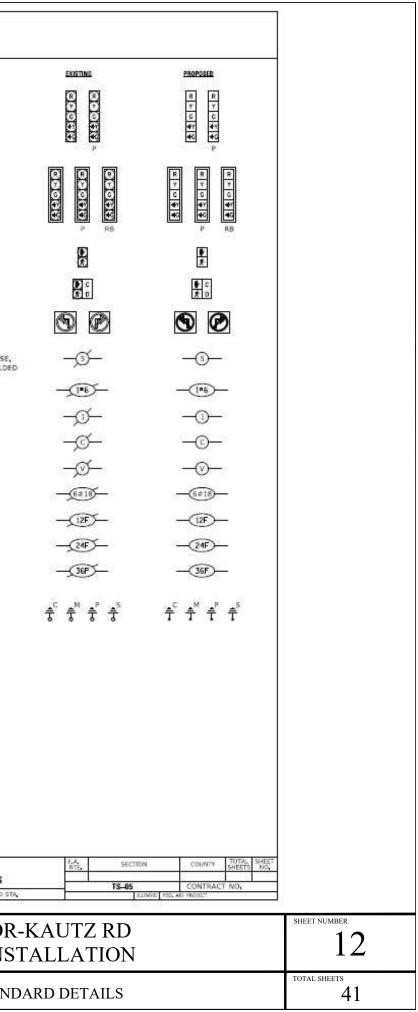

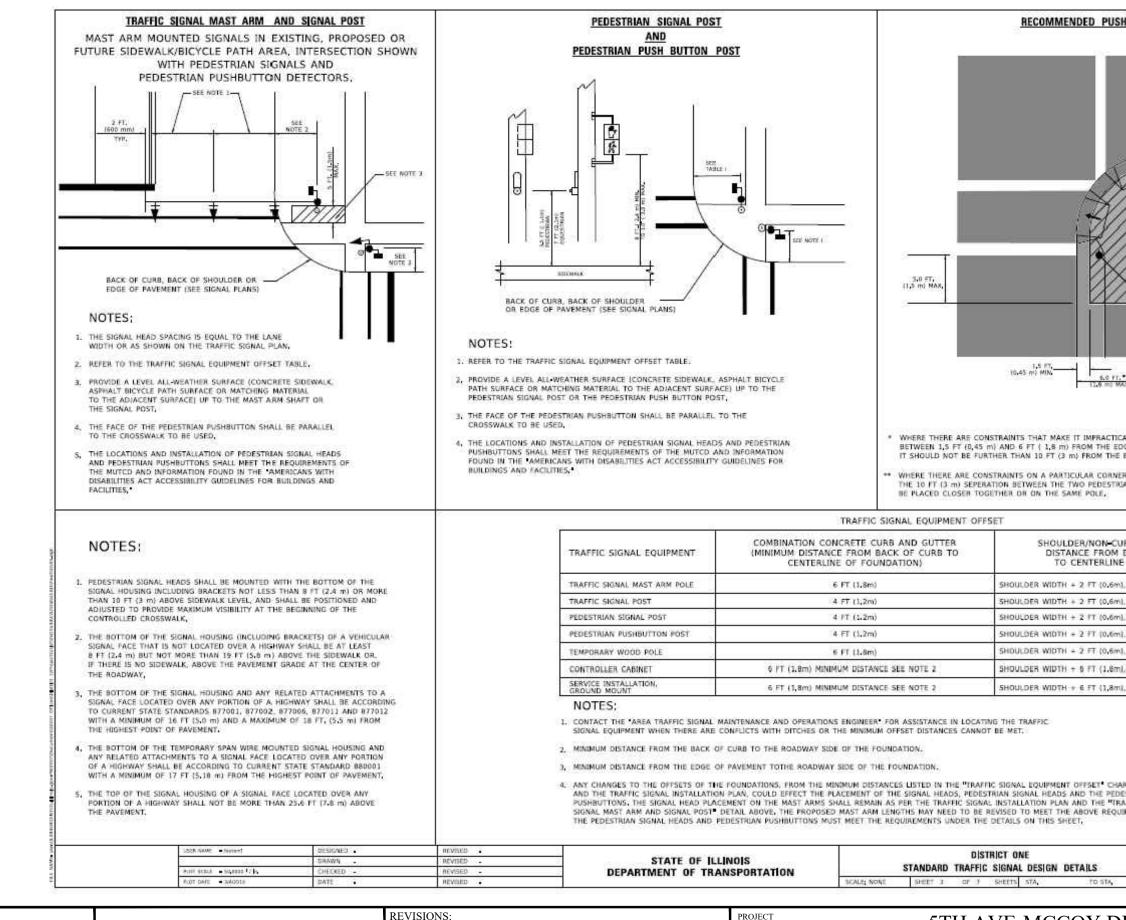



CITY OF LIGHTS


CITY OF AURORA ENGINEERING DIVISION 77 S. BROADWAY


			DECOMMENDED DUCUDUTTON LOCATIONS		
OR	PEDESTRIAN SIGNAL POST AND		RECOMMENDED PUSHBUTTON LOCATIONS		
SHOWN	PEDESTRIAN PUSH BUTTON POST		5/2 FT. (1.5 m) MAR.		
SEE NOTE 3	BACK OF CURA, BACK OF SHOULDER OR EDGE OF PAVEMENT (SEE SIGNAL PLANS)	5.0 FT, 1.5 m) MAX.	Lá PT. (0.45 TP) MNR. (1.6 m) MAR.		
	NOTES:				
	3. REFER TO THE TRAFFIC SIGNAL EQUIPMENT OFFSET TABLE.				
	<ol> <li>PROVIDE A LEVEL ALL WEATHER SURFACE (CONCRETE SIDEWALK, ASPHALT BICYCLE PATH SURFACE OR MATCHINS MATERIAL TO THE ADJACENT SURFACE) UP TO THE</li> </ol>		10.45 m/ MIN 1.8 = MAX, PEDESTRIAN PUSHBUTTON		
	PEDESTRIAN SIGNAL POST OR THE PEDESTRIAN PUSH BUTTON POST, 3. THE FACE OF THE PEDESTRIAN PUSHBUTTON SHALL BE PARALLEL TO THE		NECOMMENDED PUSIBUTION LOCATIONS		
	CROSSWALK TO BE USED.	* WHERE THERE ARE O	ONSTRAINTS THAT MAKE IT IMPRACTICAL TO PLACE THE PEDESTRIAN PUSHBUTTON		
	4. THE LOCATIONS AND INSTALLATION OF PEDESTRIAN SIGNAL HEADS AND PEDESTRIAN PUSHBUTTONS SHALL MEET THE REQUIREMENTS OF THE MUTCO AND INFORMATION	BETWEEN 1,5 FT (0,4)	S m) AND 6 FT (1,8 m) FROM THE EDGE OF THE CURB, SHOULDER, OR PAVEMENT, URTHER THAN 10 FT (3 m) FROM THE EDGE OF CURB, SHOULDER, OR PAVEMENT.		
	FOUND IN THE AMERICANS WITH DISABILITIES ACT ACCESSIBILITY GUIDELINES FOR BUILDINGS AND FACILITIES.		INSTRAINTS ON A PARTICULAR CORNER THAT MAKE IT IMPRACTICAL TO PROVIDE		
			RATION BETWEEN THE TWO PEDESTRIAN PUSHBUTTONS, THE PUSHBUTTONS MAY DEETHER DR ON THE SAME POLE.		
	TRAFF	IC SIGNAL EQUIPMENT OF	FSET		
	TRAFFIC SIGNAL EQUIPMENT COMBINATION CONCRETE (MINIMUM DISTANCE FROM CENTERLINE OF F	M BACK OF CURB TO	SHOULDER/NON-CURBED AREA (MINIMUM DISTANCE FROM EDGE OF PAVEMENT TO CENTERLINE OF FOUNDATION)		
UE .	TRAFFIC SIGNAL MAST ARM POLE 6 FT 11.3	im)	SHOULDER WIDTH + 2 FT (0.6m), MINIMUM 10 FT (3.0m)		
A2111	TRAFFIC SIGNAL POST 4 FT (1,2		SHOULDER WIDTH + 2 FT (0,6m), MINIMUM 10 FT (3,0m)		
a.a.	PEDESTRIAN SIGNAL POST 4 FT (1.2		SHOULDER WIDTH + 2 FT (0.6m), MINIMUM 10 FT (3.0m)		
NR	PEDESTRIAN PUSHBUTTON POST 4 FT (1.2	916 	SHOULDER WIDTH + 2 FT (0,6m), MINIMUM 10 FT (3,0m) SHOULDER WIDTH + 2 FT (0,6m), MINIMUM 10 FT (3,0m)		
2	TEMPORARY WOOD POLE 5 FT (1.8 CONTROLLER CABINET 5 FT (1.8m) MENIMUM DIS	NUT E MULTUR MARCINES AL DUR A	SHOULDER WIDTH + 6 FT (1.8m), MINIMUM 16 FT (4.9m) SEE NOTE 3.		
2	SERVICE INSTALLATION, GROUND MOUNT 6 FT (1,8m) MINIMUM DIST		5HOULDER WIDTH + 6 FT (1,8m), MINIMUM 16 FT (4,9m) SEE NOTE 3,		
A XNG	NOTES:		and and the second statement of the second		
12	<ol> <li>CONTACT THE "AREA TRAFFIC SIGNAL MAINTENANCE AND OPERATIONS ENGINE SIGNAL EQUIPMENT WHEN THERE ARE CONFLICTS WITH DITCHES OR THE MINI VIEW OF A STATEMENT AND A STATEMENT A STATEMENT AND A STATE</li></ol>	MUM OFFSET DISTANCES CANN			
р 1	2. MINIMUM DISTANCE FROM THE BACK OF CURB TO THE ROADWAY SIDE OF THI				
	3, MINIMUM DISTANCE FROM THE EDGE OF PAVEMENT TOTHE ROADWAY SIDE OF				
	4. ANY CHARGES TO THE OFFSETS OF THE FOUNDATIONS, FROM THE MIXMUM C AND THE TRAFFIC SIGNAL INSTALLATION PLAN, COULD EFFECT THE PLACEMEN PUSHBUTTONS, THE SIGNAL HEAD PLACEMENT ON THE MAST ARMS SHALL REI SIGNAL MAST ARM AND SIGNAL POST® DETAIL ABOVE, THE PROPOSED MAST THE PEDESTRIAN SIGNAL HEADS AND PEDESTRIAN PUSHBUTTONS MUST MEET	T OF THE SIGNAL HEADS, PEDI MAIN AS PER THE TRAFFIC SIGN RM LENGTHS MAY NEED TO BI	ESTRIAN SIGNAL HEADS AND THE PEDESTRIAN NAL INSTALLATION PLAN AND THE "TRAFFIC E REVISED TO MEET THE ABOVE REQUIREMENTS,		
	INVERD . STATE OF HUBBOR	D	STRICT ONE F.A. SECTION COUNTY TOTAL SHEET NO.		
	REVISED - STATE OF ILLINOIS REVISED - DEPARTMENT OF TRANSPORTATION	CONTRACTOR AND A DATA A	IC SIGNAL DESIGN DETAILS TS-05 CONTRACT NO.		
	REVERD . SCALE	NONE SHEET I OF I	SHEETS STA, TO STA, BLIMUE FUS, AD PRODUCT		
REVISIO	NS: PROJECT	entra d		SHEET NUMBER	
			AVE-MCCOY DR-KAUTZ RD	12	
		TRAF	FIC SIGNAL INSTALLATION		
DESIGNE	ED BY: RA CHECKED BY: RG SCALE: SHEET TITLE			TOTAL SHEETS	
DRAWN	RAWN BY:GIL/AH APPROVED BY: RG DATE: 7/2021 MISCELLANEOUS STANDARD DETAILS 41				

SHEET NUMBER
TOTAL SHEETS
41

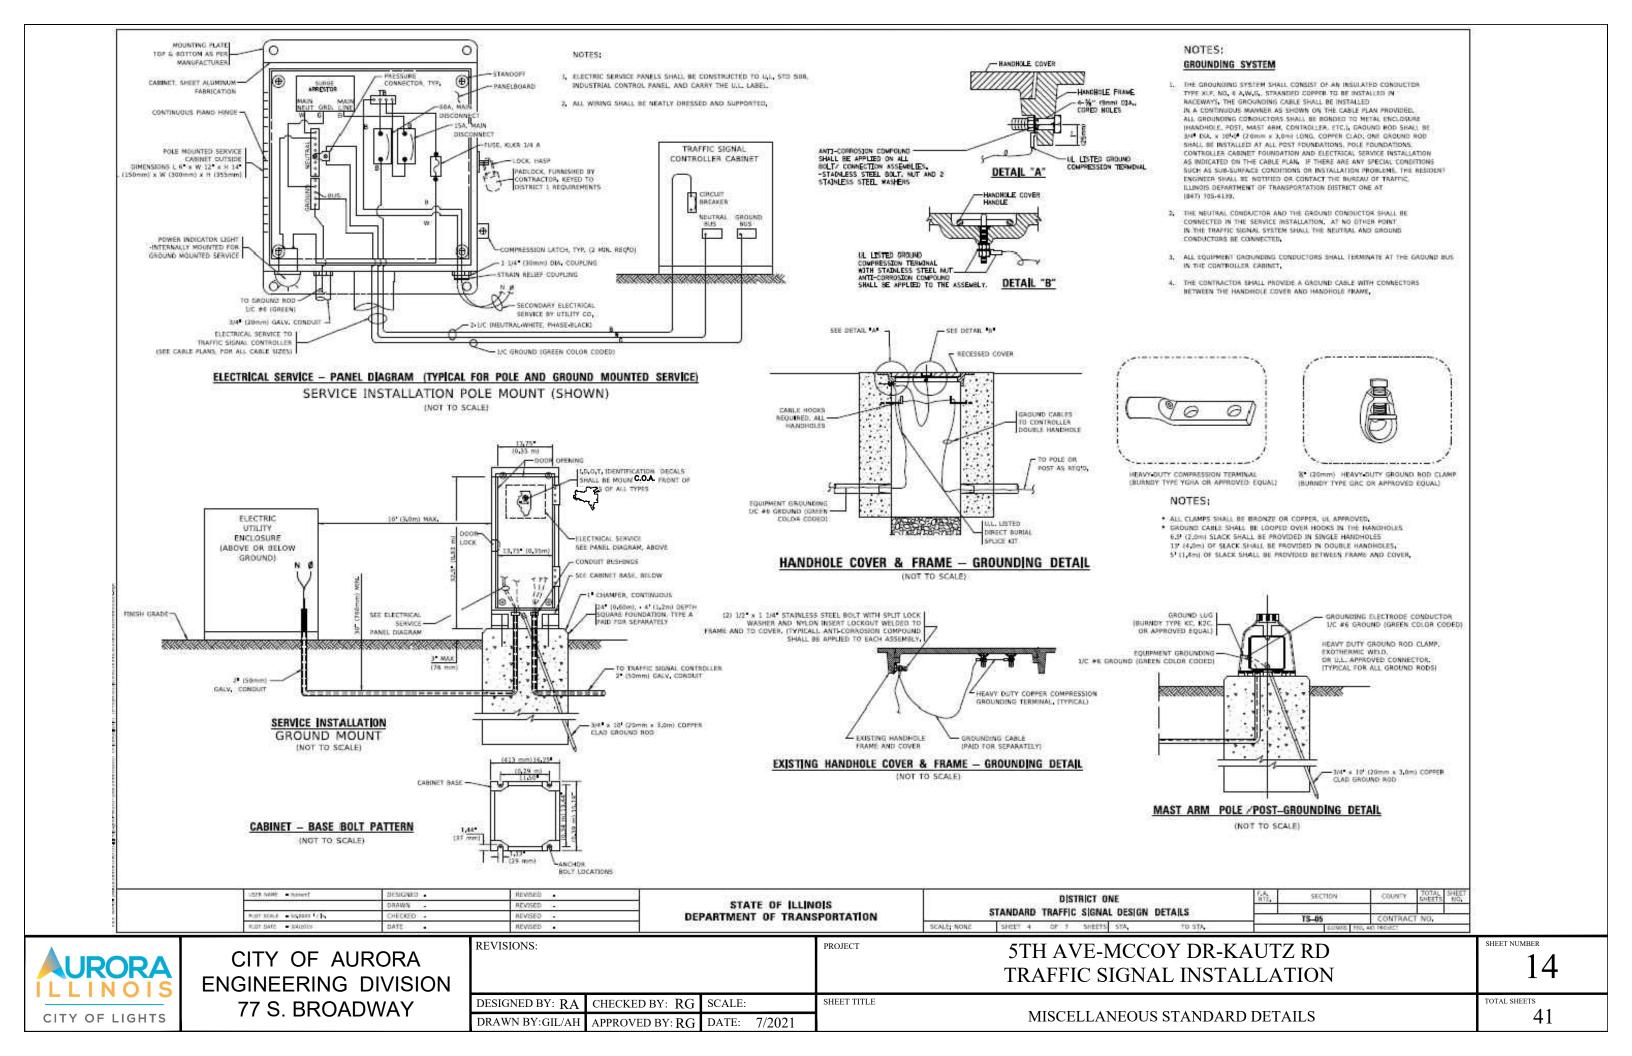

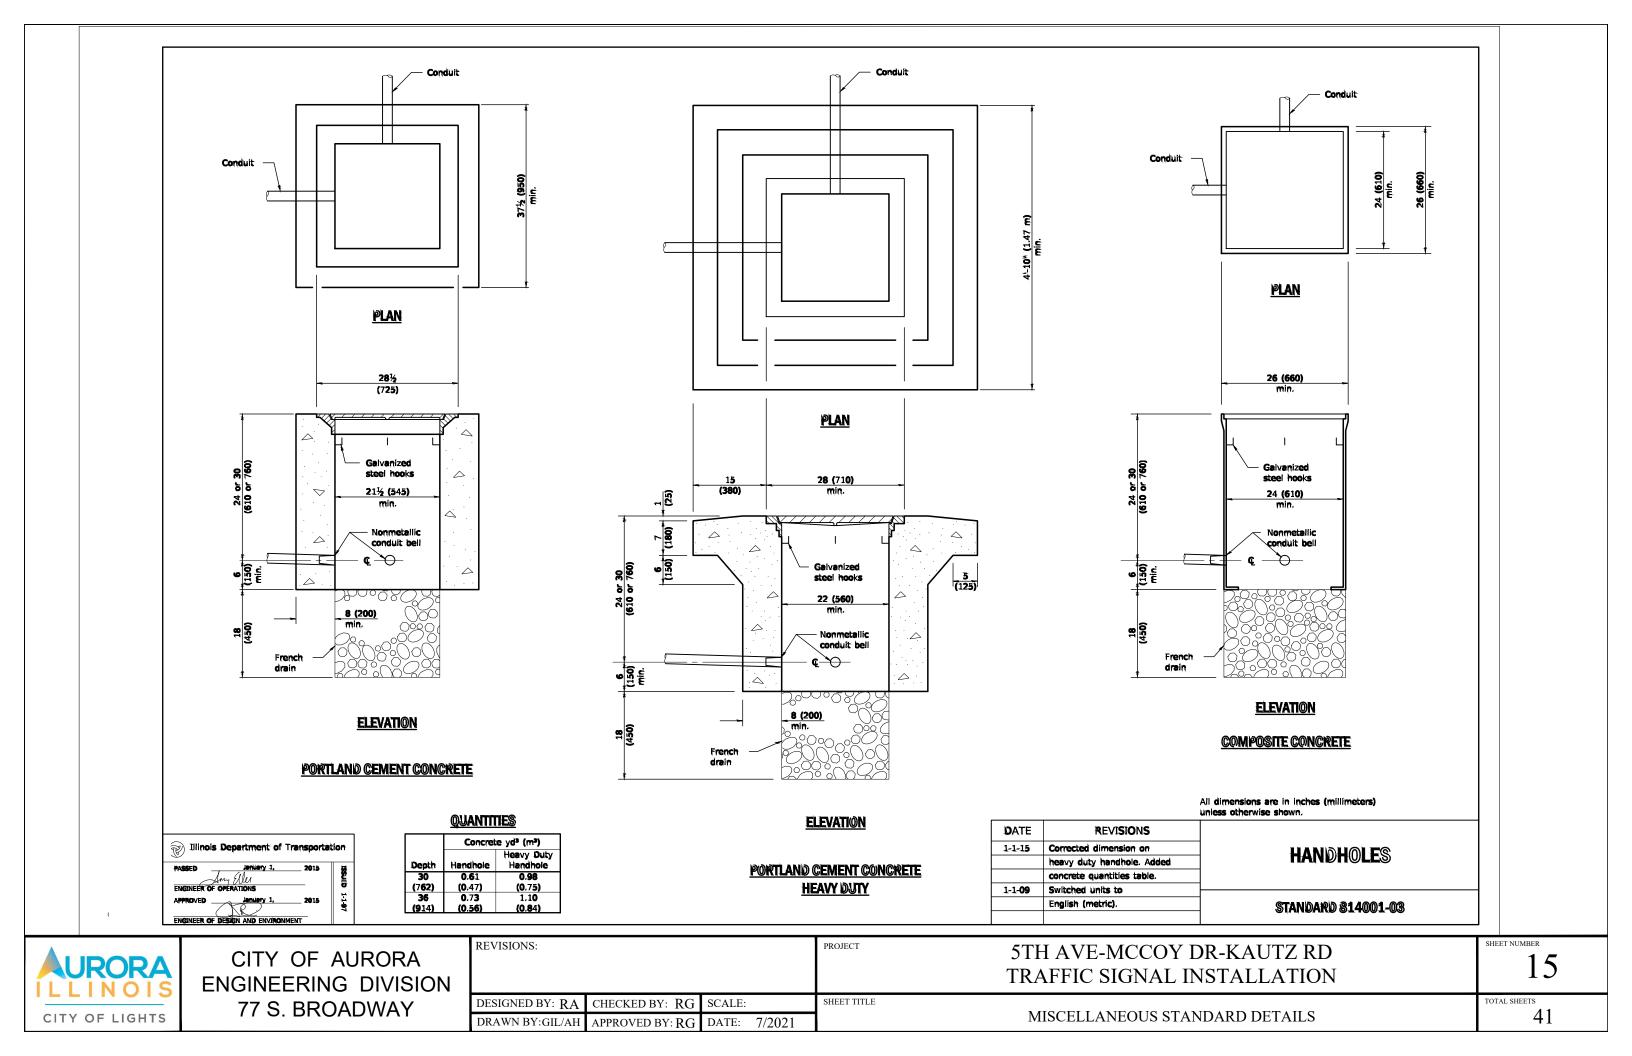


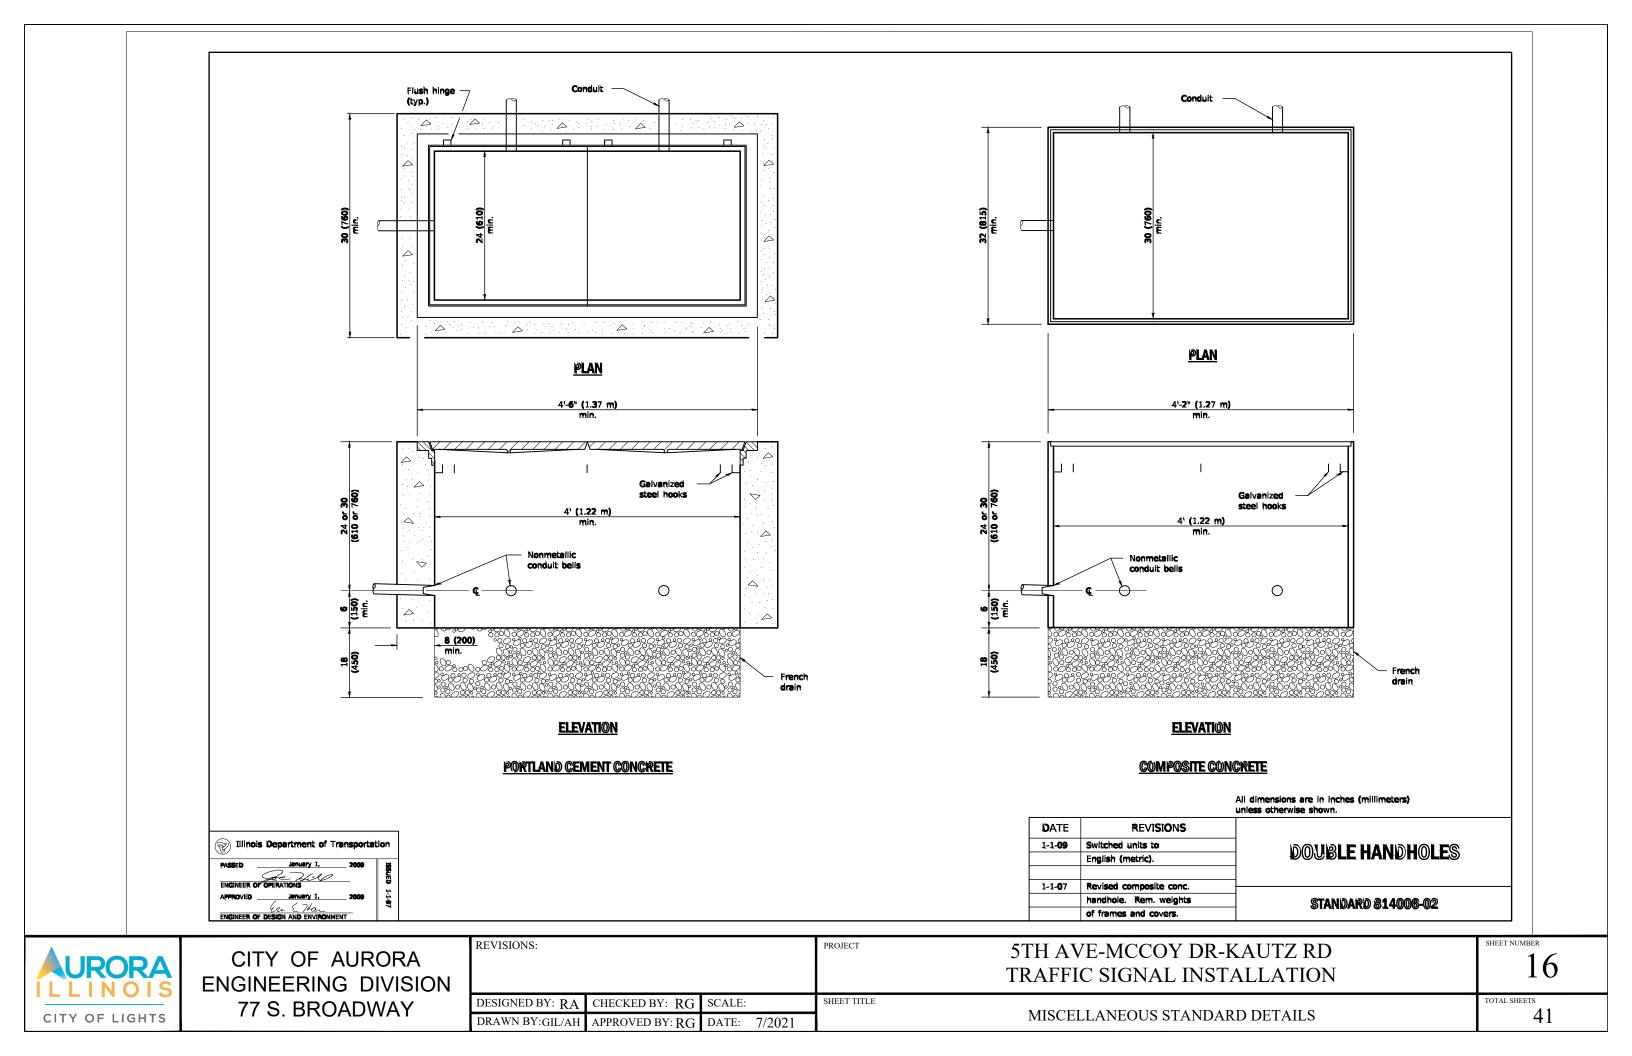

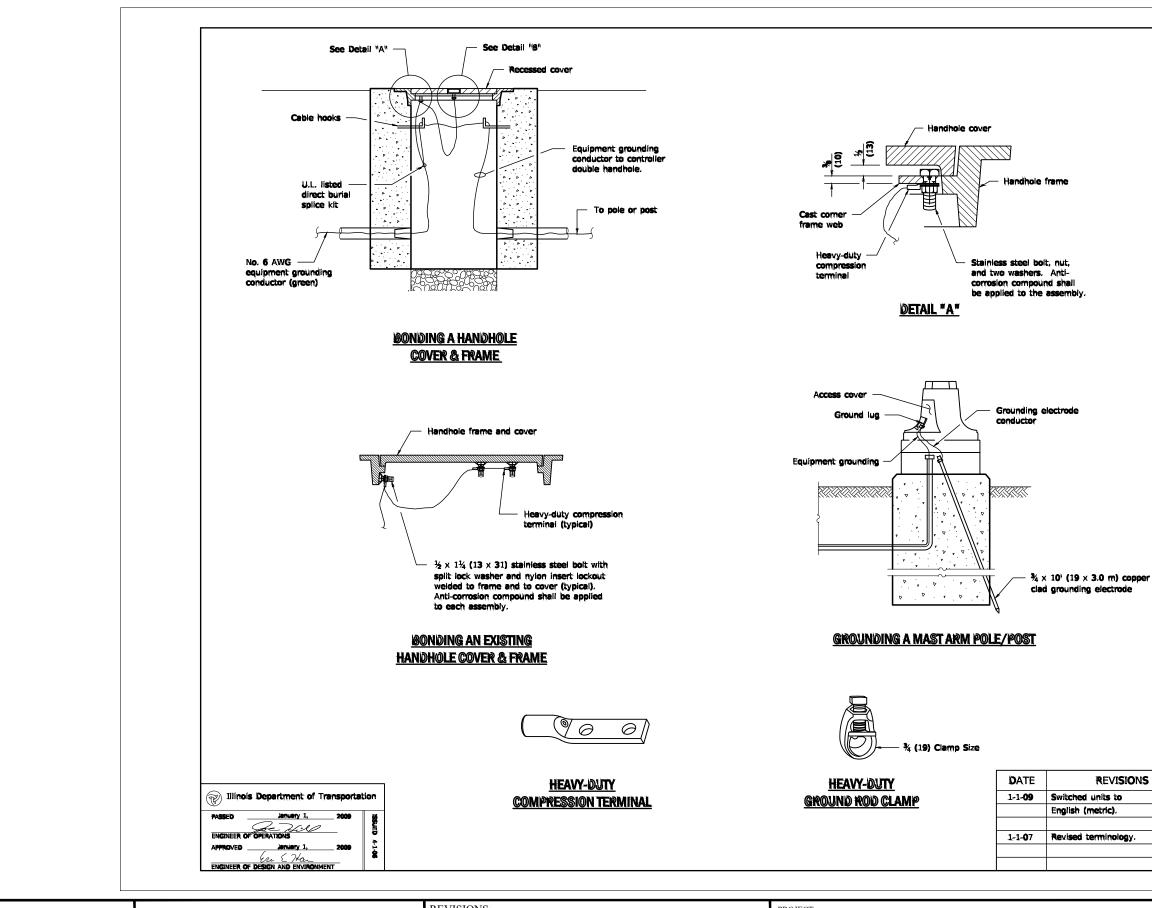

	CITY OF AURORA ENGINEERING DIVISION	REVISIONS:	REVISIONS:			5TH AVE-MCCOY D TRAFFIC SIGNAL IN
	77 S. BROADWAY	DESIGNED BY: RA	CHECKED BY: RG	SCALE:	SHEET TITLE	
CITY OF LIGHTS	TT 6. BROADWAT	DRAWN BY:GIL/AH	APPROVED BY: RG	DATE: 7/2021		MISCELLANEOUS STAN

	Al dimensions are in inches (millimeters) uncess otherwise shown.	
NSTA	AUTZ RD LLATION DETAILS	SHEET NUMBER 17 TOTAL SHEETS 41
		41

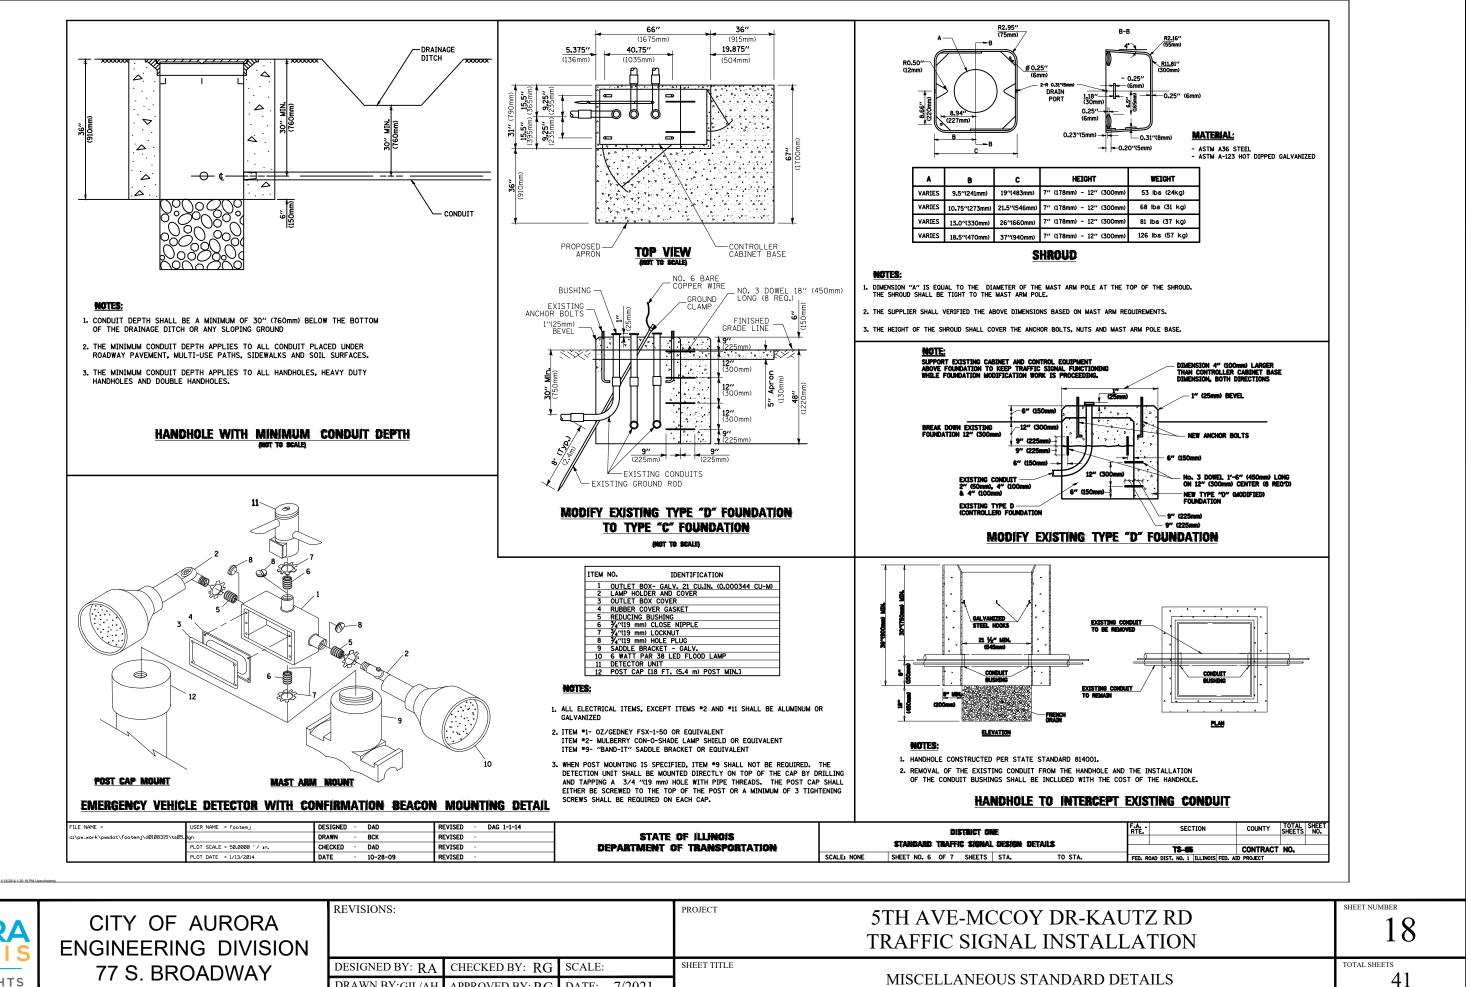

	CITY OF AURORA ENGINEERING DIVISION	REVISIONS:			PROJECT	5TH AVE-MCCOY D TRAFFIC SIGNAL IN
	77 S. BROADWAY	DESIGNED BY: RA	CHECKED BY: RG	SCALE:	SHEET TITLE	
CITY OF LIGHTS		DRAWN BY:GIL/AH	APPROVED BY: RG	DATE: 7/2021		MISCELLANEOUS STAN

TPE D FOR GROUND MOUNTED CONTROLLER CABINET AND UPS BATTERY CABINET	*** (100mmil COMOUIT #       5375*       1055mmil       19875*       1915mmil         *** (100mmil COMOUIT #       5375*       10035mmil       1504mmil       1504mmil         *** (100mmil COMOUIT #       5375*       10035mmil       1504mmil       1504mmil         *** (100mmil COMOUIT #       ***       10035mmil       1504mmil       1504mmil       1504mmil         ***       ***       ***       ***       ***       ***       ***       ***         ****       ****       ****       ****       ****       ****       ****       ****       ****       *****       *****       *****       *****       *****       *****       ******       ********       ************************************	THE THE INTER INTER<
EXAMPLES AT CABINET     13.0     4.0       ELECTRIC AT CABINET     13.0     4.0       ELECTRIC SERVICE AT ICABINET OR SERVICE LOCATION     1.5     0.5       GROUND CABLE ISTONAL POST, MAST ARM, CABINET     1.5     0.5       GROUND CABLE INSTALL POST, MAST ARM, CABINET     1.5     0.5       GROUND CABLE INSTALL POST, MAST ARM, CABINET     5.0     1.6       CABLE SLACK     SERVICE DISTALLATION FOLE MOUNT SERVICE DISTALLATION FOLE FOLINDATION ISJONAL POST, MAST A MOUNT SERVICE DISTALLATION FOLE FOLINDATION ISJONAL POST, MAST A MOUNT SERVICE SERVICE DISTALLATION FOLE FOLINDATION ISJONAL POST, MAST A MOUNT SERVICE DISTALLATION FOLE FOLINDATION ISJONA	E. TO: STONAL HEAD FROM END OF ARMI     20.0HL     6.0HL       E. OR. STGMAL POLEI     13.0     4.0       AT: TO: SERVICE DROP     13.5     4.1       TT TO: SERVICE DROP     13.5     4.1       TT TO: GROUND     13.5     4.1       TO: SERVICE DROP     13.5     4.1       TT TO: GROUND     13.5     4.1       TT TO: SERVICE DROP     13.5     4.1       TT TO: GROUND     13.5     4.1       TT TO: SERVICE DROP     13.0     1.0	4"-0" (1,2m)         56" (15,8 m) on teas than         21" to the million of teas than         21" to the million of teas than         16" to the million of teas than
ENGINEERING DIVISION	GNED BY: RACHECKED BY: RGSCALE:SHEET TITLEWN BY:GIL/AHAPPROVED BY: RGDATE: 7/2021SHEET TITLE	TRAFFIC SIGNAL INSTALLATION MISCELLANEOUS STANDARD DETAILS

#### RD DETAILS

### -KAUTZ RD **FALLATION**

TOTAL SHEETS

41

SHEET NUMBER

	FA-	SECTION	COUNTY	TOTAL	SHEET NO.			
		TS-05	CONTRACT NO.					
A,	FED. R040	FED. ROKE DEST. NO. 1 JULINOES FED. AD PROJECT						

Anim	TOUNDA	10145, 111					
	F.	SECTION	COUNTY	TOTAL	SHEET NO.		
		TS-05	CONTRAC	CONTRACT NO.			
A	FED. ROAD DEST. NO. 1 BLIDNOES FED. AD PROJECT						


ARM	FOUNDATIONS, TYPE E								
	[4]	SECTION	COUNTY	TOTAL	SHEET NO.				
		TS-05	CONTRAC	T NO.	-				
A.	FED. 8040 0	CST. NO. 1 DLLINGES FT	TRUCK GA JO		_				


er to sto	te standord f	175001_			
ARM	FOUNDA	TIONS, TYP	<u>e e</u>		
	F.A.	SECTION	COUNTY	TOTAL	SHEET NO.
		TS-05	CONTRACT	NO.	in in

ARM	FOUNDA	FOUNDATIONS, TYPE E								
	F.	SECTION	COUNTY	TOTAL	SHEET NO.					
		TS05	CONTRACT	NO.						


otion ath	Foundation Digneter			Size of Reports
1.0 mi	30" (750mm)	24" (600mm)	8	64199
Li mi	30" (750mm)	24" (600mm)	8	64191
(4 m)	36" (900mm)	30" (750mm)	12	7(22)
1,0 mi	36" (900mm)	30 <sup>10</sup> (750mm)	12	7(22)
,6 m)	36" (900mm)	30" (750mm)	12	7(22)
id mi	42" (1050mm)	36" (900mm)	16	8(25)
7.6 mi	42" (1060mm)	36" (900mm)	16	8/251

### AL CONTROLLER PLATFORM

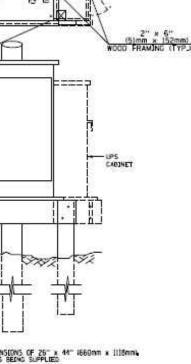

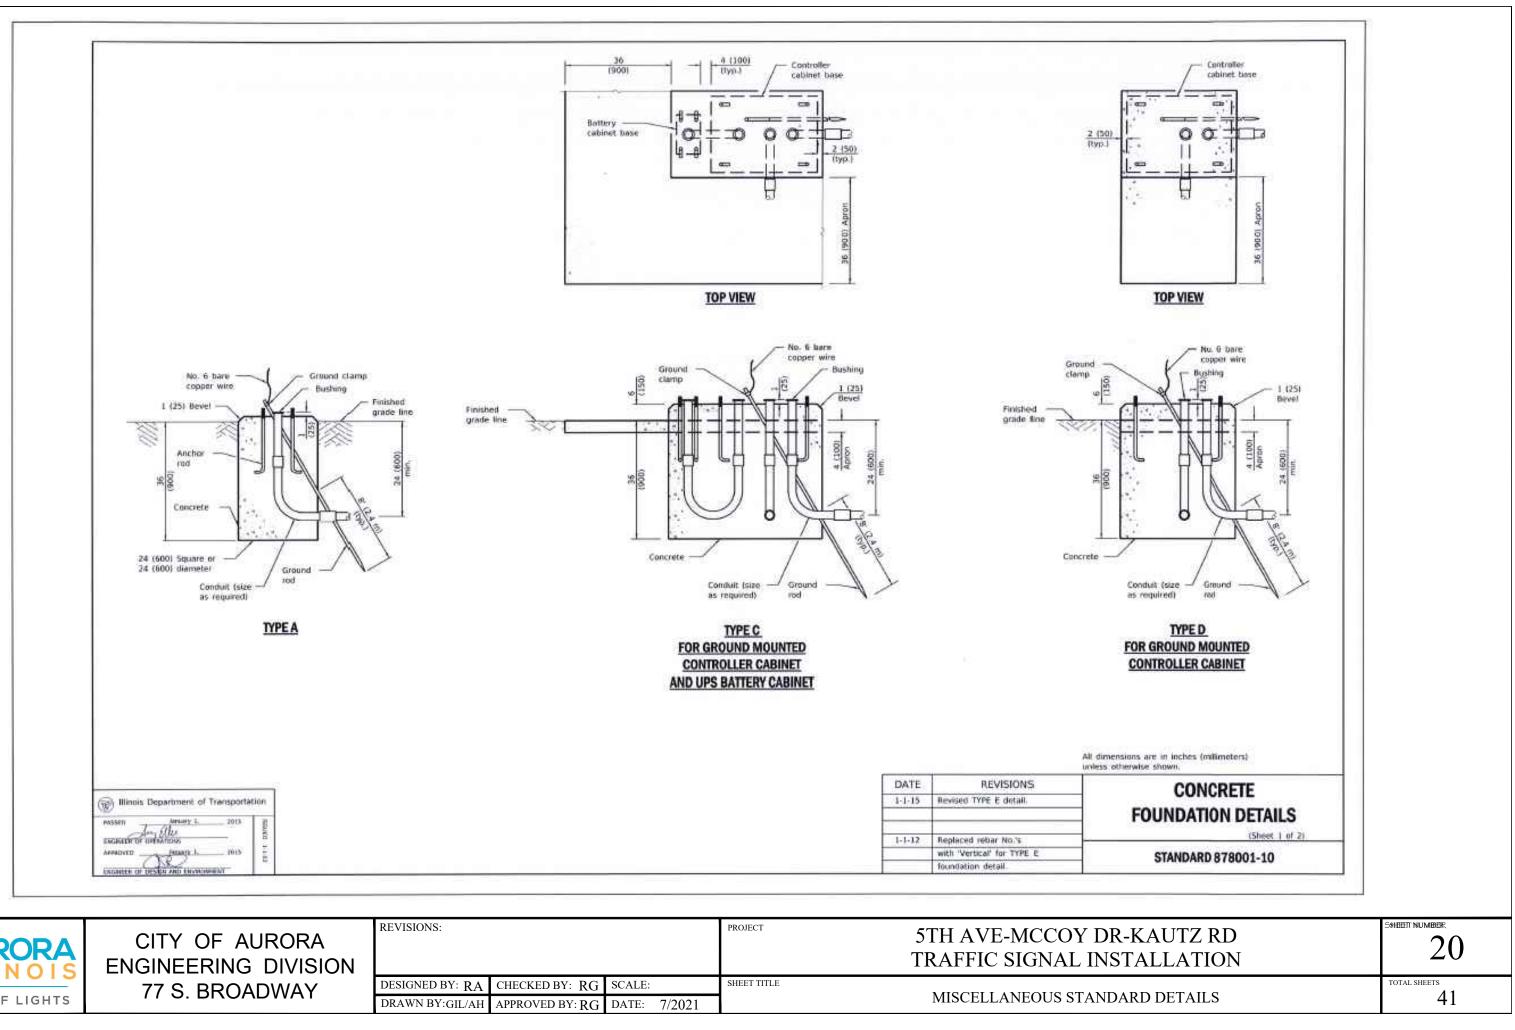

	CITY OF AURORA ENGINEERING DIVISION	REVISIONS:			PROJECT	5TH AVE-MCCOY DF TRAFFIC SIGNAL INS
	77 S. BROADWAY	DESIGNED BY: RA	CHECKED BY: RG	SCALE:	SHEET TITLE	
CITY OF LIGHTS		DRAWN BY:GIL/AH	APPROVED BY: RG	DATE: 7/2021		MISCELLANEOUS STAND

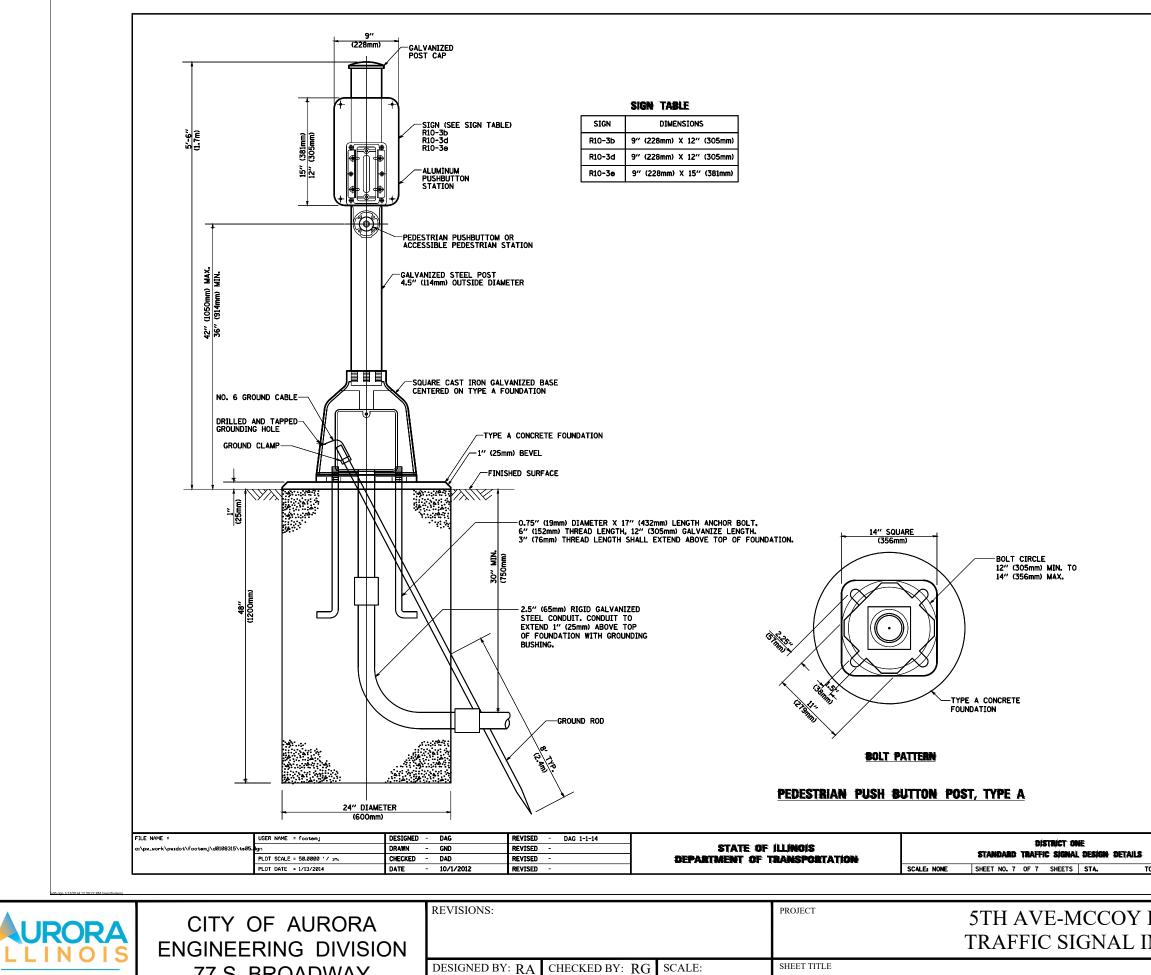


DRAWN BY:GIL/AH APPROVED BY: RG DATE: 7/2021

77 S. BROADWAY

CITY OF LIGHTS

MISCELLANEOUS STAN

F.A. SECTION COUNTY TOTAL SHEET NO.	
TS-05 CONTRACT NO.	
STA. FED. ROAD DIST. NO. I  ILLINOIS FED. ALD PROJECT	
	SHEET NUMBER
DR-KAUTZ RD	21
NSTALLATION	
	TOTAL SHEETS
NDARD DETAILS	41

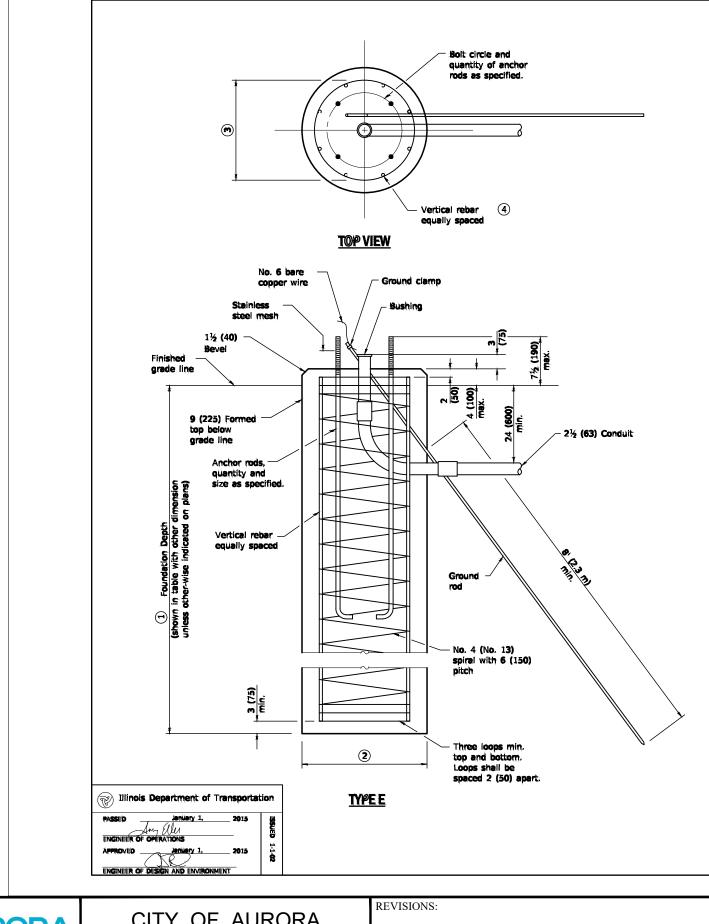

Mast Arm Length	1 Foundation Depth *	2 Foundation Diameter	3 Spiral Diameter	(4) Quantity of Rebars	Size of Rebars
Less than 30' (9.1 m)	10'-0" (3.0 m)	30 (750)	<b>24 (600)</b>	8	6 (19)
Greater than or equal	13'-6" (4.1 m)	30 (750)	24 (600)	8	6 (19)
to 30' (9.1 m) and less than 40' (12.2 m)	11'-0" (3.4 m)	36 (900)	<b>30 (</b> 750)	12	7 (22)
Greater than or equal to 40' (12.2 m) and less than 50' (15.2 m)	13'-0" (4.0 m)	36 (900)	<b>30 (</b> 7 <b>50)</b>	12	7 <b>(22)</b>
Greater than or equal to 50' (15.2 m) and up to 55' (16.8 m)	15'-0" (4.6 m)	36 (900)	30 (750)	1 <b>2</b>	7 <b>(22)</b>
Greater than or equal to 56' (16.8 m) and less than 65' (19.8 m)	21'-0" (6.4 m)	42 (1060)	36 (900)	16	8 (25)
Greater than or equal to 65' (19.8 m) and up to 75' (22.9 m)	25'-0" (7.6 m)	42 (1060)	36 (900)	16	8 (25)

\* For standard and combination mast arm assemblies. Foundation depths for standard dual mast arms with the longest arm length upto and including 55' (16.8 m) shall be increased by 1' (0.3 m) of that shown in the table, based on the longer of the two arms.

These foundation depths are for sites which have cohesive soils (clayey silt, sandy clay, etc.) along the length of the shaft, with an average Unconfined Compressive Strength (Qu) > 1.0 tsf (100 kpa). This strength shall be verified by boring data prior to construction or with testing by the Engineer during foundation drilling. The Bureau of Bridges & Structures should be contacted for a revised design if other conditions are encountered.

	CITY OF AURORA ENGINEERING DIVISION	REVISIONS:			PROJECT	5TH AVE-MCCOY DR TRAFFIC SIGNAL INS
	77 S. BROADWAY	DESIGNED BY: RA	CHECKED BY: RG	SCALE:	SHEET TITLE	
CITY OF LIGHTS		DRAWN BY:GIL/AH	APPROVED BY: RG	DATE: 7/2021		MISCELLANEOUS STANE

## CONCRETE FOUNDATION DETAILS

(Sheet 2 of 2)


### standard 878001-10

DR-KAUTZ RD


sheet number


NDARD DETAILS


TOTAL SHEETS 41

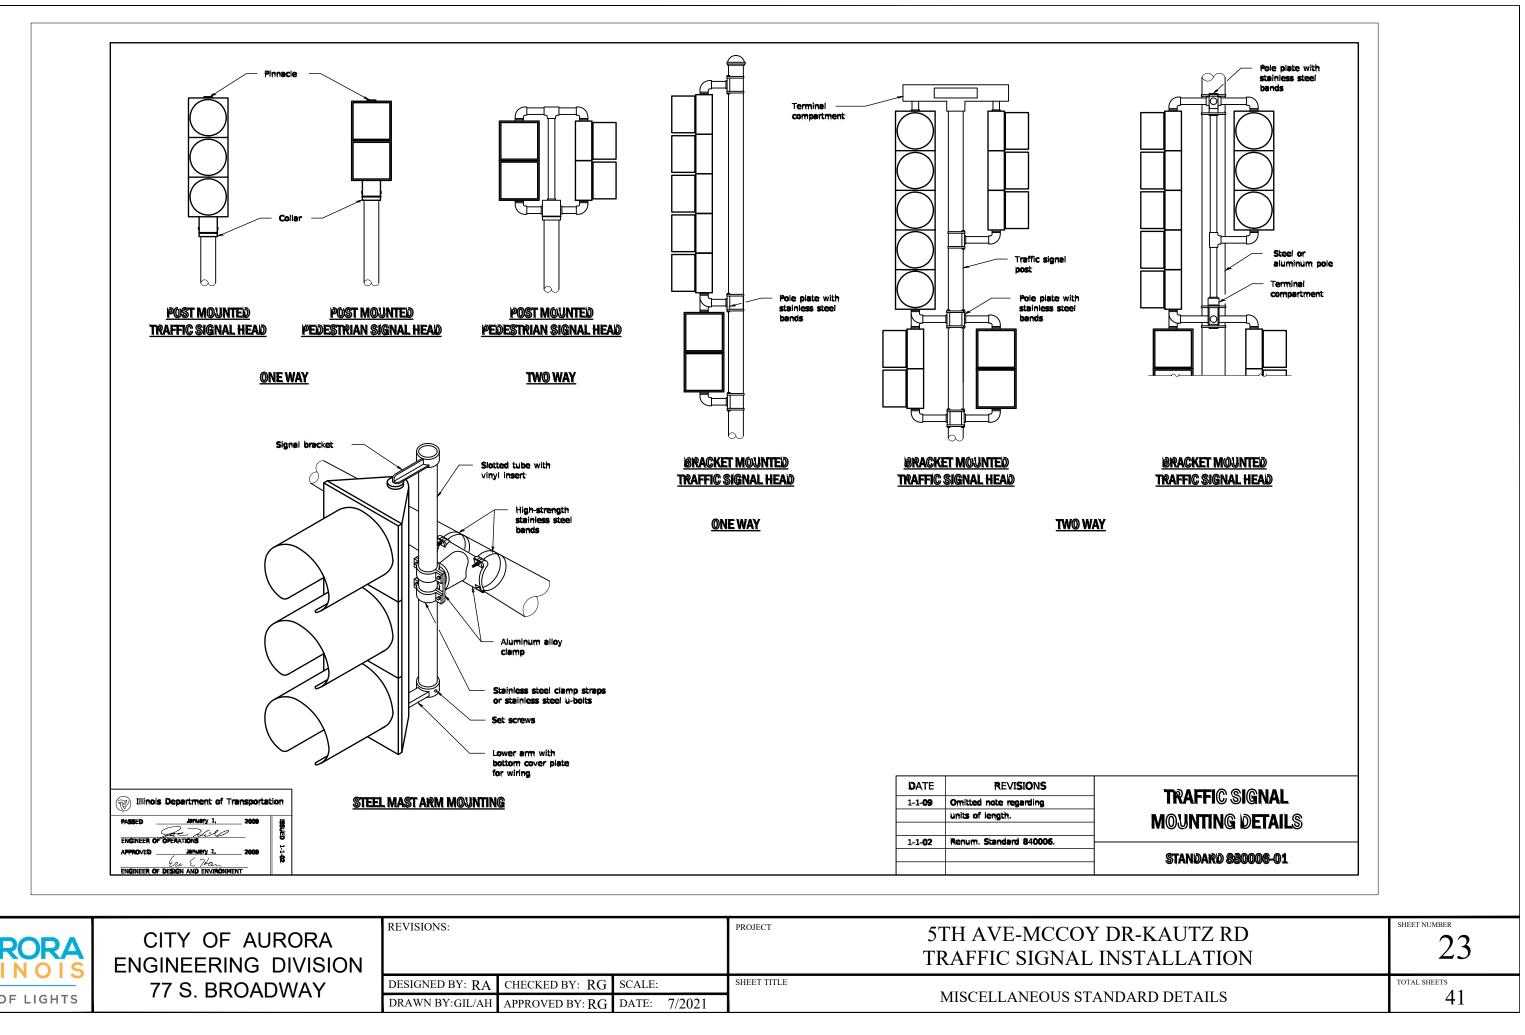

	CITY OF AURORA ENGINEERING DIVISION	REVISIONS:				PROJECT	5TH AVE-MCCOY D TRAFFIC SIGNAL IN
	77 S. BROADWAY	DESIGNED BY: RA	CHECKED BY: RG	SCALE:		SHEET TITLE	
CITY OF LIGHTS		DRAWN BY:GIL/AH	APPROVED BY: $RG$	DATE:	7/2021		MISCELLANEOUS STANE

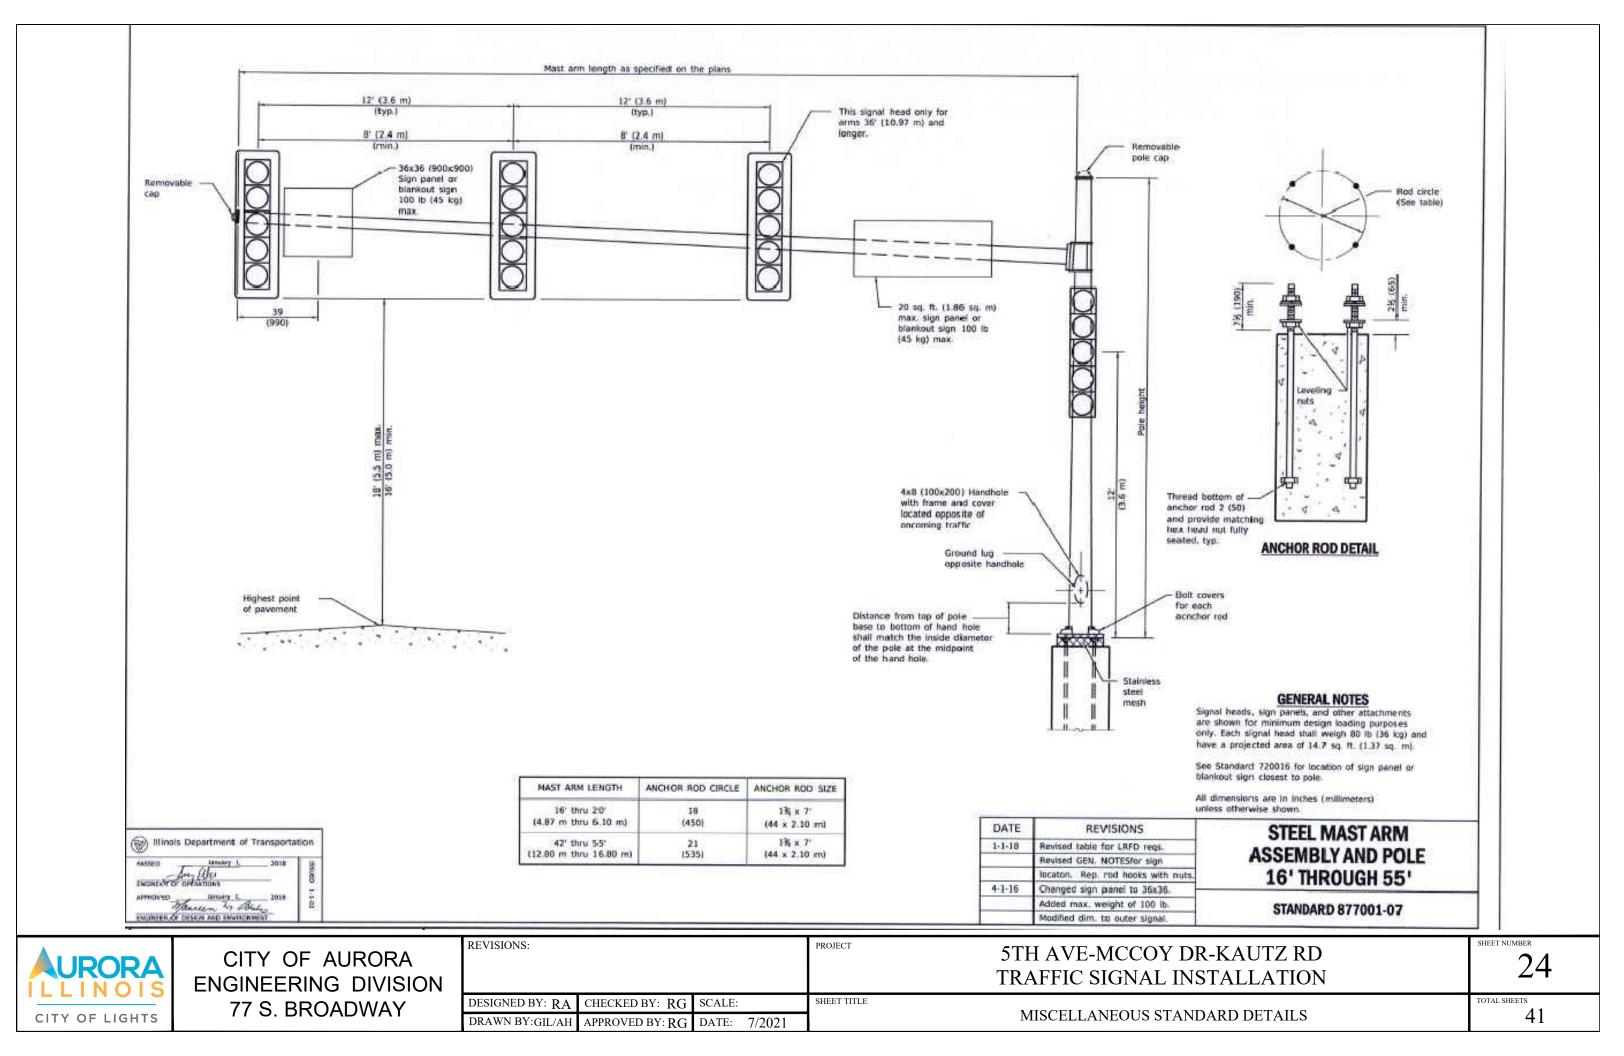

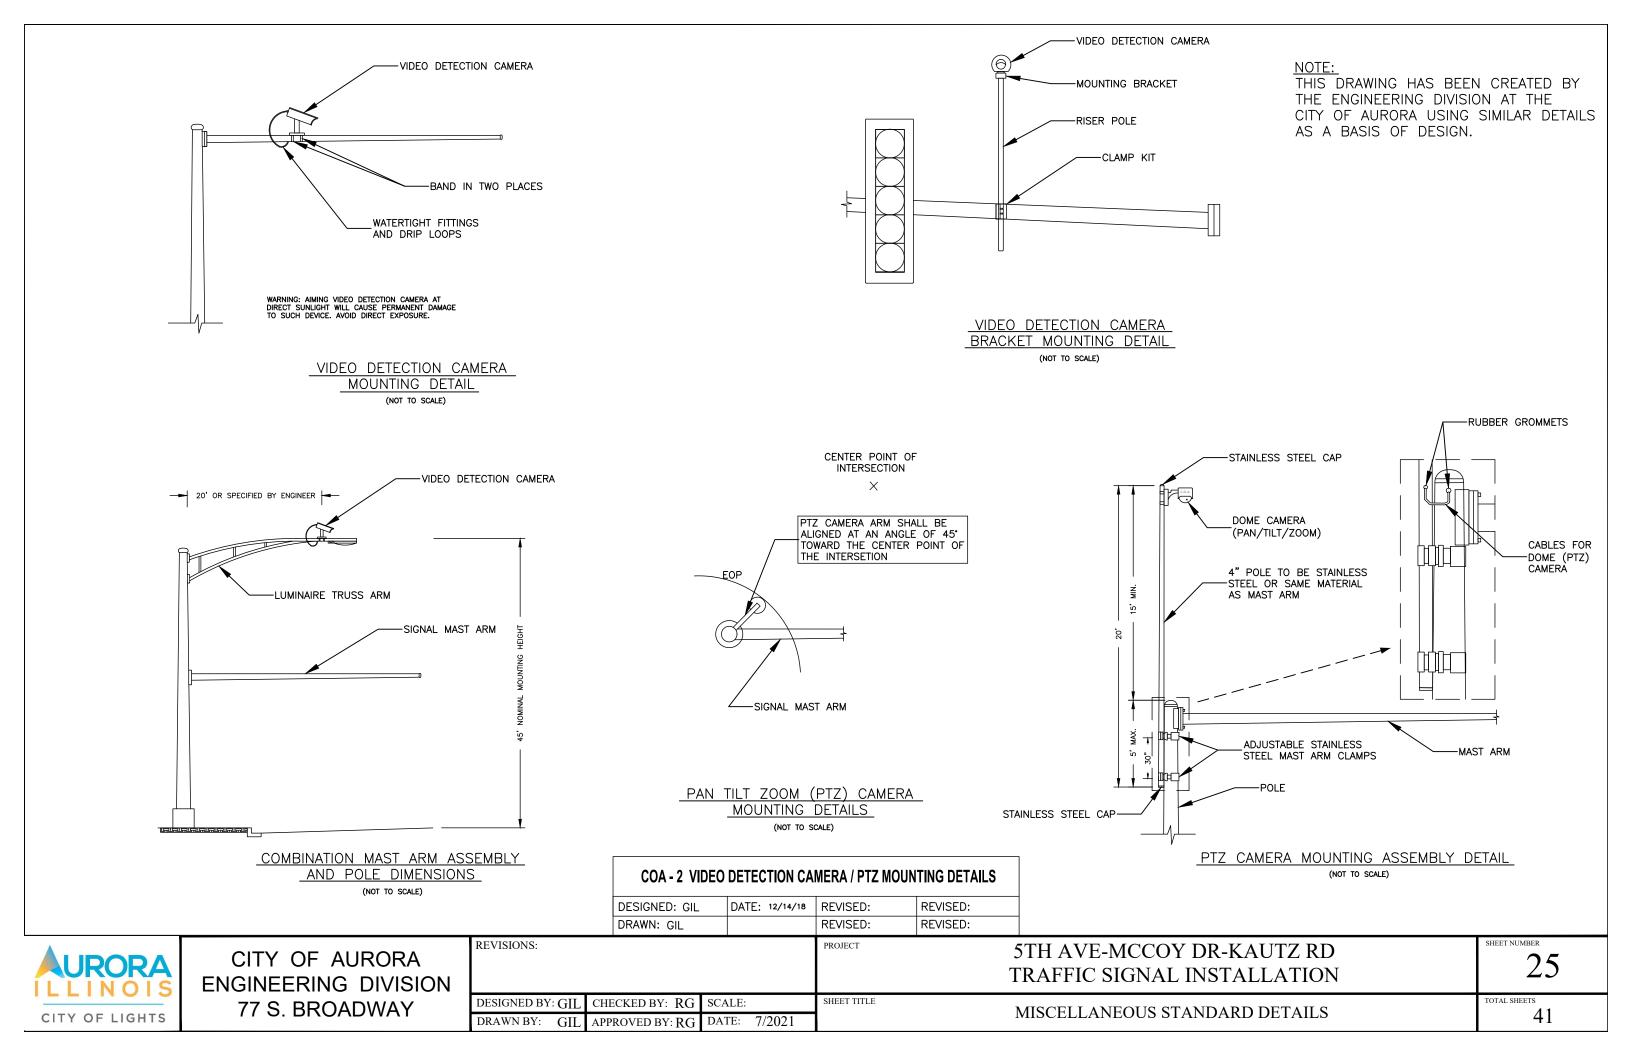

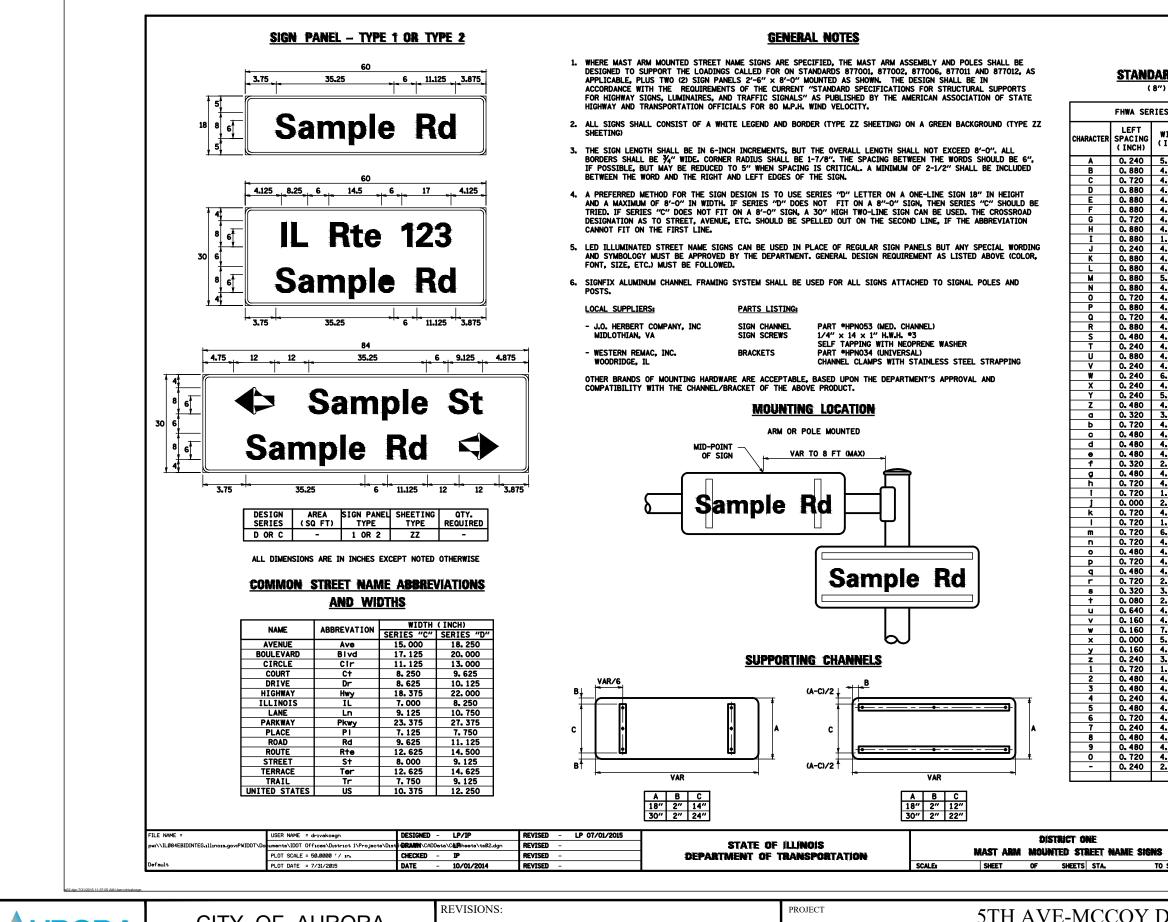

	CITY OF AURORA ENGINEERING DIVISION	REVISIONS:			PROJECT	5TH AVE-MCCOY TRAFFIC SIGNAL
	77 S. BROADWAY	DESIGNED BY: RA	CHECKED BY: $RG$	SCALE:	SHEET TITLE	
CITY OF LIGHTS		DRAWN BY:GIL/AH	APPROVED BY: RG	DATE: 7/2021		MISCELLANEOUS ST.

#### STANDARD ALPHABETS SPACING CHART

(8") UPPER CASE AND (6") LOWER CASE

IDTH	RIGHT				
	SPACING (INCH)	CHARACTER	LEFT SPACING (INCH)	WIDTH (INCH)	RIGHT SPACING (INCH)
. 122	0.240	A	0.240	6.804	0.240
. 482	0.480	B	0.960	5.446	0.400
<u>. 482</u> . 482	0. 720	C D	0.800	5.446 5.446	0.800
. 082	0. 480	Ē	0.960	4. 962	0.400
. 082	0.240	F	0.960	4.962	0.240
482	0.720	G	0.800	5.446	0.800
482	0.880	H	0.960	5.446 1.280	0.960
082	0.880	J	0. 380	5.122	0. 960
482	0.480	K	0.960	5.604	0.400
082	0.240	L	0.960	4.962	0.240
. 284 . 482	0.880	M	0.960	6.244 5.446	0.960
. 722	0.880	0	0. 960	5.446 5.684	0.960
482	0.720	P	0.960	5.446	0.240
722	0.720	Q	0.800	5.684	0.800
482	0.480	R	0.960	5.446	0.400
482	0.480	S T	0.400	5.446 4.962	0.400
482	0. 240	U	0. 240	4. 962 5. 446	0. 240
962	0.240	V	0.240	6. 084	0.240
084	0.240	W	0.240	7.124	0.240
722	0.240	X	0.400	5.446	0.400
122 482	0.240	Y Z	0.240	6.884 5.446	0.240
842	0. 640	<u>د</u>	0.400	4. 562	0. 720
082	0.480	Ь	0.800	4.802	0.480
002	0.240	c	0.480	4. 722	0.240
082 082	0. 720	d	0.480	4.802 4.722	0.800
480	0. 160	e f	0. 320	2.882	0.320
082	0.720	ġ	0.480	4.802	0.800
082	0.640	ĥ	0.800	4.722	0. 720
120	0.720	1	0.800	1.280	0.800
320 322	0.720	J k	0.000	2.642 5.122	0.800
120	0.720	Î	0.800	1.280	0.800
724	0.640	m	0.800	7.926	0.720
082	0.640	n	0.800	4. 722	0.720
082	0.480	0	0.480	4.882	0.480
082	0. 720	Q Q	0. 480	4.802	0.800
642	0.160	r	0.800	3.042	0.160
362	0.240	8	0. 320	3. 762	0.240
882	0.080	+	0.080	3.202	0.080
082 722	0.720	u V	0.720	4.722 5.684	0.800
524	0.160	w	0.160	9.046	0.160
202	0.000	×	0.000	6.244	0.000
962	0.160	У	0.160	6.004	0.160
362 680	0.240	2 1	0.240	4.002	0.240
482	0.880 0.480	1 2	0.800	2.000 5.446	0.960
482	0.480	3	1. 440	5. 446	0.800
962	0. 720	4	0.160	6.004	0.960
482	0.480	5	0.800	5.446	0.800
482 482	0. 720	6 7	0.800	5.446 5.446	0.800
482	0. 120	8	0.800	5. 446	0. 800
482	0.480	9	0.800	5.446	0.800
	0. 720	0	0.800	5.684	0.800
722	0.240		0.240	2.802	0.240

	F.A. RTÉ.	SECTION	COUNTY	TOTAL Sheets	SHEET NO.
		TS-02	CONTRACT	NO.	
STA.		ILLINOIS FED. AI	D PROJECT		

### DR-KAUTZ RD INSTALLATION

26

SHEET NUMBER


TOTAL SHEETS


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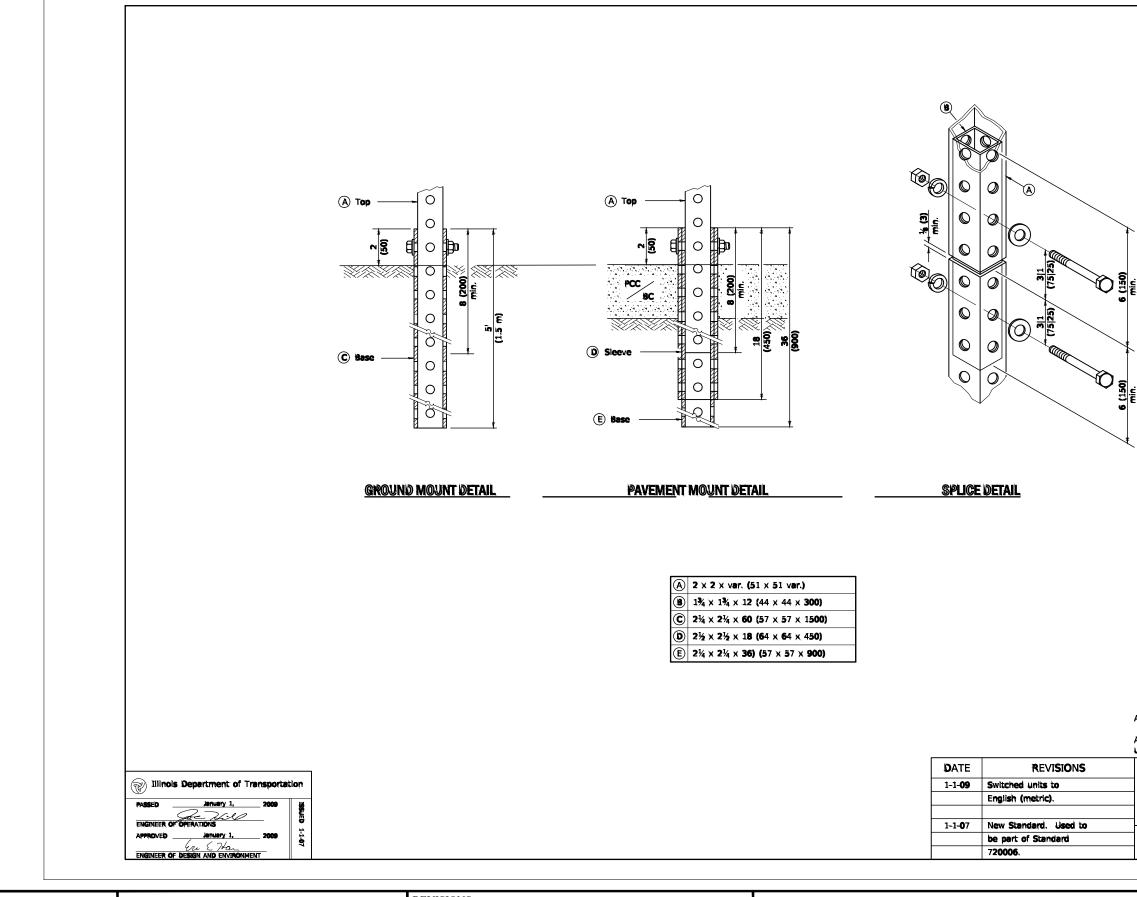
ANDARD DETAILS

2.75	11 5 7.25 5 22		21.75	<b>→</b> <sup>5</sup> →	8.5 2.7	<sup>75</sup>		
	Stree	t Na	me				<b>4</b> 8 1 I [	DIA.
	Street N	Vam	e				-	CITY 0
• • • 6.875	52.75		5 8.5	5	11 6.87		CABINET S (BL N N N N N N C	SIGNAGE ACK TEXT ON COLOR, [IMAGI FRONT SIDE XLUDED IN THE
		52.75			8.5 6.8			
	Street	et Na	me					7
30 6 <del>1</del>			_					ŌNL
86	Street N	vam	e				W. WHITE EAGLE A CONFIGURATIO	ADVANCI
					<b>N</b> 14		(30x30 – NOT	TO SCALE)
2.75 <b>2</b> .75	7.25 5 22 5 5	21.75	₩ <sub>5</sub> ₩ 8.5		11 2.7	75		
 	- <del>2.3</del> 52	75		9.625	3			
5 * 18 *	Street	Nam	le		(×2)			
5					HARDW	ACKETS AND MOUN	MOUNT	
	MAST ARM MOL	JNTED STREET NAME (NOT TO SCALE)	SIGNS		INCLUD	ON MAST ARMS AN ED IN COST OF PA ANEL – TYPE 1 AI	Y ITEM	
HOWEVER, DIMENSIONS PRO	DED ON THIS DETAIL IS NOT TO SCALE, OVIDED ARE AN ACCURATE REPRESENTATION SIZE. SEE DISTRICT ONE MAST ARM MOUNTED IL FOR STANDARDS. DIMENSIONS SUBJECT TO CHANGE.				SIGNAGE			
ALL DIMENSIONS PROVIDED			DESIGNED: GIL DRAWN: GIL	DATE: 4/15/19	REVISED: REVISED:	REVISED: REVISED:		
AURORA	CITY OF AURORA	REVISIONS:			PROJECT		5TH AVE-MCC TRAFFIC SIGNA	
LLINOIS CITY OF LIGHTS	ENGINEERING DIVISION 77 S. BROADWAY		ECKED BY: RG SC ROVED BY: RG DA		SHEET TITLE		MISCELLANEOUS	

30




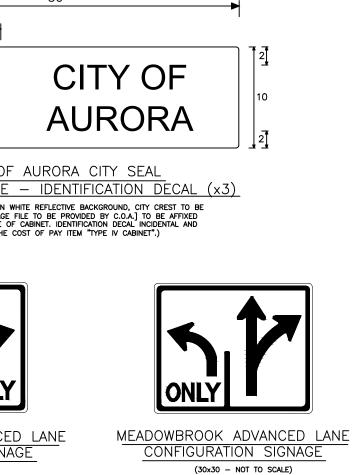

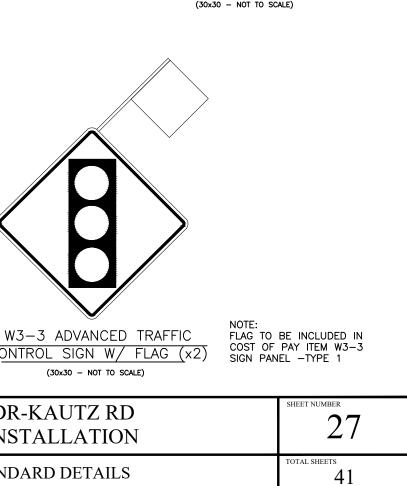



	CITY OF AURORA ENGINEERING DIVISION	REVISIONS:			PROJECT	5TH AVE-MCCOY D TRAFFIC SIGNAL IN
	77 S. BROADWAY	DESIGNED BY: RA	CHECKED BY: RG	SCALE:	SHEET TITLE	
CITY OF LIGHTS	TT 0. BROADWAT	DRAWN BY:GIL/AH	APPROVED BY: RG	DATE: 7/2021		MISCELLANEOUS STAN

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GENERAL NOTES All boits % (M10) hex head zinc or cadmium plated.	
All dimensions are in inches (millimeters) unless otherwise shown.	
TELESCOPING STEEL	
SIGN SUPPORT	
standard 728001-01	
DR-KAUTZ RD	SHEET NUMBER
NSTALLATION	
NDARD DETAILS	total sheets 41

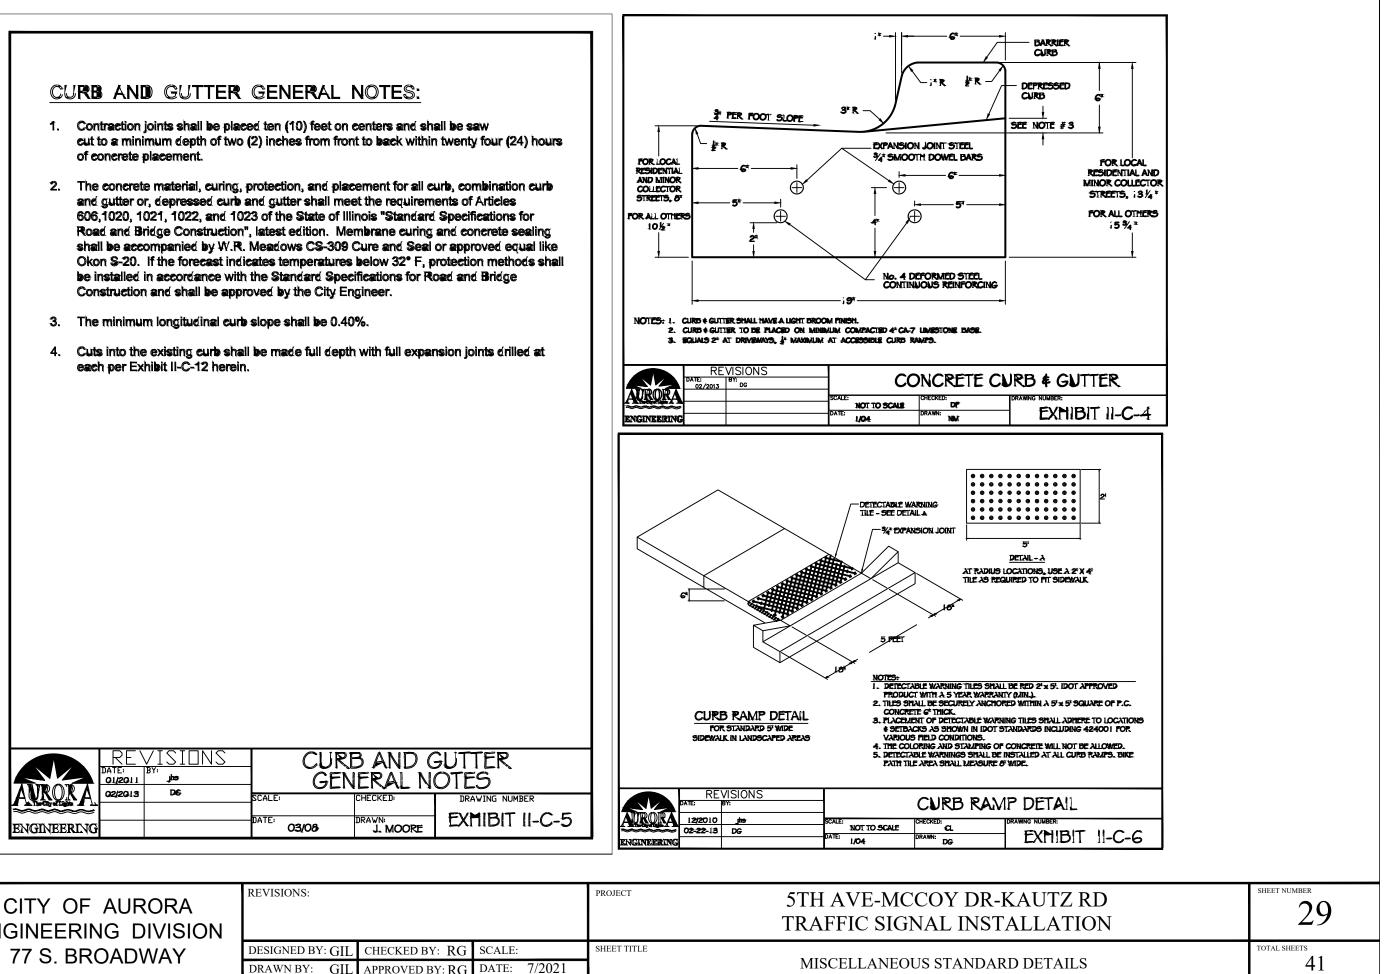

	CITY OF AURORA ENGINEERING DIVISION	REVISIONS:			PROJECT	5TH AVE-MCCOY I TRAFFIC SIGNAL II
	77 S. BROADWAY	DESIGNED BY: GIL	CHECKED BY: RG	SCALE:	SHEET TITLE	
CITY OF LIGHTS	TT S. BROADWAT	DRAWN BY: GIL	APPROVED BY: RG	DATE: 7/2021		MISCELLANEOUS STAN

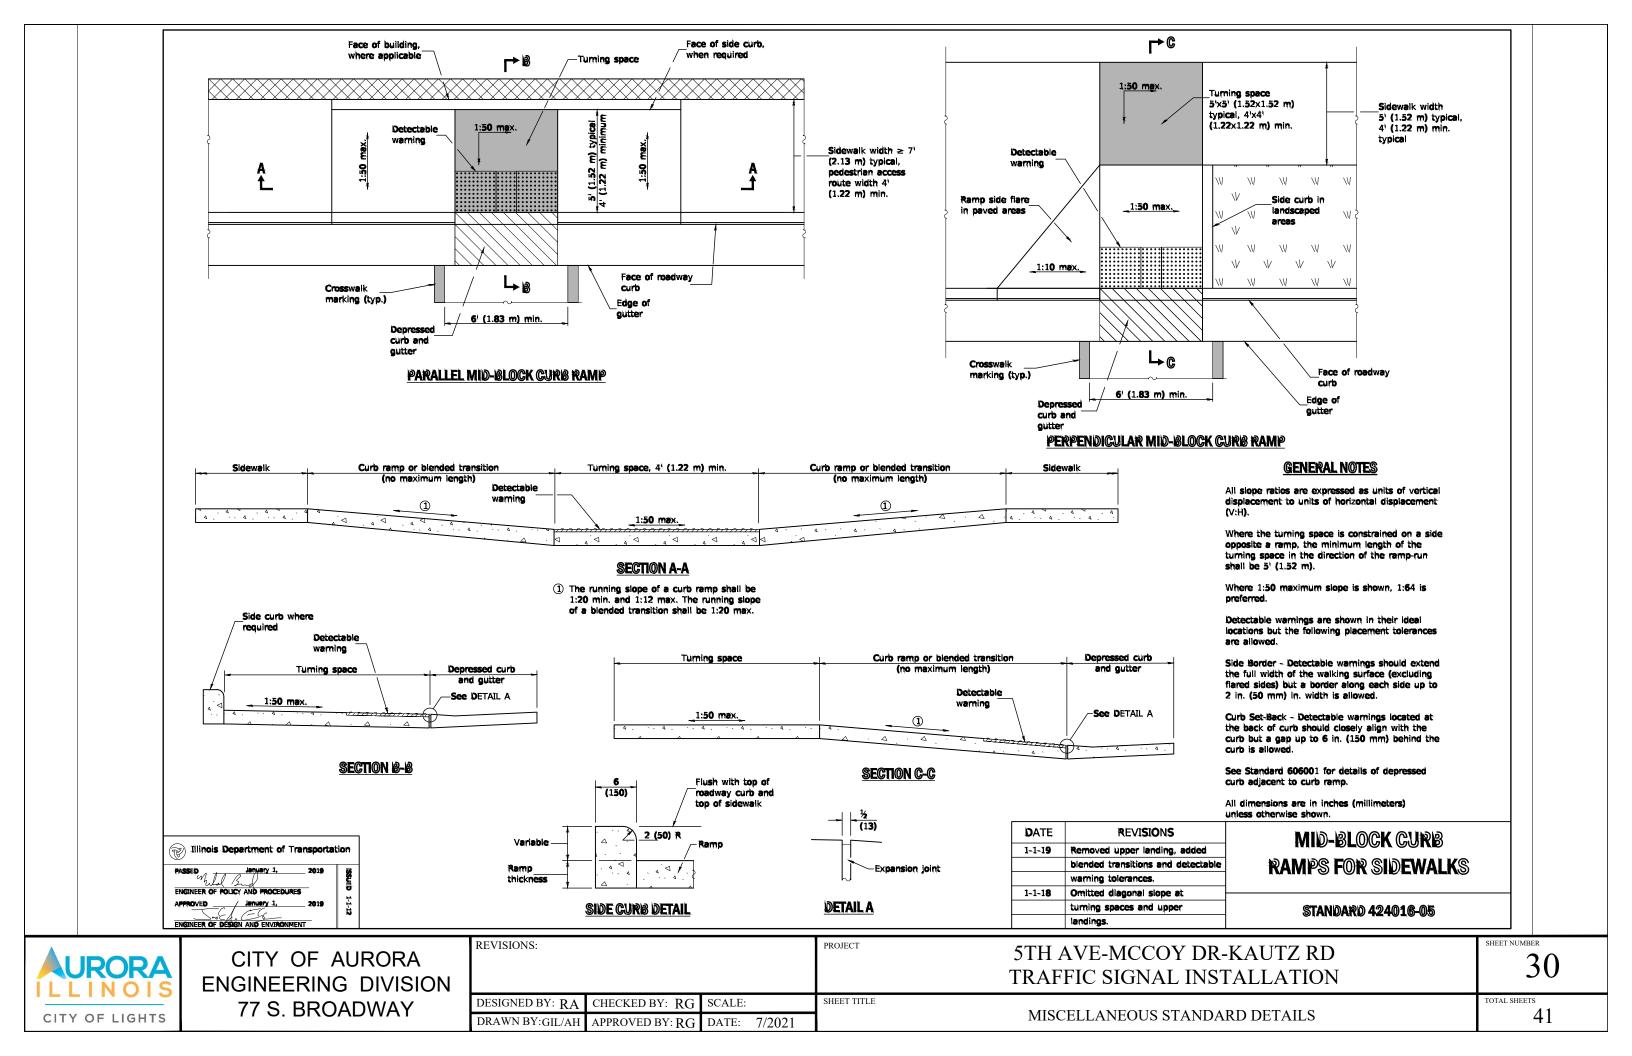

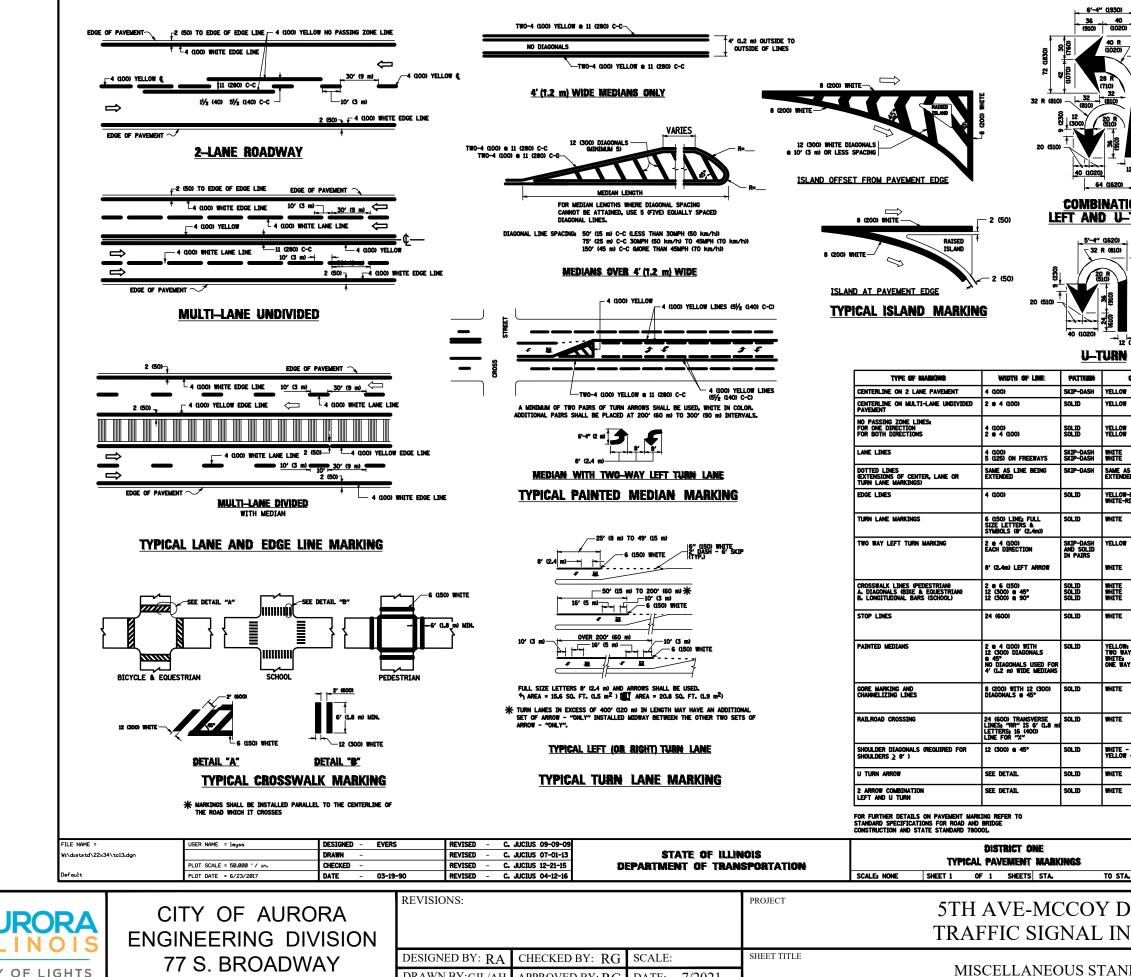

DRAWN BY:GIL/AH APPROVED BY: RG DATE: 7/2021

CITY OF LIGHTS

WHITE	30.4 SF			
		All dimensions are in inches unless otherwise shown.	s (millimeters)	
	F.A. RTË.	SECTION	COUNTY	ŀ
FO STA.		TC-13 ILLINOIS FED.	CONTRACT	ŗ
DR-KA INSTA				
ANDARD	DE	TAILS		

TOTAL SHEETS
41

EТ	NUM	IBER		
		3	1	
ΛT	SHE	STS.		

	A LANE REDUCTION TRANSITION * LANE REDUCTION TRANSITION * LANE REDUCTION TRANSITION * LANE REDUCTION ARROWS REQUIRED AT SPEEDS OF 45 MPH OR OFFICIENT ARROWS REQUIRED AT SPEEDS OF 45 MPH OR CREATE OR WHEN SPECIFIED IN PLANS.	
	UNDATER ON WHEN OFEDERED AN FEMOL	
COLOR	SPACING / NEMANKS	
W	10' (3 m) LINE WITH 30' (9 m) SPACE 11 (280) C-C	
)W DW	5½ (140) C-C FROM SKIP-DASH CENTERLINE 11 (280) C-C OMIT SKIP-DASH CENTERLINE BETWEEN	
	10' (3 m) LINE WITH 30' (9 m) SPACE	
AS LINE BEING	2' (600) LINE WITH 6' (1.8 m) SPACE	
NDED		
DW-LEFT S-RIGHT	OUTLINE MEDIANS IN YELLOW	
•	SEE TYPICAL TURN LANE MARKING DETAIL	
DW	10' (3 m) LINE WITH 30' (9 m) SPACE FOR SKIP-DASHE 5% (140) C-C BETWEEN SOLID LINE AMORSKIP-DASH LINE SHE AMORSKIP-DASH LINE MARKING DETAIL	
	NOT LESS THAN 6' (L8 m) APART 2' (600) APART 2' (600) APART See Typical cossimalk marking details.	
L	PLACE 4" (L2 m) DH ADVANCE OF AND Anallel to chossaul, ff messit. Othernise, react at desided stopping Point, panallel to crossroad centerline, where Postale	
DW: WAY TRAFFIC Bay Traffic	11 (280) C-C FOR THE DOUBLE LINE See typical painted median marking.	
	DIAGONALS: 15'(45 m) C-C (LESS THAN 30MPH (50 km/hi)) 20'(6 m) C-C 30MPH (50 km/h) T0 45MPH (70 km/hi)) 30'(9 m) C-C (0VER 45MPH (70 km/hi))	
5	SEE STATE STANDARD 780001 AREA OF: "X"=3.6 S0. FT. (0.33 m <sup>2</sup> ) EACH "X"=54.0 S0. FT. (5.0 m <sup>2</sup> )	
E - RIGHT DW - LEFT	50°(15 m) C-C (LESS THAN 30MPH (50 km/h)) 75°(25 m) C-C (ISO MPH (50 km/h) TO 45MPH (70 km/h)) 150°(45 m) C-C (10VER 45MPH (70 km/h))	
	16.3 SF	
	30.4 SF	
	Al dimensions are in inches (nilimeters) unless othervise shown.	
	F.A. SECTION COUNTY TOTAL SHEET NO.	
	TE-13 CONTRACT NO.	
TA.	ILLINOIS FED. AID PROJECT	
DR-K	AUTZ RD	SHEET NUMBER

**D(F1)** 


345


425

. <u>6</u>

SPEED LIMIT


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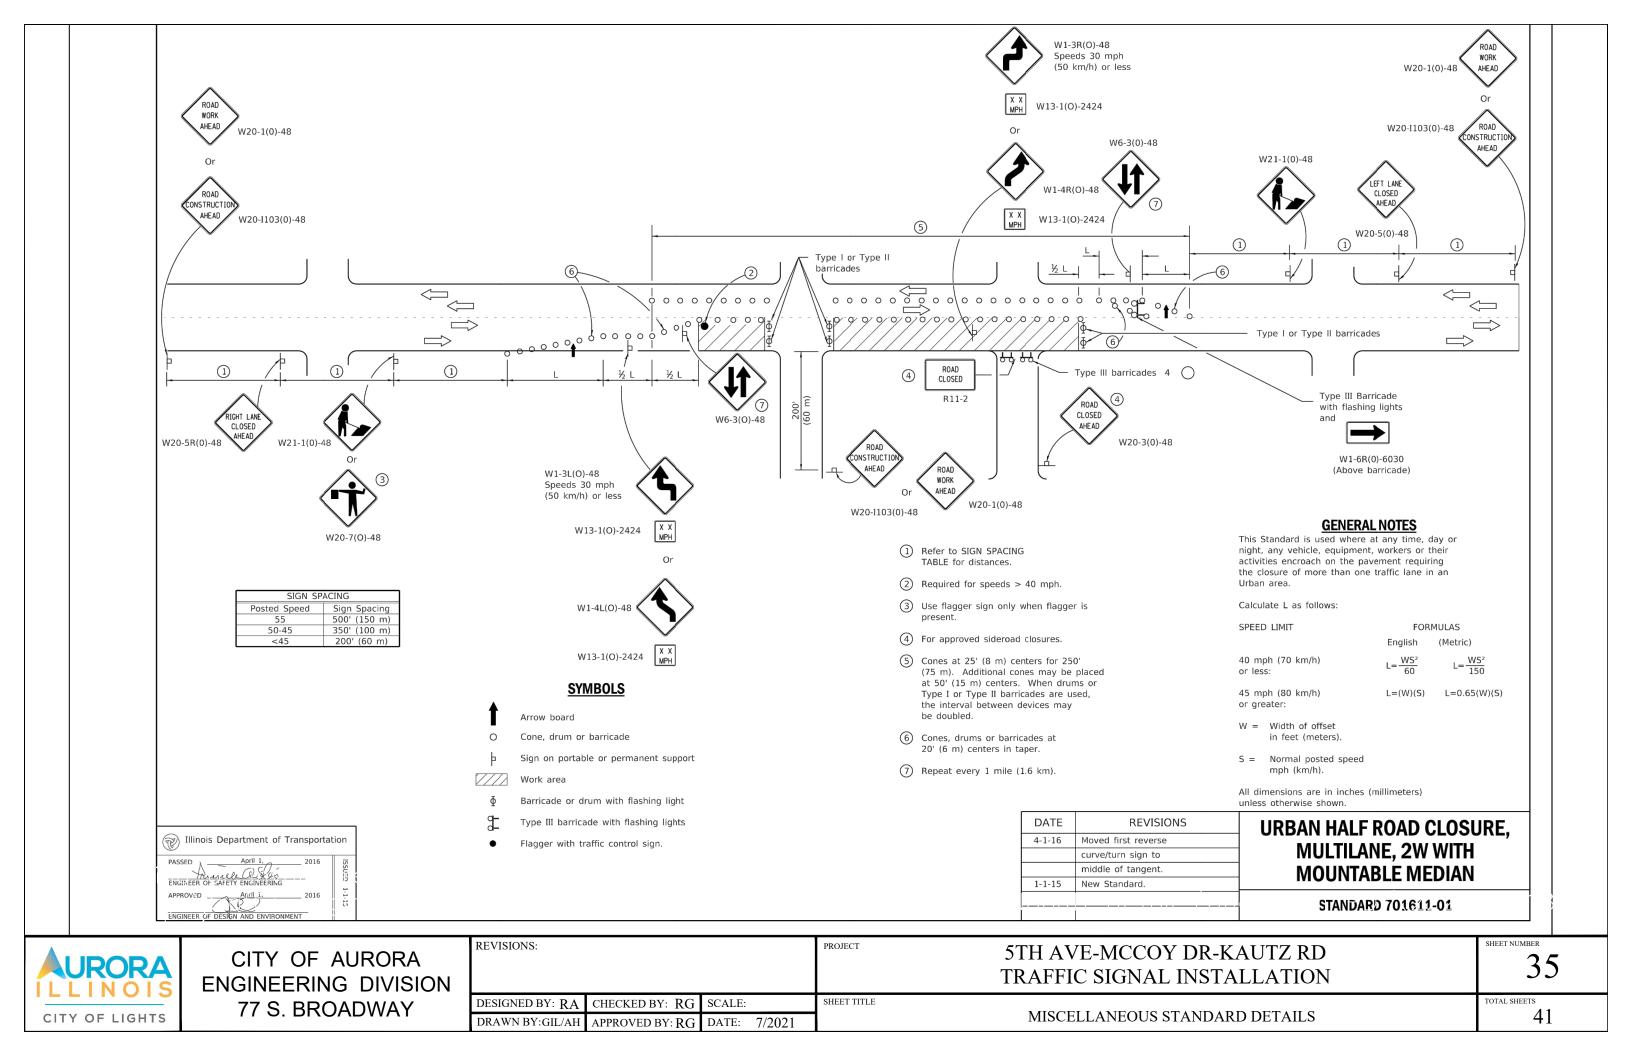


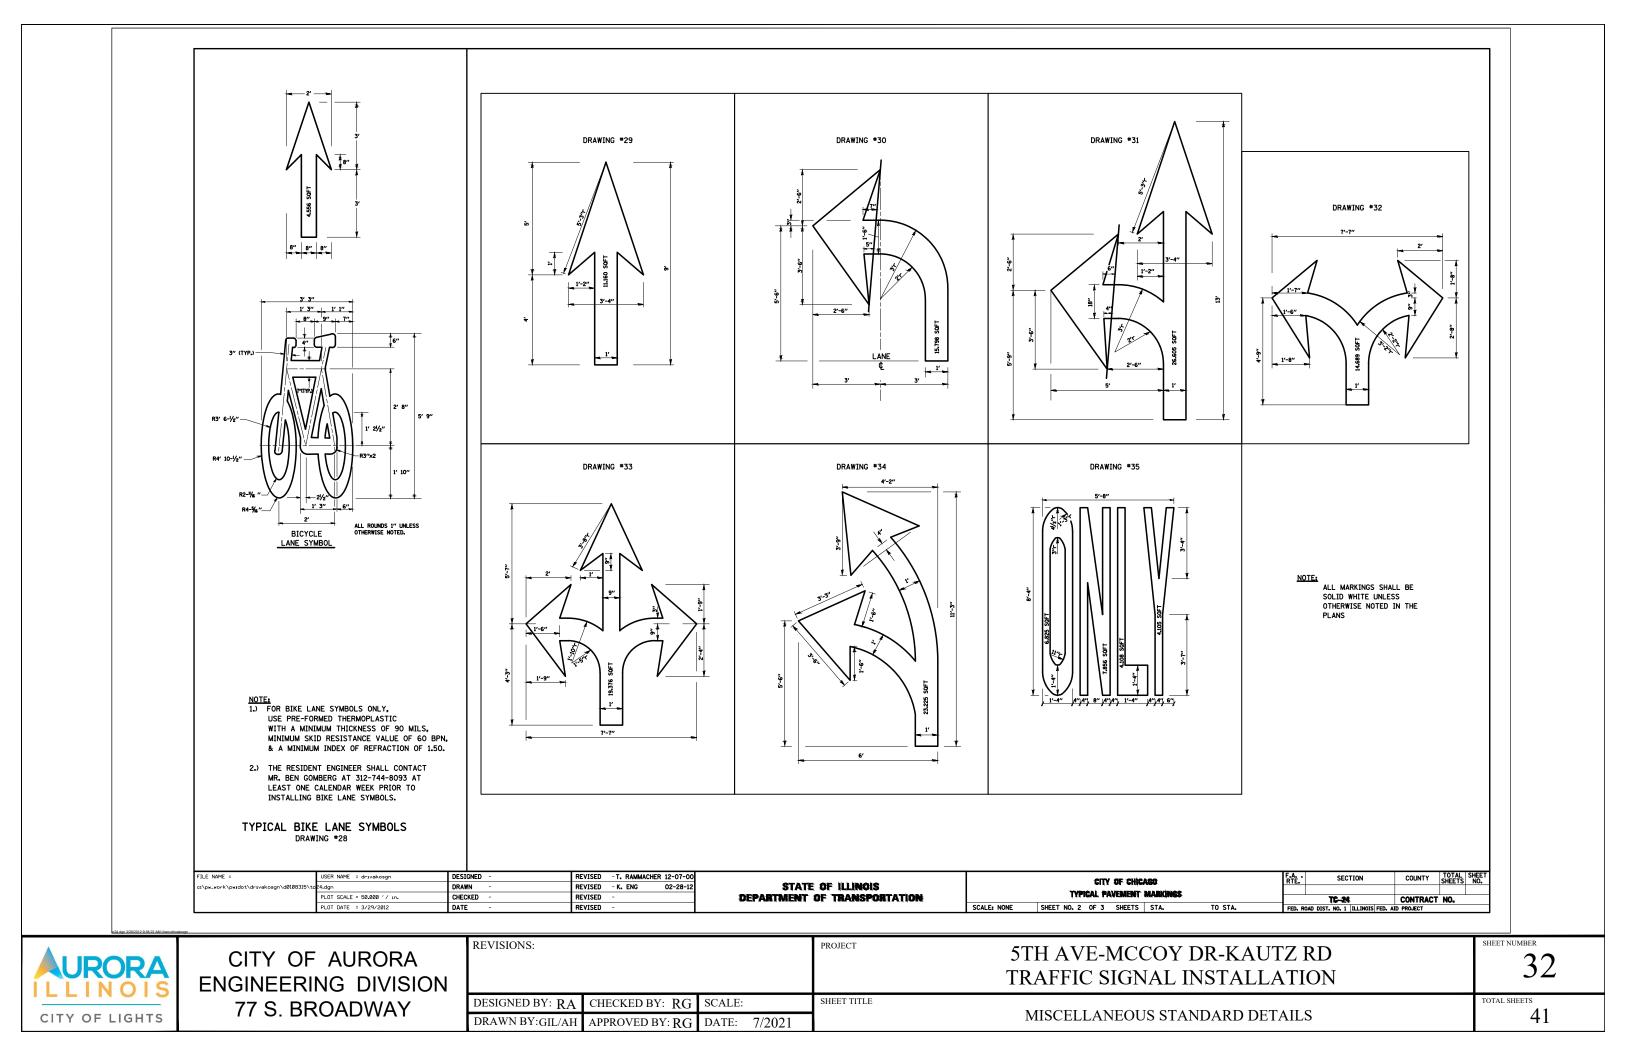
CITY OF LIGHTS

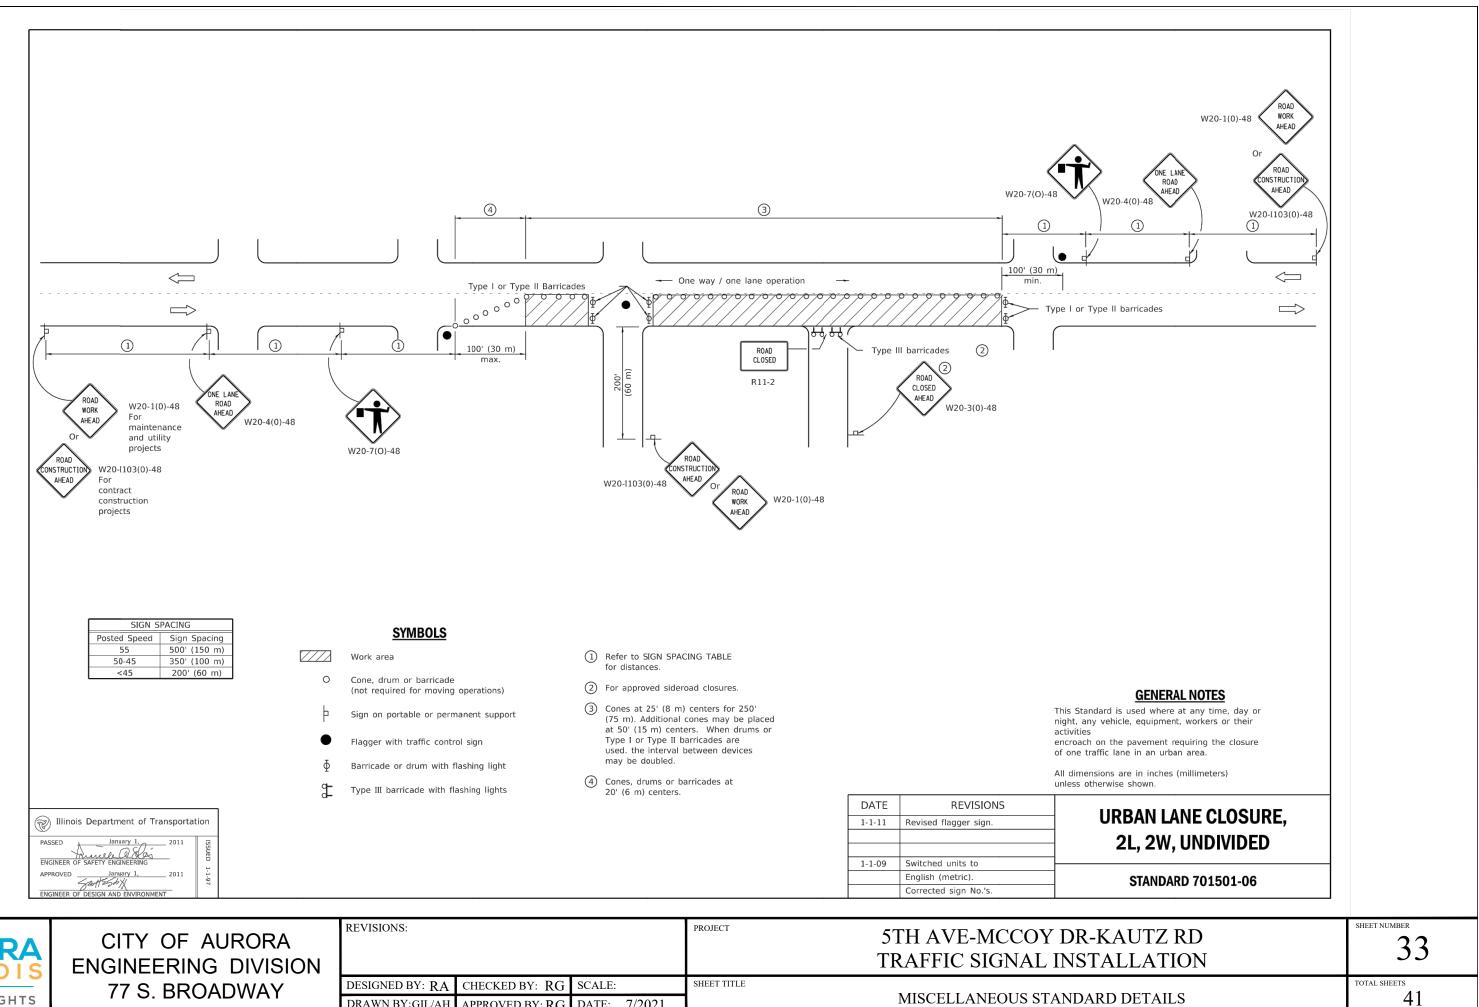DRAWN BY:GIL/AH APPROVED BY: RG DATE: 7/2021



	CITY OF AURORA ENGINEERING DIVISION	REVISIONS:			PROJECT	5TH AVE-MCCOY I TRAFFIC SIGNAL II
	77 S. BROADWAY	DESIGNED BY: RA	CHECKED BY: RG	SCALE:	SHEET TITLE	
CITY OF LIGHTS		DRAWN BY:GIL/AH	APPROVED BY: RG	DATE: 7/2021		MISCELLANEOUS STAN

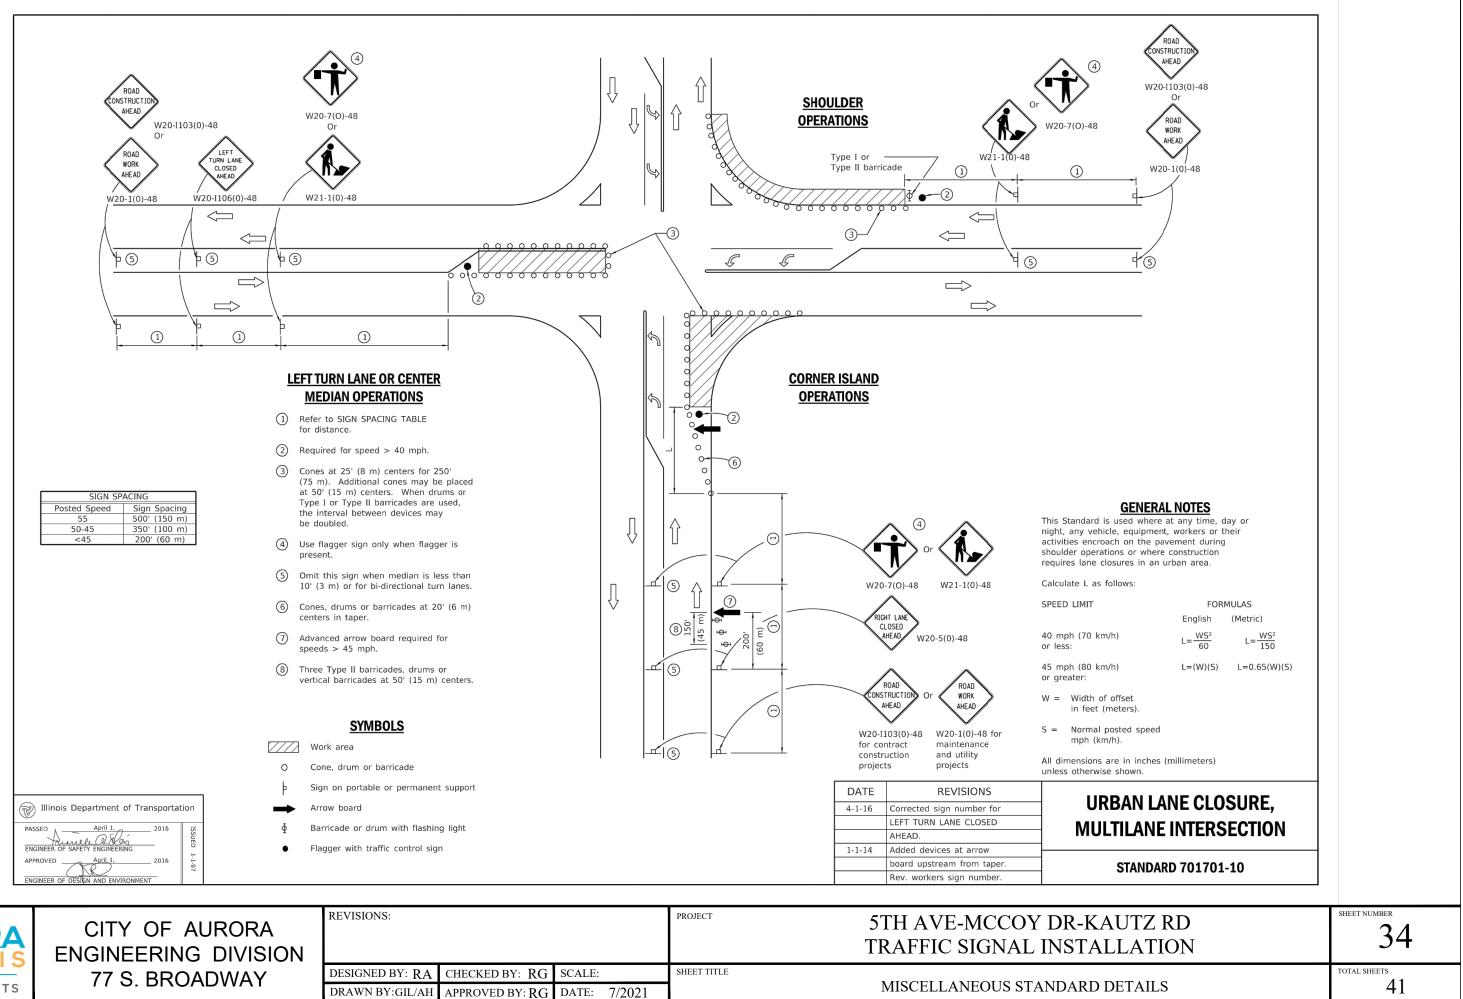

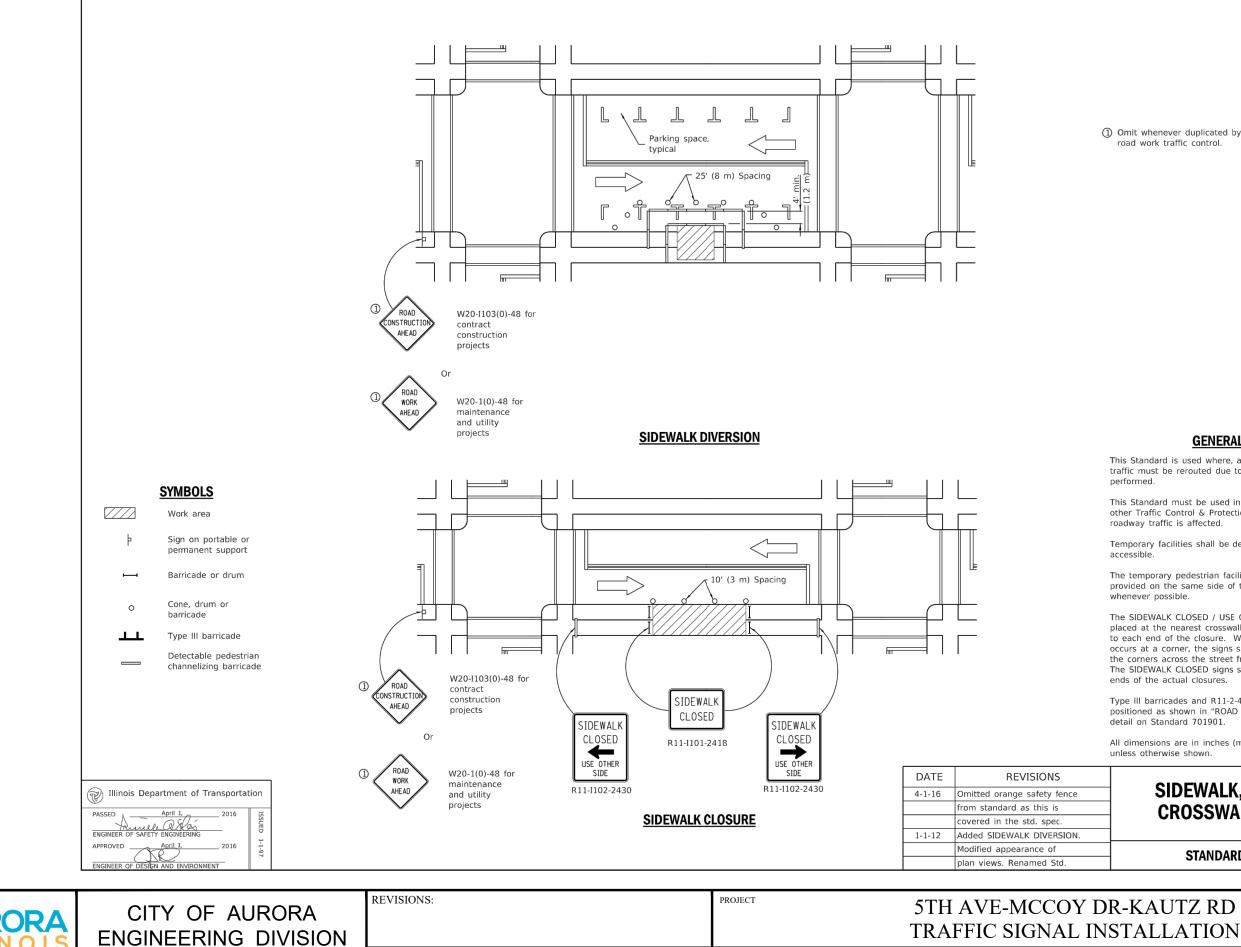

CHECKED BY: RG SCALE:

DRAWN BY:GIL/AH APPROVED BY: RG DATE: 7/2021

SHEET TITLE

DESIGNED BY: RA

LLINOIS	ENGINEERING DIVIS
CITY OF LIGHTS	

MISCELLANEOUS STANDARD DETAILS

① Omit whenever duplicated by road work traffic control.

#### **GENERAL NOTES**

This Standard is used where, at any time, pedestrian traffic must be rerouted due to work being performed.

This Standard must be used in conjunction with other Traffic Control & Protection Standards when roadway traffic is affected.

Temporary facilities shall be detectable and accessible.

The temporary pedestrian facilities shall be provided on the same side of the closed facilities whenever possible.

The SIDEWALK CLOSED / USE OTHER SIDE sign shall be placed at the nearest crosswalk or intersection to each end of the closure. Where the closure occurs at a corner, the signs shall be erected on the corners across the street from the closure. The SIDEWALK CLOSED signs shall be used at the ends of the actual closures.

Type III barricades and R11-2-4830 signs shall be positioned as shown in "ROAD CLOSED TO ALL TRAFFIC" detail on Standard 701901.

All dimensions are in inches (millimeters) unless otherwise shown.

### SIDEWALK, CORNER OR **CROSSWALK CLOSURE**


(Sheet 1 of 2)

### STANDARD 701801-06

SHEET NUMBER

36

TOTAL SHEETS 41

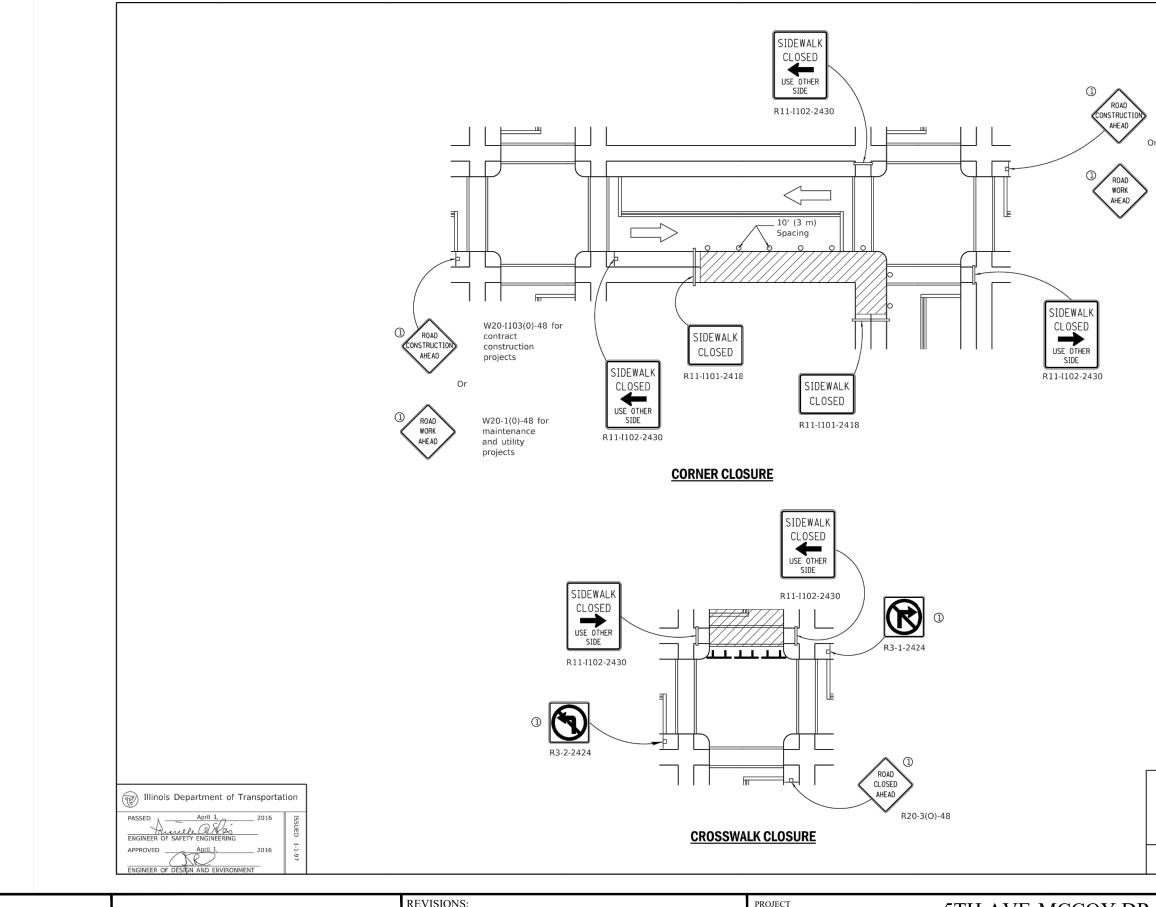

	CITY OF AURORA ENGINEERING DIVISION	REVISIONS:			PROJECT	5TH AVE-MCCOY D TRAFFIC SIGNAL IN
	77 S. BROADWAY	DESIGNED BY: RA	CHECKED BY: RG	SCALE:	SHEET TITLE	
CITY OF LIGHTS	TT 0. BROADWAT	DRAWN BY:GIL/AH	APPROVED BY: RG	DATE: 7/2021		MISCELLANEOUS STANI

W20-I103(0)-48 for contract construction projects

W20-1(0)-48 for maintenance and utility projects

### SIDEWALK, CORNER OR **CROSSWALK CLOSURE**

(Sheet 2 of 2)

### STANDARD 701801-06


R-KAUTZ RD **STALLATION** 

DARD DETAILS

37


SHEET NUMBER

TOTAL SHEETS 41

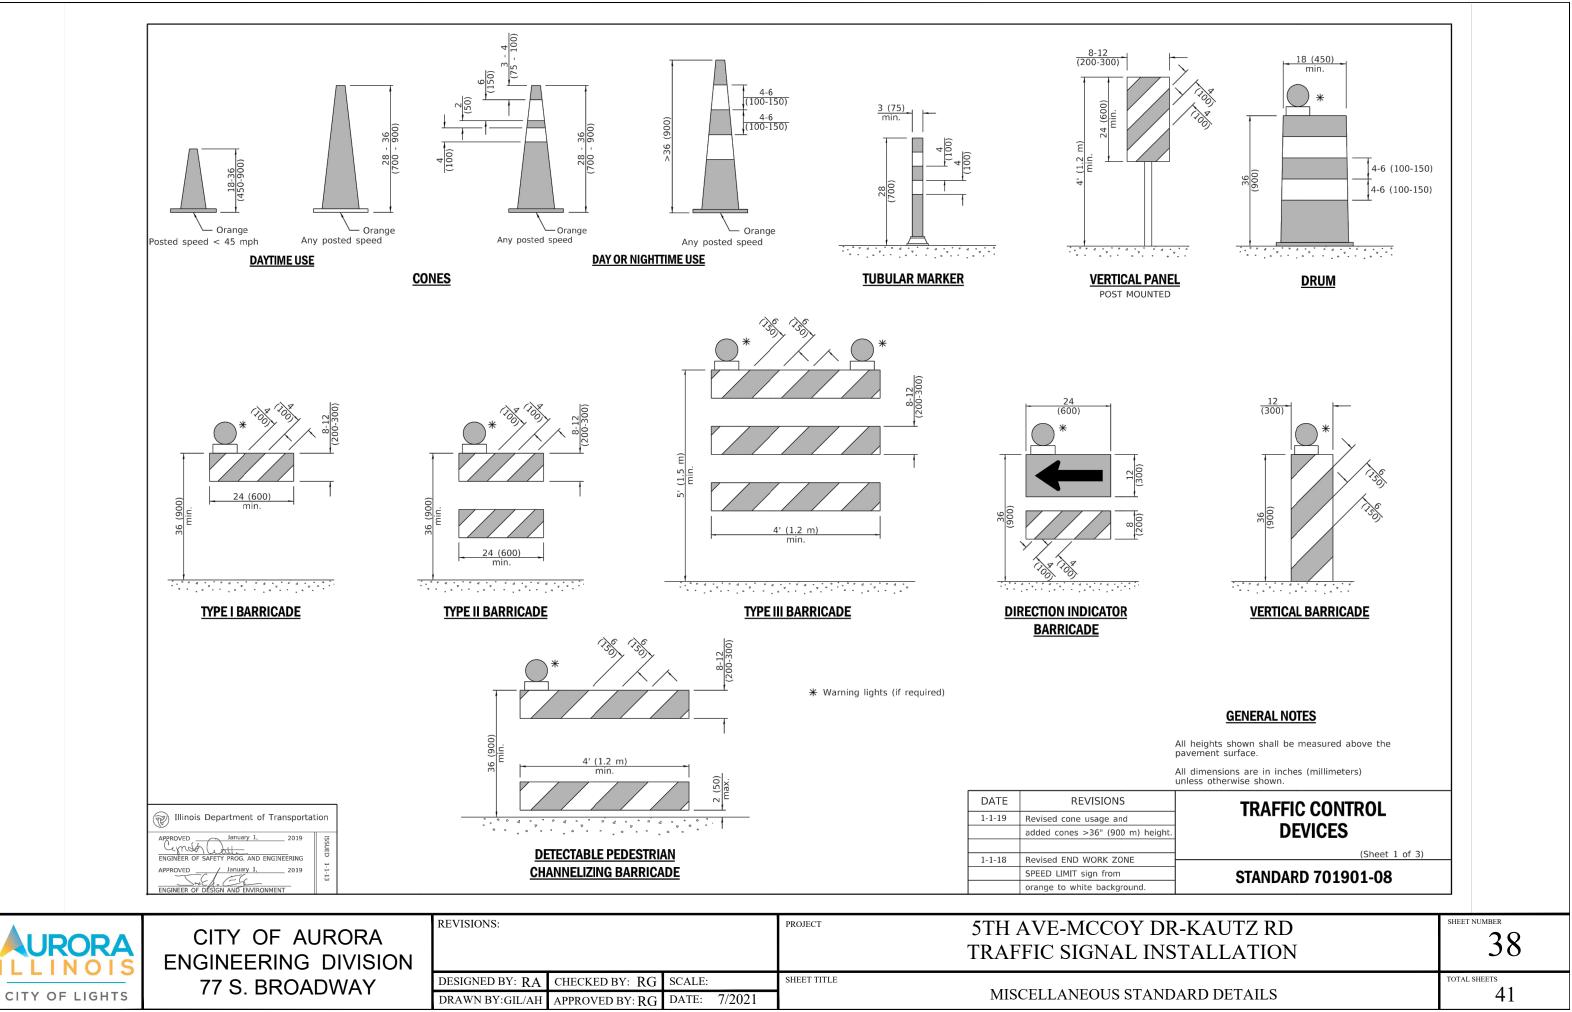

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CITY	OF	LIGH	ТS

NEERING DIVISION	
	DESIGNED BY
	DRAWN BY:G

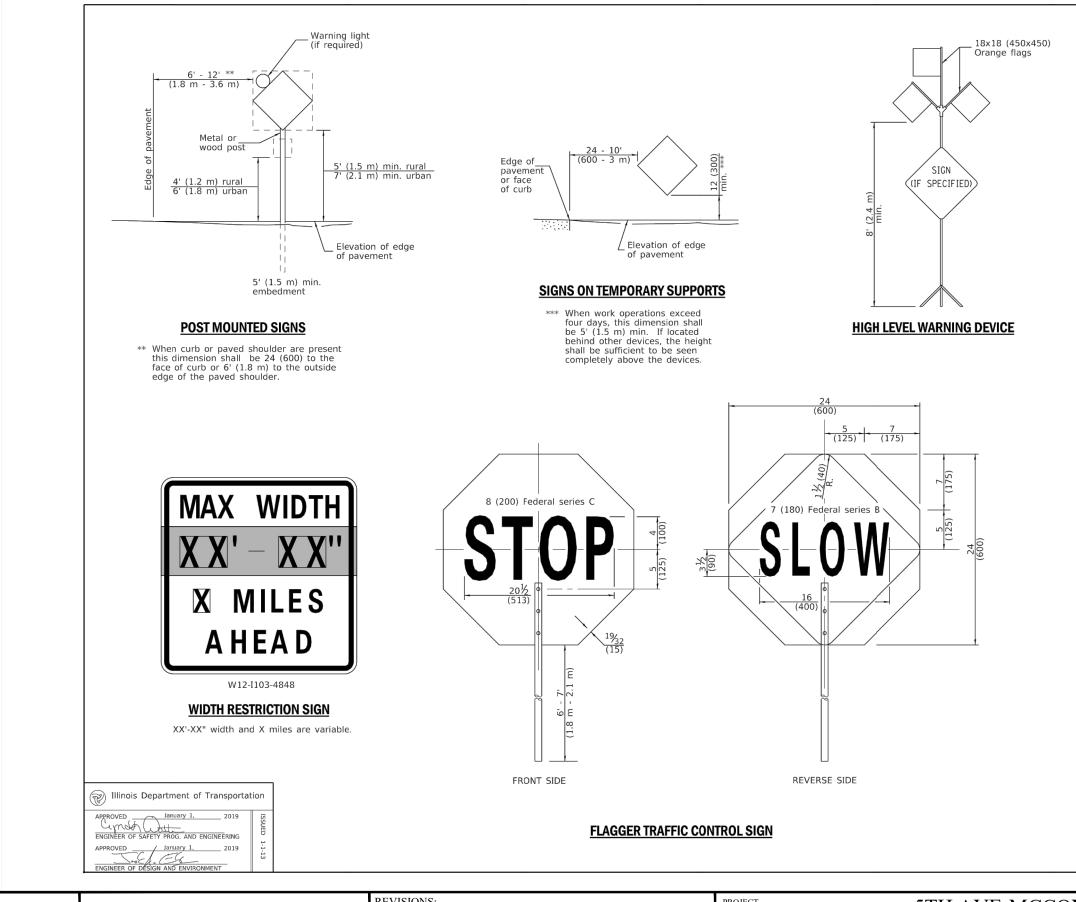


CITY OF LIGHTS


CITY OF AURORA ENGINEERING DIVISION 77 S. BROADWAY 

 REVISIONS:
 PROJECT
 **5**TH AVE-MCCOY DR-KAUTZ RD TRAFIC SIGNAL INSTALLATION


 DESIGNED BY: RA
 CHECKED BY: RG
 SCALE:
 SHEET TITLE

 DRAWN BY:GIL/AH
 APPROVED BY: RG
 DATE: 7/2021
 SHEET TITLE

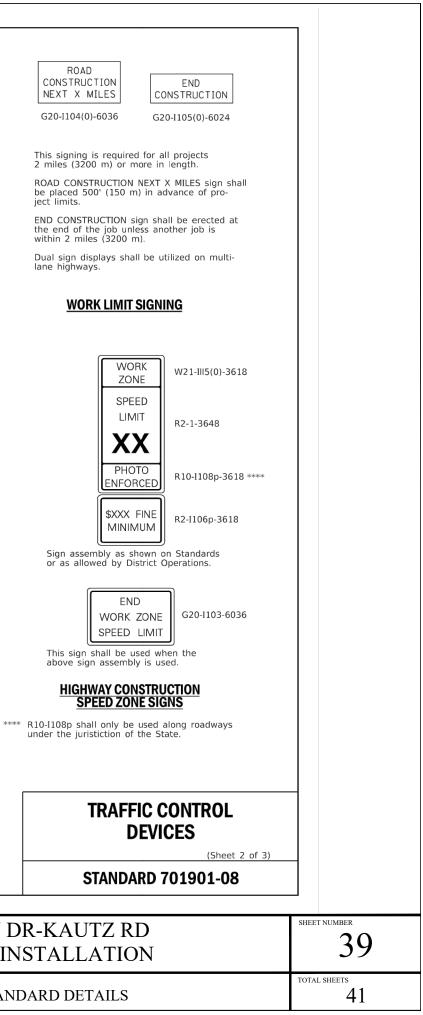

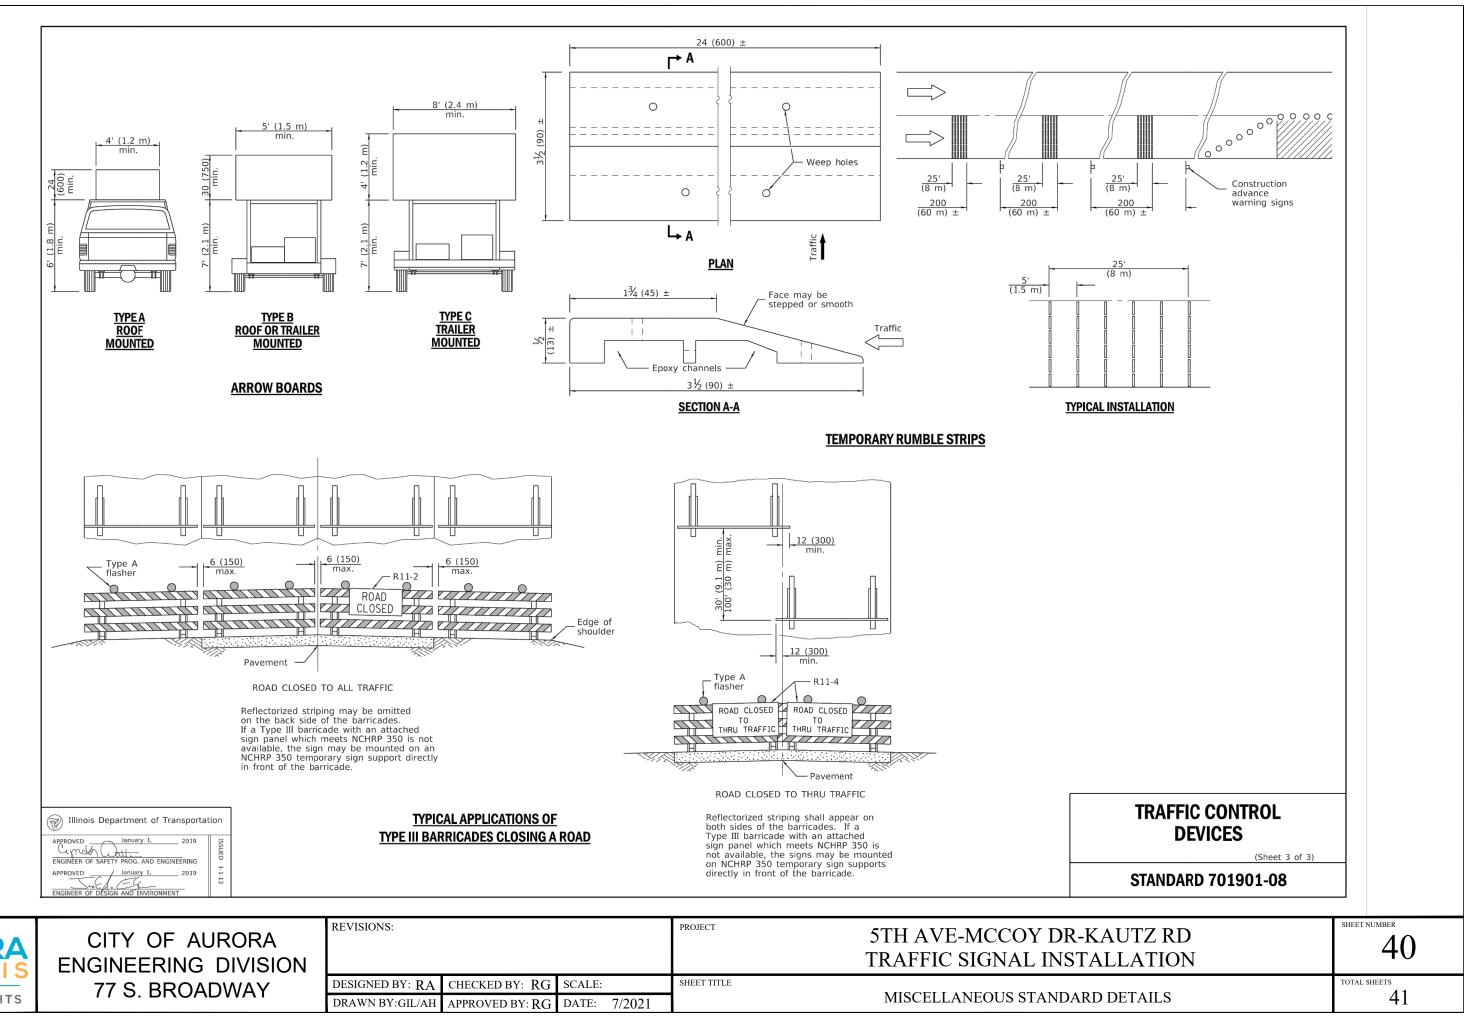

	CITY OF AURORA ENGINEERING DIVISION	REVISIONS:				PROJECT	5TH AVE-MCCOY E TRAFFIC SIGNAL IN
	77 S. BROADWAY	DESIGNED BY: RA	CHECKED BY: $RG$	SCALE:		SHEET TITLE	
CITY OF LIGHTS		DRAWN BY:GIL/AH	APPROVED BY: RG	DATE:	7/2021		MISCELLANEOUS STAN

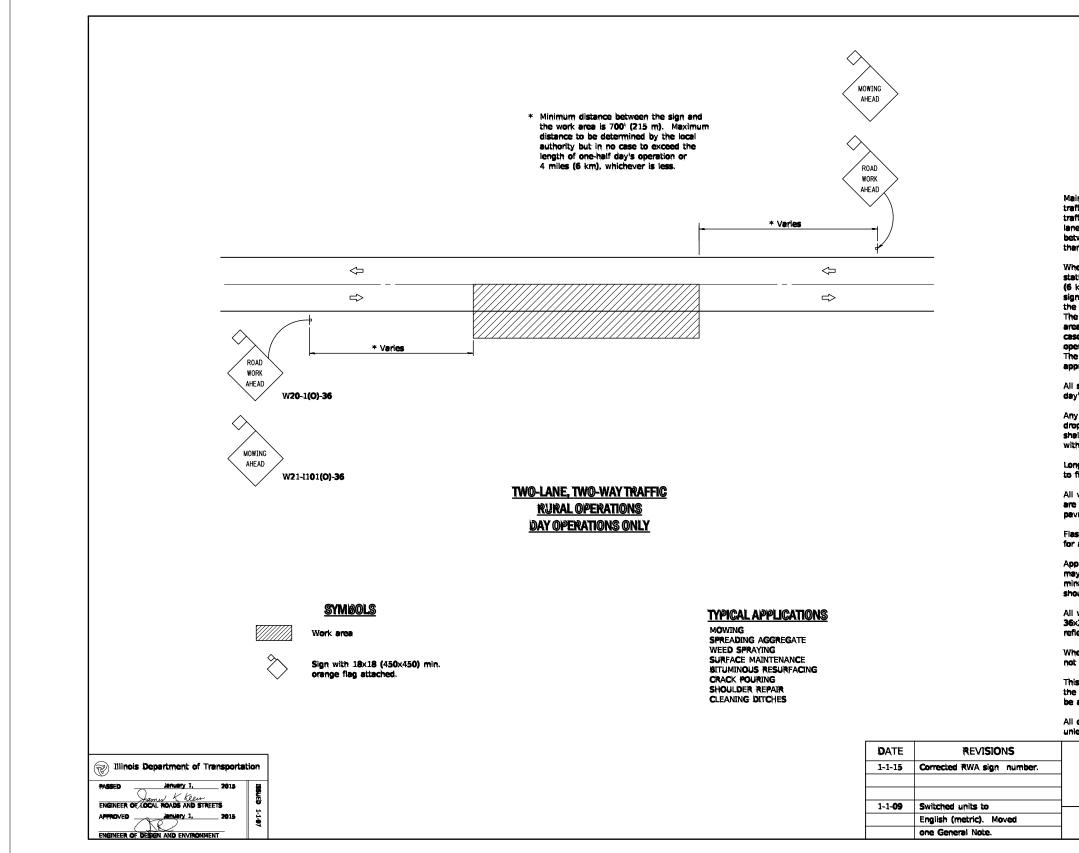

	CITY OF AURORA ENGINEERING DIVISION	REVISIONS:			PROJECT	5TH AVE-MCCOY D TRAFFIC SIGNAL IN
	77 S. BROADWAY	DESIGNED BY: RA	CHECKED BY: RG	SCALE:	SHEET TITLE	
CITY OF LIGHTS		DRAWN BY:GIL/AH	APPROVED BY: RG	DATE: 7/2021		MISCELLANEOUS STANE

<u>GENERAL NOTES</u> intenance operations shall be confined to one ffic lane, leaving the opposite lane open to ffic. At least 500' (150 m) of both traffic es shall be available for traffic movement ween work areas at intervals not greater in 1000' (300 m).	
en operations are on the pavement and tionary or moving at a speed less than 4 mph kph), a ONE LANE AHEAD, or other appropriate n, shall be installed in each direction between the ROAD WORK AHEAD sign and the work area. A distance between this sign and the work as shall be a minimum of 400' (120 m) but in no te to exceed the length of one-half day's aration or 4 miles (6 km), whichever is less. A distance between the two signs shall be proximately 400' (120 m).	
signs are to be removed at completion of the /'s operation.	
y Unattended obstacle, excavation, or pavement p off greater than 3 (75) in the work area II be protected by Type I or Type II barricades h flashing lights.	
ngitudinal dimensions may be adjusted slightly fit field conditions.	
vehicles, equipment, men, and their acitvities restricted at all times to one side of the ment.	
shing lights or rotating beacons are required all maintenance vehicles while in operation.	
plicable operations illustrated in Standard 701301 y be used when operations do not exceed 15 nutes on the pavement or 60 minutes on the sulder respectively.	
warning signs shall have minimum dimensions of (36 (900x900) and have black legend on an orange lectorized background.	
en fluorescent signs are used, orange flags are required.	
s case is for use on rural local roads where t local authority considers this protection to appropriate for the specific job conditions.	
dimensions are in inches (millimeters) ess otherwise shown.	
TRAFFIC CONTROL DEVICES-	
DAY LABOR MAINTENANCE	
standard B.L.R. 18-6	
DR-KAUTZ RD	SHEET NUMBER
	41
NSTALLATION	

DARD DETAILS

TOTAL SHEETS	
4	1