


PLANS FOR THE PROPOSED

KEATING DRIVE WATER MAIN IMPROVEMENTS

KEATING DR. FROM MIDDLEBURY DR. TO NORMANTOWN RD.

LEGEND ×682.6 TC TOP OF CURB ELEVATION TOP OF FOUNDATION ELEVATION **GUTTER ELEVATION** √682.6 P PAVEMENT ELEVATION **CURB AND GUTTER** RIGHT-OF-WAY SANITARY MANHOLE FLARED END SECTION VALVE VAULT STREET LIGHT TELEPHONE BOX TELEPHONE MANHOLE TREE W/ DIAMETER STRUCTURE TO BE REMOVED PLUG EXISTING PIPE UTILITY CROSSING EXPLORATORY EXCAVATION LOCATION SANITARY MANHOLE REHABILATATION NUMBER 3-C-100 💿 SOIL BORING LOCATION WITH IDENTIFICATION NUMBER & ELEVATION

MAY 2024 GENERALLY LOCATED IN THE S. 1/2 OF SEC. 32, T38N, R9E

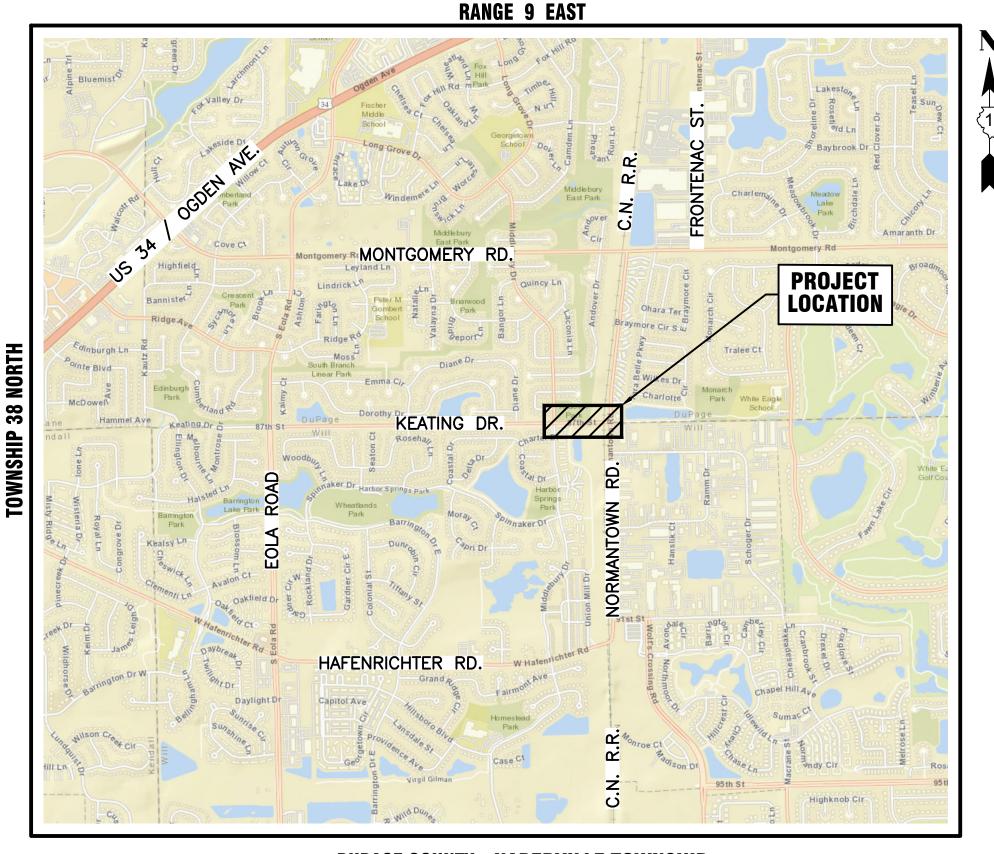

DUPAGE COUNTY - NAPERVILLE TOWNSHIP THIRD PRINCIPAL MERIDIAN

LOCATION MAP

NOT TO SCALE

INDEX OF SHEETS

- 1 COVER SHEET
- 2 3 PLAN AND PROFILE
- 4 WC R.R. EXHIBIT
- 5 8 STANDARD DETAILS



J.U.L.I.E.
JOINT UTILITY LOCATION INFORMATION FOR EXCAVATION
811 OR 1-800-892-0123

CONSTRUCTION AND MAINTENANCE TO BE IN ACCORDANCE WITH ALL APPLICABLE REGULATORY REQUIREMENTS AND STANDARDS

PRINTED BY THE AUTHORITY OF THE CITY OF AURORA

PLANS PREPARED BY:


CITY OF AURORA


DEPARTMENT OF PUBLIC WORKS - ENGINEERING DIVISION 77 S. BROADWAY AVE, AURORA, IL 60505

PHONE: 630-256-3200 FAX: 630-256-3229


	ENTS — 10/20/23 ENTRAL LTD. COMMENTS — IENTS — 1/25/24	- 10/20/23			
				HORIZ. SCALE: N/A	
DESIGNED BY: NS	DRAWN BY: MH	CHECKED BY: KTM	APPROVED BY: KTM	VERT. SCALE: N/A	DATE: OCT. 2023

STAMP		DATE
ILLINOIS REGISTERED PROF	ESSIONAL	
ENGINEER No.	062.070660	
LICENSE EXPIRES	NOVEMBER 30, 2023	

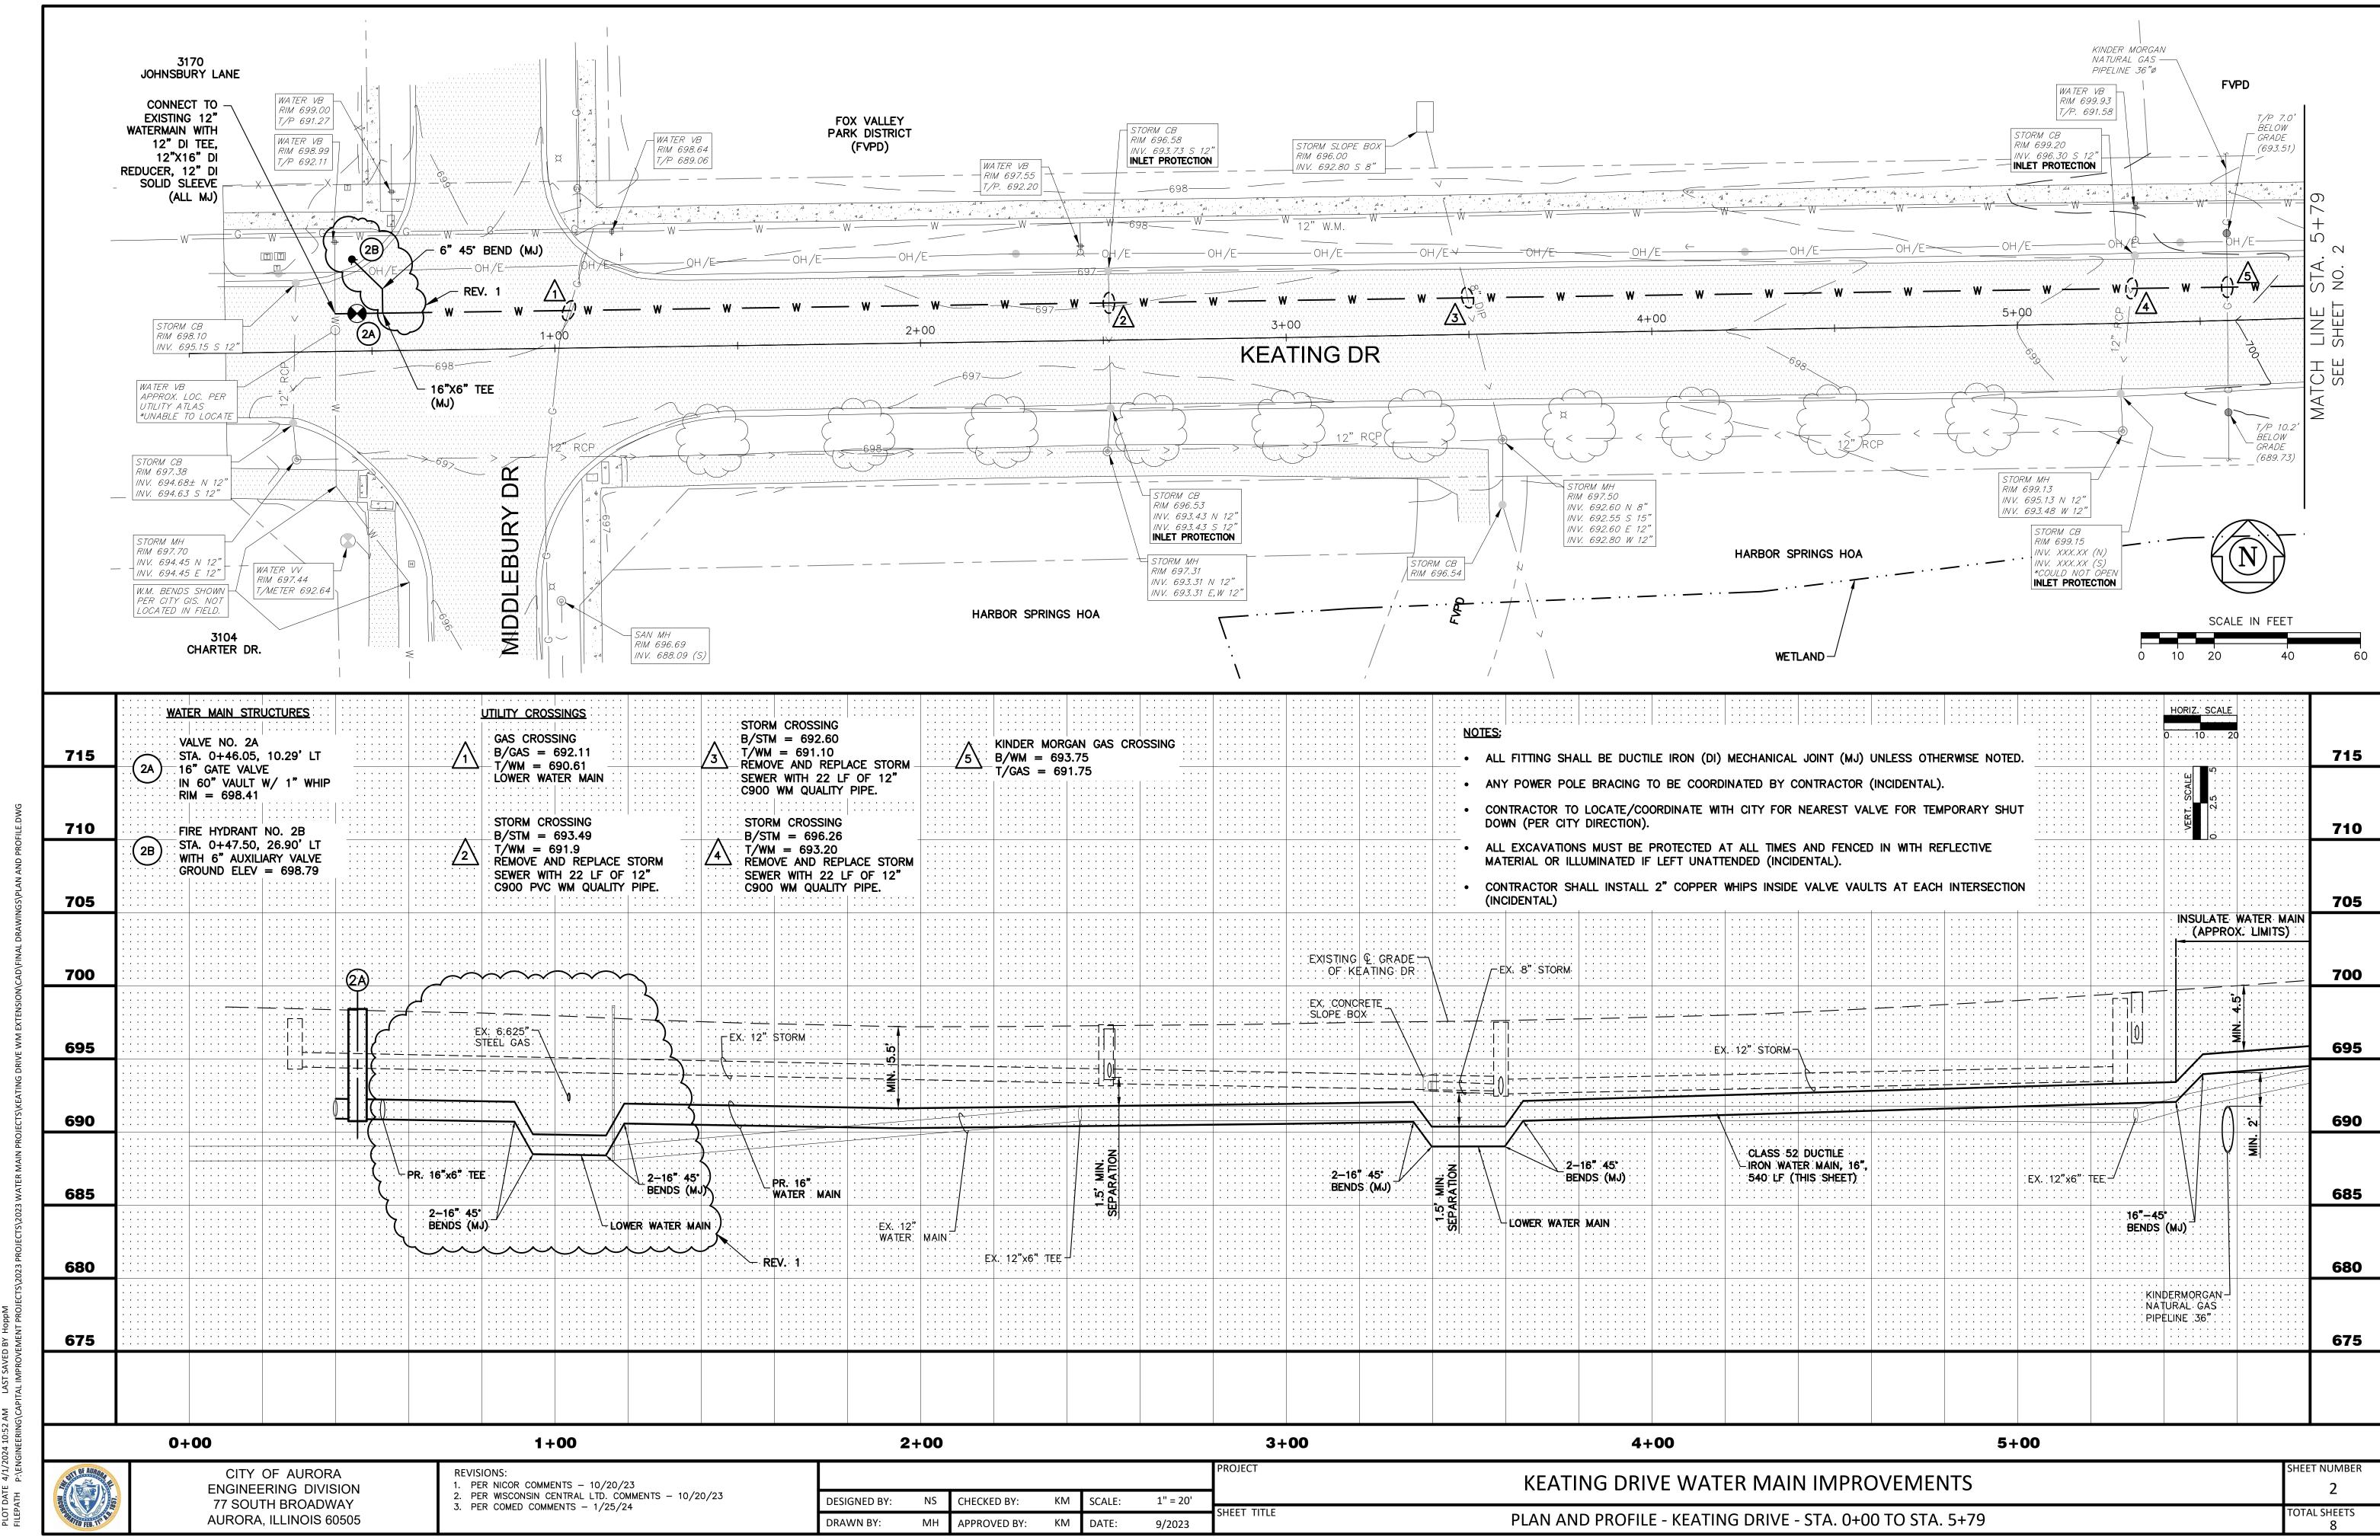

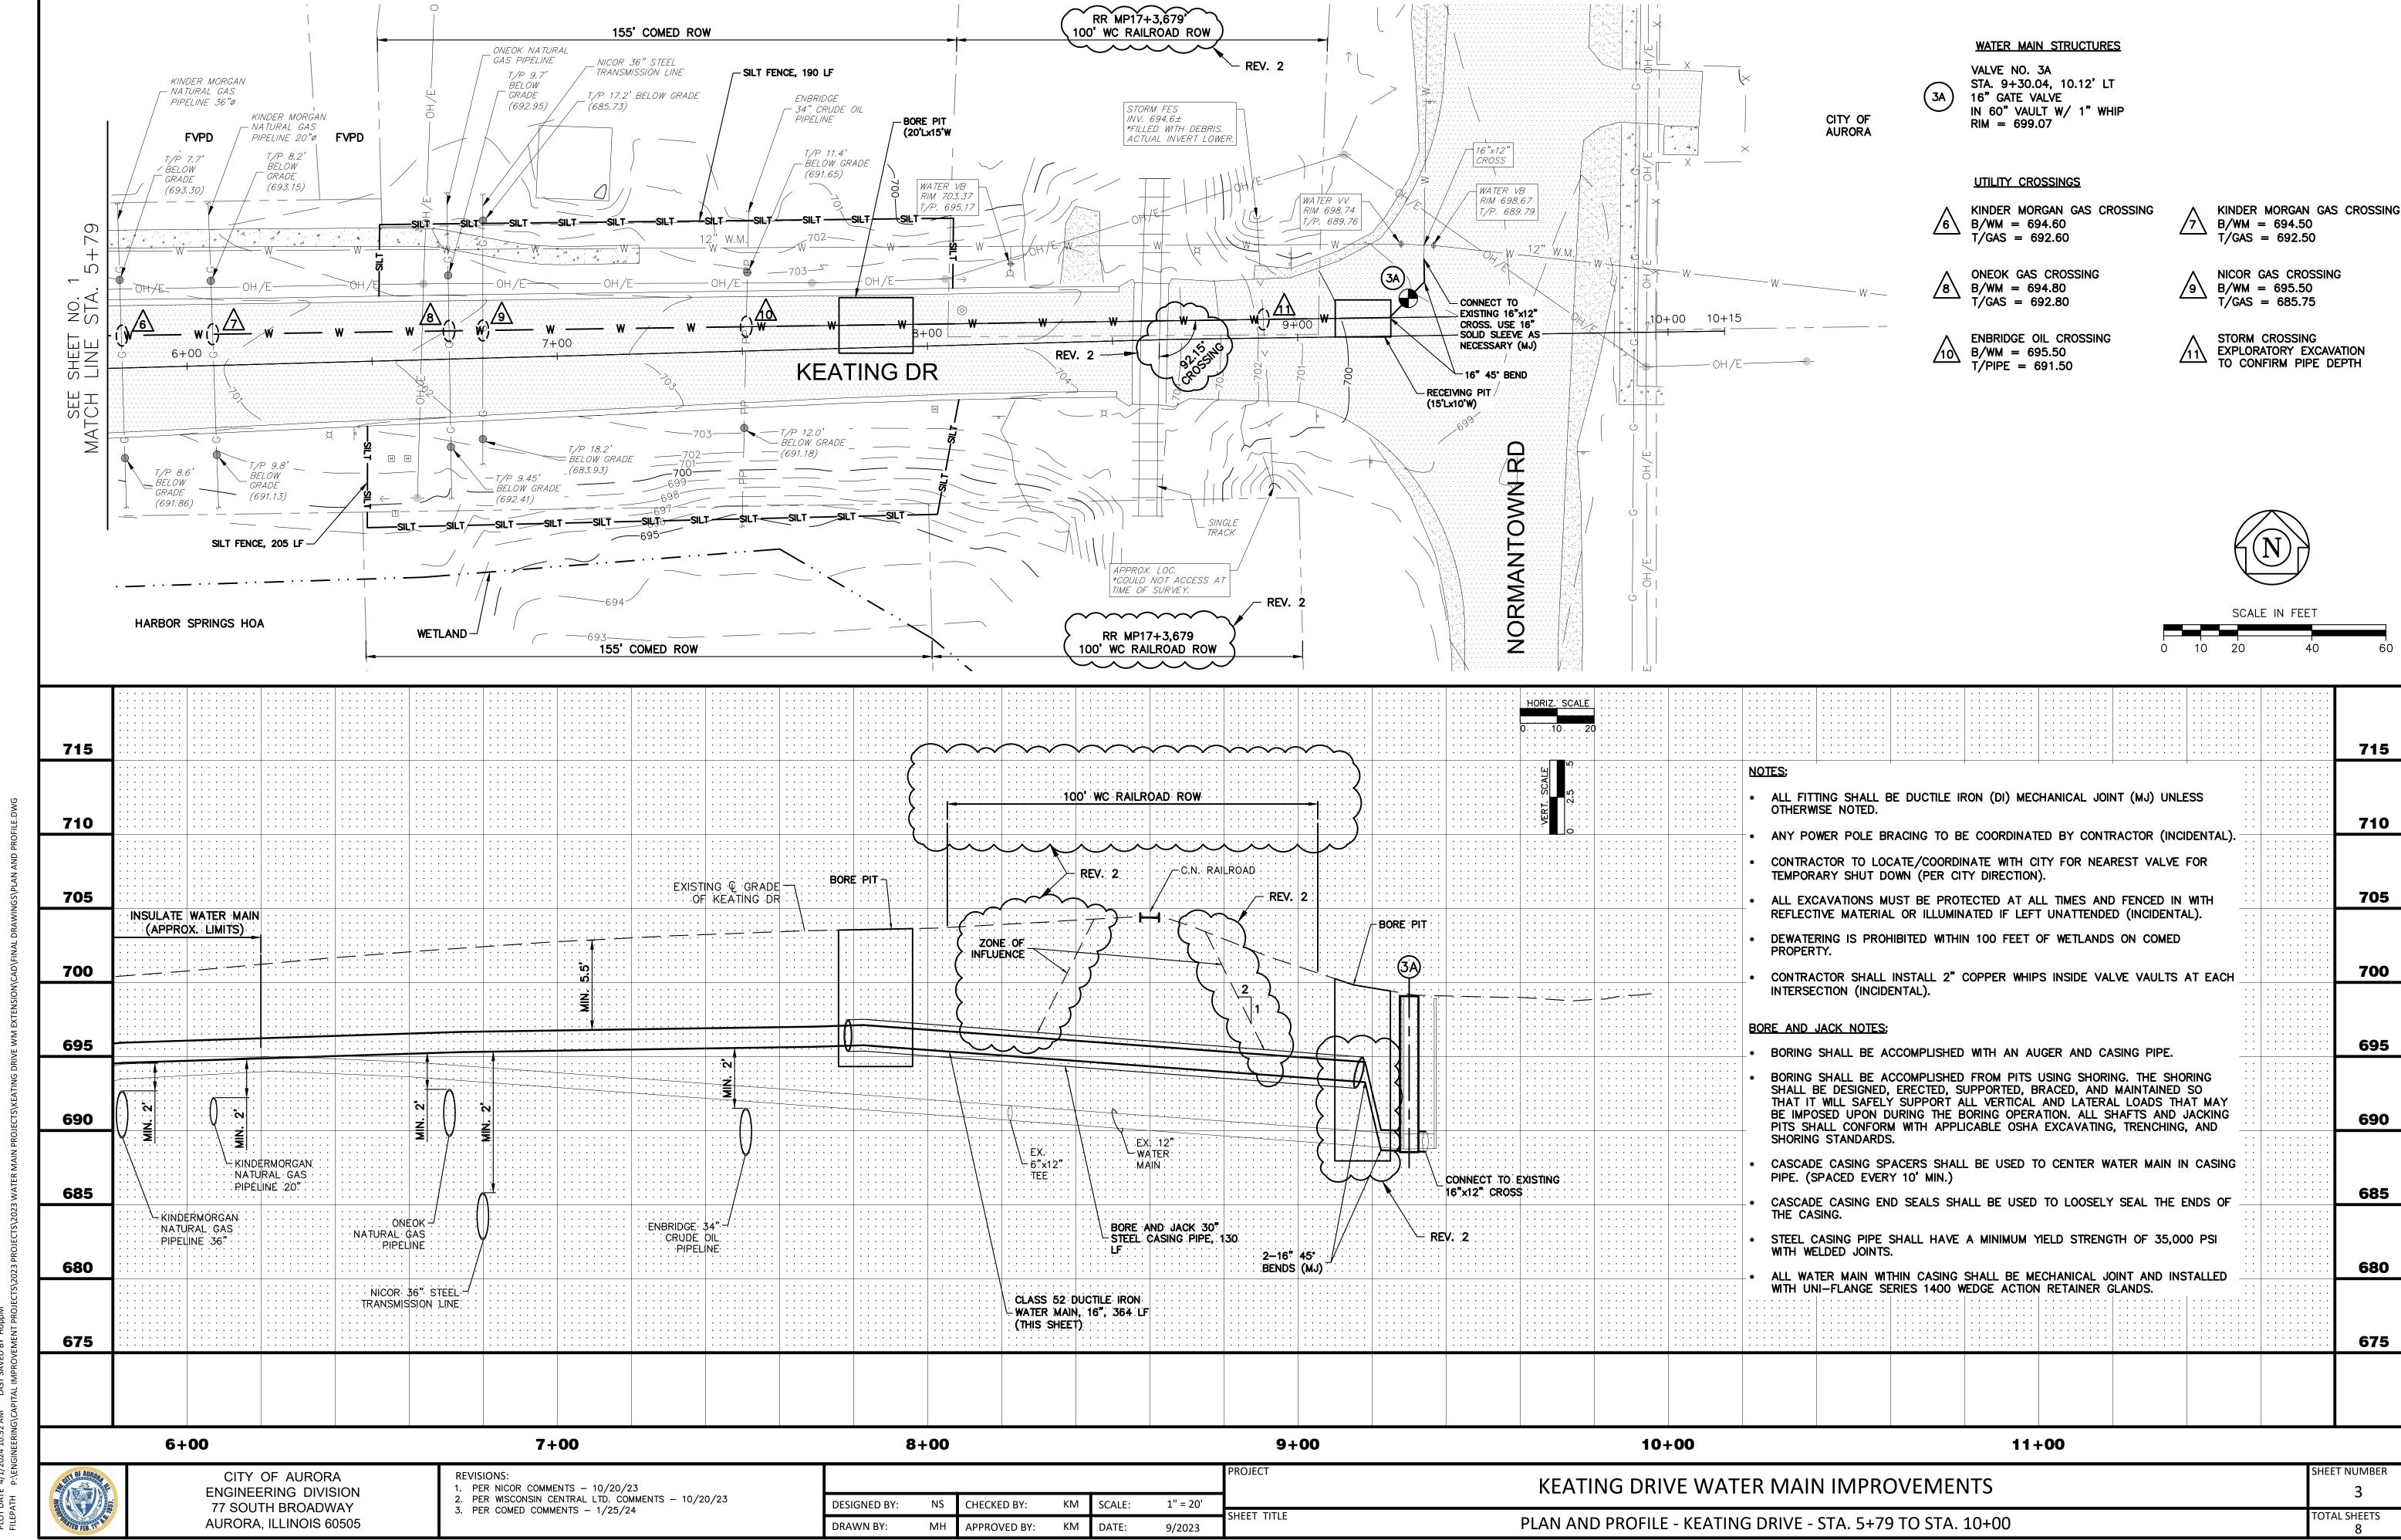

PLOT DATE 4/1/2024 10:52 AM LAST SAVED BY HOPPM

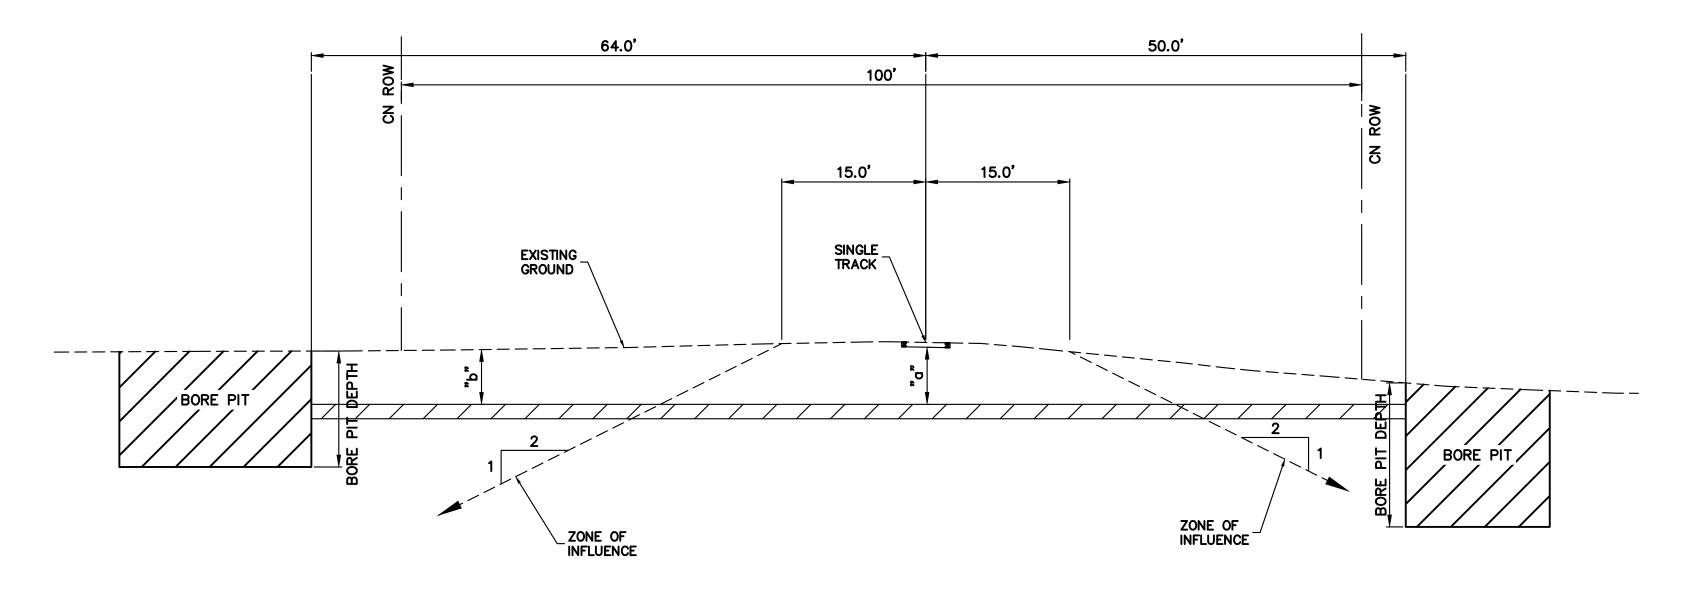

MINIMUM DEPTH	DRY JACK	& BORE	DIRECTIONAL				
BELOW	CASED	UNCASE	BORE				
BASE OF RAIL (a)	6'	10'	15'				
EXISTING GROUND (b)	5'	6'	6'				
FLOWLINE DITCH (c)	5'	6'	6'				


REQUIREMENTS:


- NO EXCAVATION CAN BE CLOSER THAN 25' FROM CENTERLINE OF NEAREST TRACK.
- 2. IF THE EXCAVATION IS INSIDE THE ZONE OF INFLUENCE THEN SHORING PLANS ARE REQUIRED AND MUST INCLUDE THE LIVE E80 LOADING FROM PASSING TRAINS.
- 3. THE ZONE OF INFLUENCE IS DESCRIBED AS 15' FROM CENTERLINE THEN A 2:1 SLOPE OUTWARD.
- 4. IF EXCAVATION IS OUTSIDE OF ZONE OF INFLUENCE THEN EXCAVATION SHALL FOLLOW OSHA REQUIREMENTS.

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	TED FEB.	III I

PROJECT




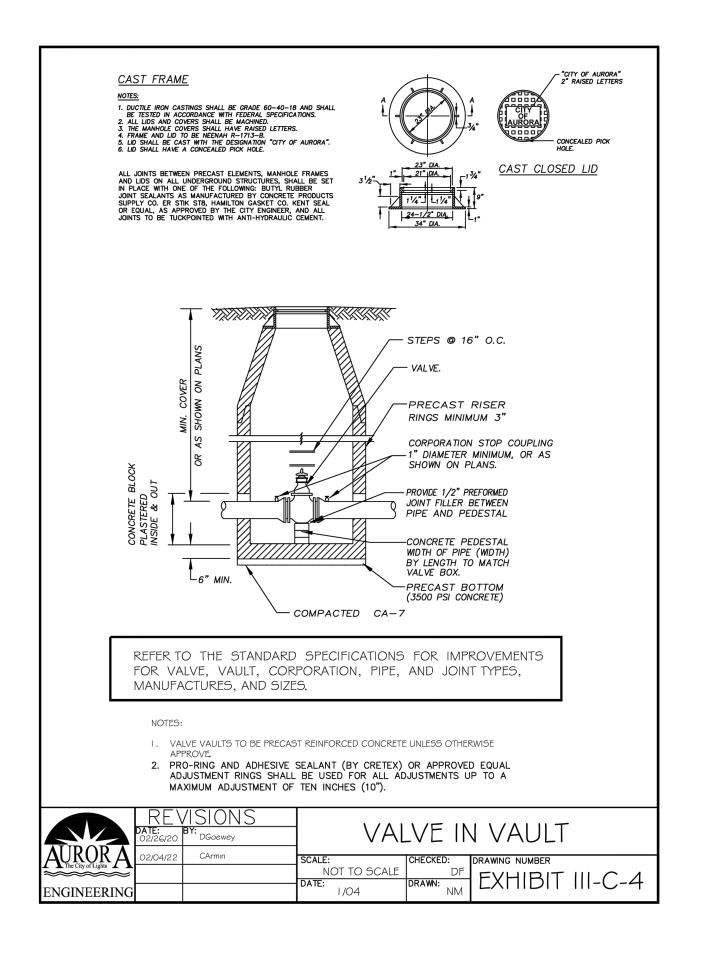


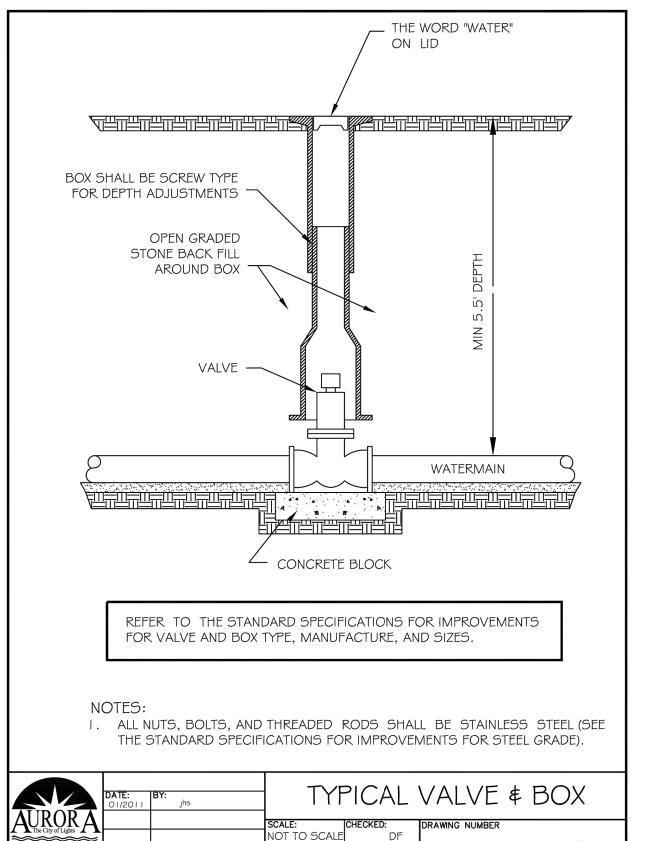



1/04


ENGINEERING

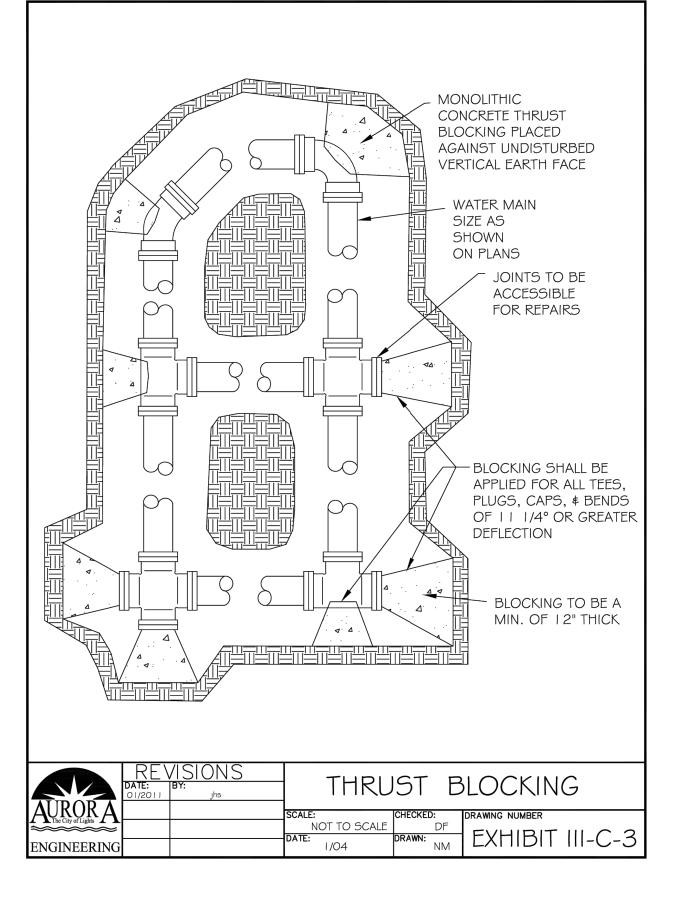


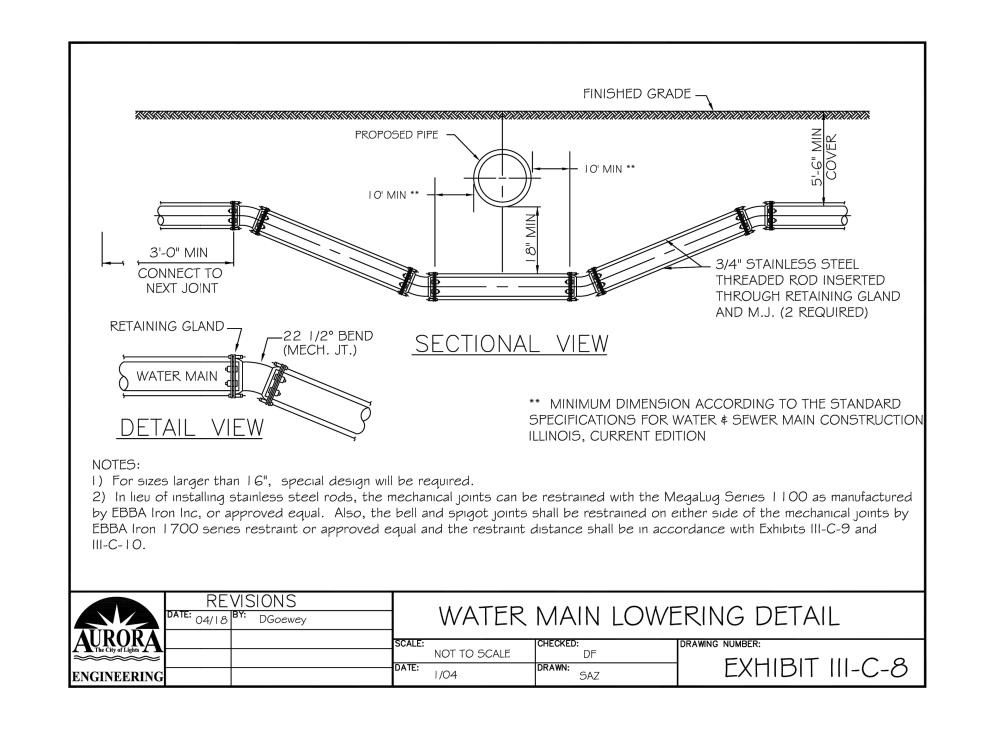

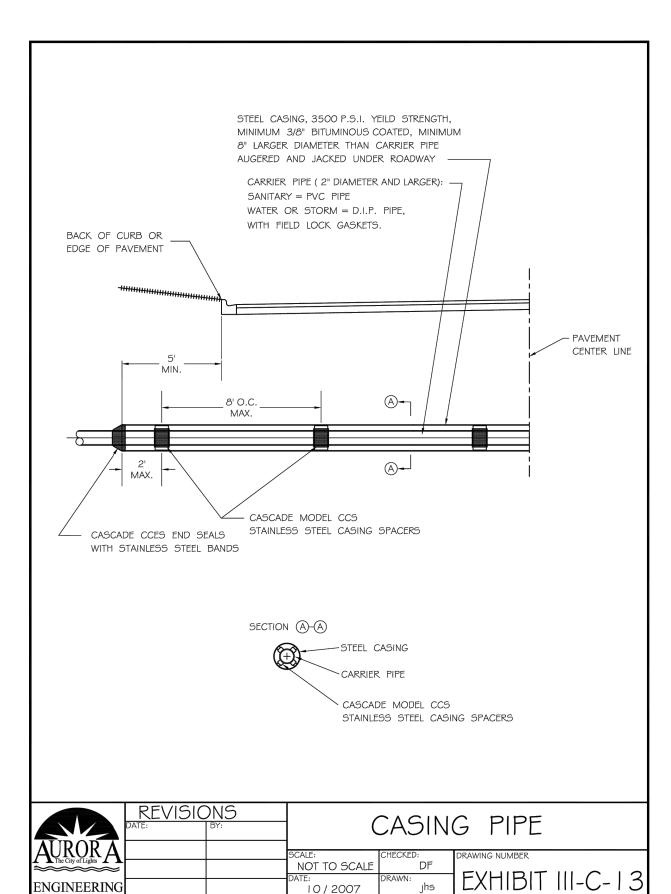

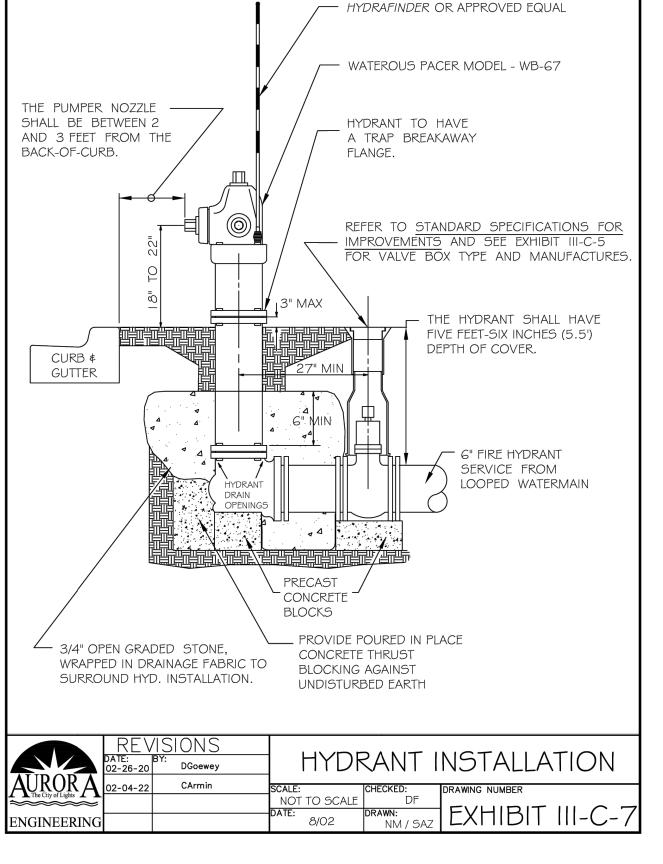

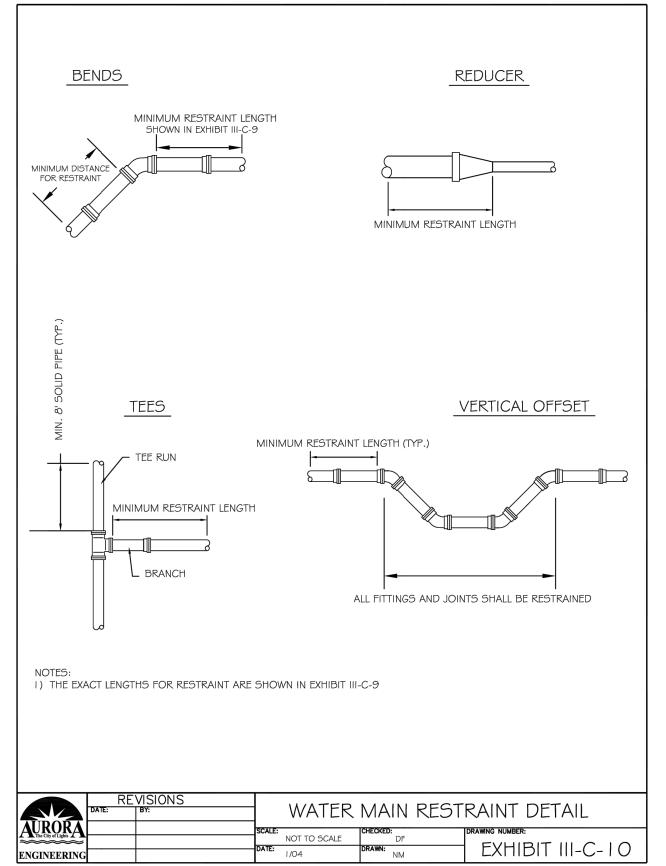

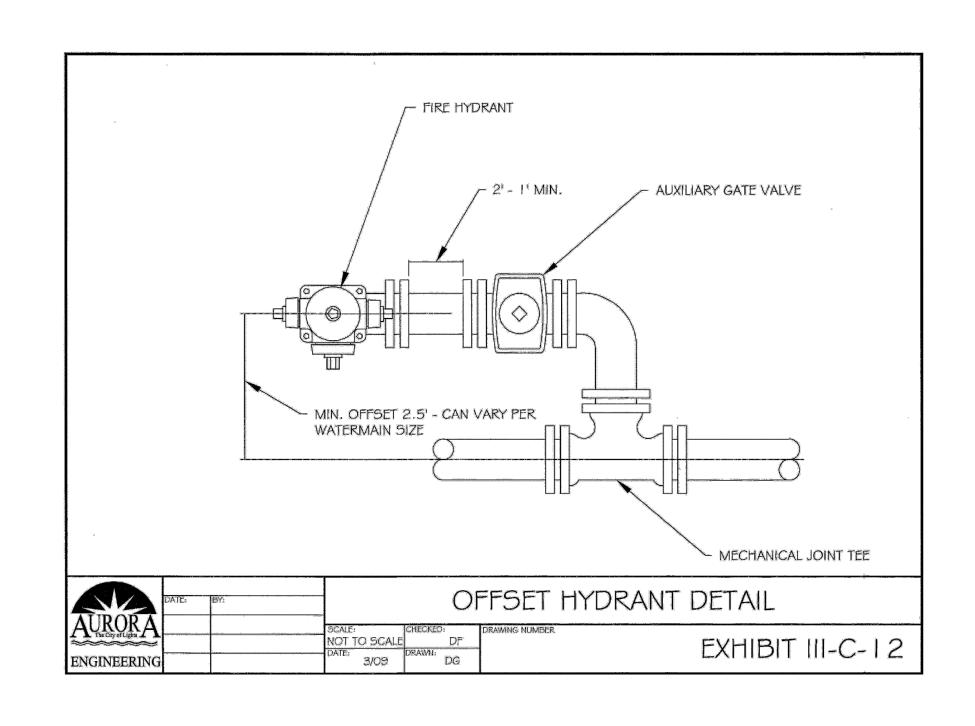



ENGINEERING

CITY OF AURORA **ENGINEERING DIVISION** 77 SOUTH BROADWAY AURORA, ILLINOIS 60505 **REVISIONS:**

PROJECT CHECKED BY: SCALE: N.T.S. DESIGNED BY: KM SHEET TITLE DRAWN BY: DATE: APPROVED BY: 9/2023

KEATING DRIVE WATER MAIN IMPROVEMENTS

SHEET NUMBER TOTAL SHEETS

STANDARD DETAILS

Minimum Restraint Length (ft) on both sides of the Fitting

16"

11

23

56

74

67

¹ All joints within the lowered section of the watermain shall be restrained or shall be solid pipe. The above distances reflect the required restraint distance on the normally elevated watermain either side of the 45° Fitting of the vertical offset (or lowering).


² Minimum of 8 ft of solid pipe is required on both sides of the fitting on the run side. Distance indicates the length of restraint on the branch side or the side perpendicular to the tee run watermain.


³ Indicates the distance from the larger end of the reducer.

Notes: 1) All nuts and bolts shall be stainless steel.

2) The Entire restraint system from the fitting to the minimum restraint distance must be Inspected by The City of Aurora or it's representative prior to backfilling.

The City of	i i i di ci di c	or it broprobein	acric prior	to oddinining	,•					
	Re	evisions		Watermaii	in Restraint Length Table					
ALIDODA	Date:	By:			<u> </u>					
AURUKA The City of Lights			Scale:	Checked						
~~~~~~ <u>~~</u>			None	PJH	EXHIBIT III-C-9					
Engineering			Date:	Drawn:	EAHIBIT III-C-9					
Department			2/04	DF						

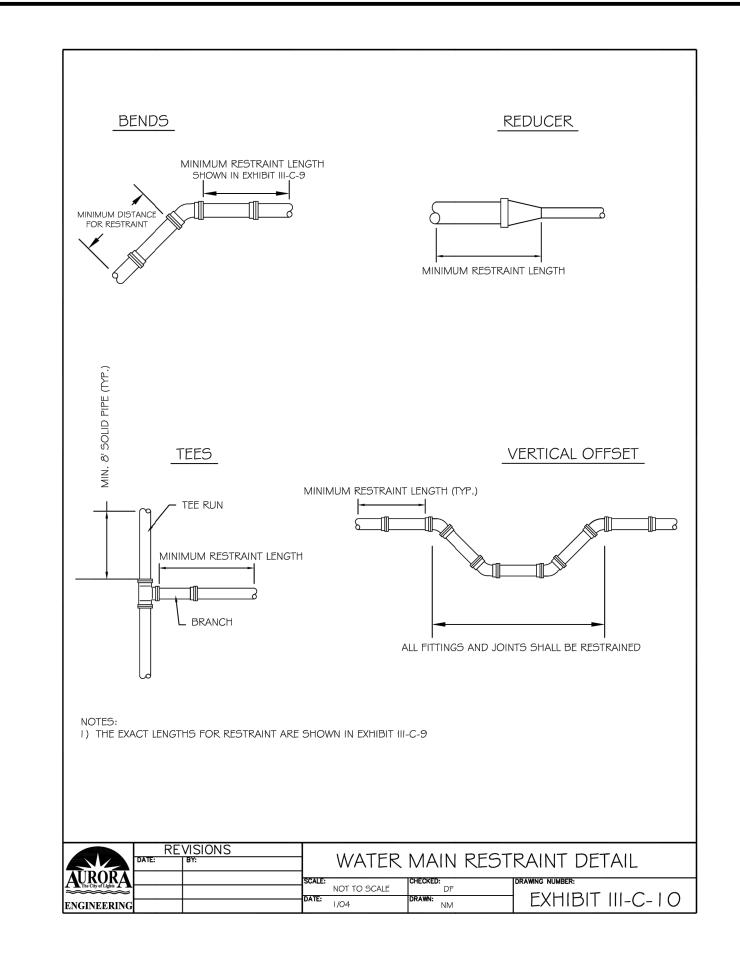

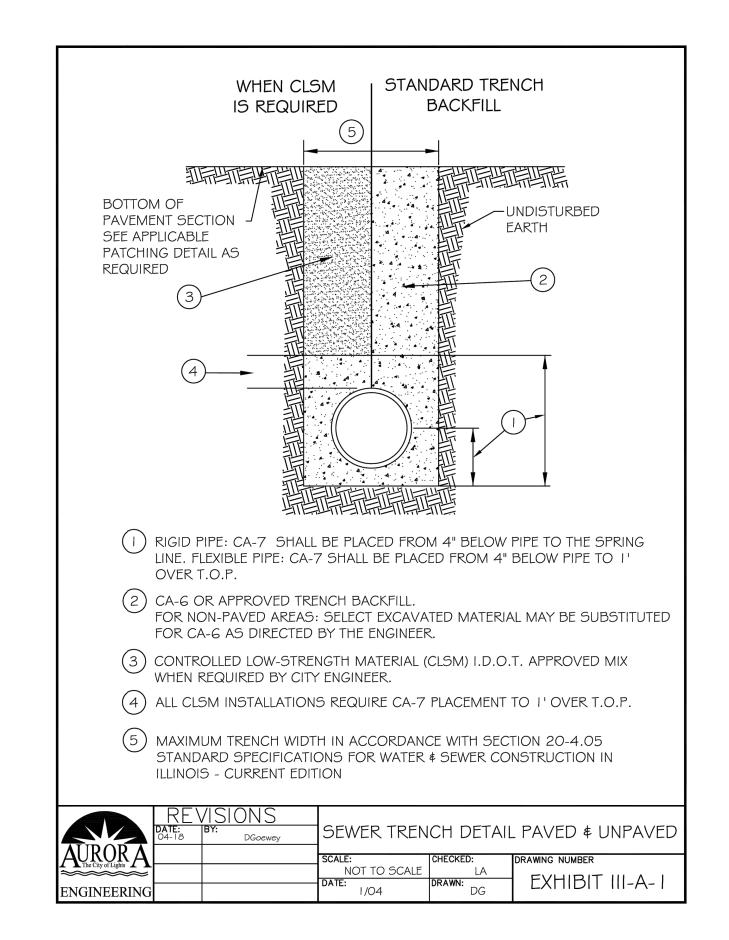

WATER MAINS AND WATER SERVICE LINES SHALL BE PROTECTED FROM SANITARY SEWERS, STORM SEWERS, COMBINED SEWERS, HOUSE SEWER SERVICE CONNECTIONS AND DRAINS AS FOLLOWS:

- A) WATER MAINS:
- 1) HORIZONTAL SEPARATION:
- A) WATER MAINS SHALL BE LAID AT LEAST TEN FEET HORIZONTALLY FROM ANY EXISTING OR PROPOSED DRAIN, STORM SEWER. SANITARY SEWER. COMBINED SEWER OR SEWER SERVICE CONNECTION.
- B) WATER MAINS MAY BE LAID CLOSER THAN TEN FEET TO A SEWER LINE WHEN:
- I) LOCAL CONDITIONS PREVENT A LATERAL SEPARATION OF TEN
- II) THE WATER MAIN INVERT IS AT LEAST 18 INCHES ABOVE THE CROWN OF THE SEWER; AND
- III) THE WATERMAIN IS EITHER IN A SEPARATE TRENCH OR IN THE SAME TRENCH ON AN UNDISTURBED EARTH SHELF LOCATED TO ONE SIDE OF THE SEWER.
- C) BOTH THE WATER MAIN AND DRAIN OR SEWER SHALL BE CONSTRUCTED OF SLIP-ON OR MECHANICAL JOINT CAST OR DUCTILE IRON PIPE, ASBESTOS-CEMENT PRESSURE PIPE, PRESTRESSED CONCRETE PIPE, OR PVC PIPE MEETING THE REQUIREMENTS OF SECTION 653.111 WHEN IT IS IMPOSSIBLE TO MEET (A) OR (B) ABOVE. THE DRAIN OR SEWER SHALL BE PRESSURE TESTED TO THE MAXIMUM EXPECTED SURCHARGE HEAD BEFORE BACKFILLING.
- 2) VERTICAL SEPARATION:
- A) A WATER MAIN SHALL BE LAID SO THAT ITS INVERT IS 18 INCHES ABOVE THE CROWN OF THE DRAIN OR SEWER WHENEVER WATER MAINS CROSS STORM SEWERS, SANITARY SEWERS OR SEWER SERVICE CONNECTIONS. THE VERTICAL SEPARATION SHALL BE MAINTAINED FOR THAT PORTION OF THE WATER MAIN LOCATED WITHIN TEN FEET HORIZONTALLY OF ANY SEWER OR DRAIN CROSSED. A LENGTH OF WATER MAIN PIPE SHALL BE CENTERED OVER THE SEWER TO BE CROSSED WITH JOINTS EQUIDISTANT FROM THE SEWER OR DRAIN.
- B) BOTH THE WATER MAIN AND SEWER SHALL BE CONSTRUCTED OF SLIP-ON OR MECHANICAL JOINT CAST OR DUCTILE IRON PIPE. ASBESTOS-CEMENT PRESSURE PIPE, PRESTRESSED CONCRETE PIPE, OR PVC PIPE MEETING REQUIREMENTS OF SECTION 653.111 WHEN:
- I) IT IS IMPOSSIBLE TO OBTAIN THE PROPER VERTICAL SEPARATION AS DESCRIBED IN (A) ABOVE; OR
- II) THE WATER MAIN PASSES UNDER A SEWER OR DRAIN.
- C) A VERTICAL SEPARATION OF 18 INCHES BETWEEN THE INVERT OF THE SEWER OR DRAIN AND THE CROWN OF THE WATER MAIN SHALL BE MAINTAINED WHERE A WATER MAIN CROSSES UNDER A SEWER. SUPPORT THE SEWER OR DRAIN LINES TO PREVENT SETTLING AND BREAKING THE WATER MAIN.
- D) CONSTRUCTION SHALL EXTEND ON EACH SIDE OF THE CROSSING UNTIL THE NORMAL DISTANCE FROM THE WATER MAIN TO THE SEWER OR DRAIN LINE IS AT LEAST TEN FEET.
- B) WATER SERVICE LINES:
- 1) THE HORIZONTAL AND VERTICAL SEPARATION BETWEEN WATER SERVICE LINES AND ALL STORM SEWERS. SANITARY SEWERS. COMBINED SEWERS OR ANY DRAIN OR SEWER SERVICE CONNECTION SHALL BE THE SAME AS WATER MAIN SEPARATION DESCRIBED IN (A) ABOVE.
- 2) WATER PIPE DESCRIBED IN (A) ABOVE SHALL BE USED FOR SEWER SERVICE LINES WHEN MINIMUM HORIZONTAL AND VERTICAL SEPARATION CANNOT BE MAINTAINED.
- C) SPECIAL CONDITIONS ALTERNATE SOLUTIONS SHALL BE PRESENTED TO THE AGENCY WHEN EXTREME TOPOGRAPHICAL. GEOLOGICAL OR EXISTING STRUCTURAL CONDITIONS MAKE STRICT COMPLIANCE WITH (A) AND (B) ABOVE TECHNICALLY AND ECONOMICALLY IMPRACTICAL. ALTERNATE SOLUTIONS WILL BE APPROVED PROVIDED WATERTIGHT CONSTRUCTION STRUCTURALLY EQUIVALENT TO APPROVED WATER MAIN MATERIAL IS PROPOSED.
- D) WATER MAINS SHALL BE SEPARATED FROM SEPTIC TANKS, DISPOSAL FIELDS AND SEEPAGE BEDS BY A MINIMUM OF 25 FEET.
- E) WATER MAINS AND WATER SERVICE LINES SHALL BE PROTECTED AGAINST ENTRANCE OF HYDROCARBONS THROUGH DIFFUSION THROUGH ANY MATERIAL USED IN CONSTRUCTION OF THE LINE.

CITY OF AURORA **ENGINEERING DIVISION** 77 SOUTH BROADWAY AURORA, ILLINOIS 60505

CHECKED BY: KM SCALE: APPROVED BY: KM DATE:


SHEET NUMBER


ROJECT **REVISIONS:** KEATING DRIVE WATER MAIN IMPROVEMENTS N.T.S. SHEET TITLE TOTAL SHEETS STANDARD DETAILS DRAWN BY: 9/2023


# CURB AND GUTTER GENERAL NOTES:

- Contraction joints shall be placed ten (10) feet on centers and shall be saw cut to a minimum depth of two (2) inches from front to back within twenty four (24) hours of concrete placement.
- 2. The concrete material, curing, protection, and placement for all curb, combination curb and gutter or, depressed curb and gutter shall meet the requirements of Articles 606,1020, 1021, 1022, and 1023 of the State of Illinois "Standard Specifications for Road and Bridge Construction", latest edition. Membrane curing and concrete sealing shall be accompanied by W.R. Meadows CS-309 Cure and Seal or approved equal like Okon S-20. If the forecast indicates temperatures below 32° F, protection methods shall be installed in accordance with the Standard Specifications for Road and Bridge Construction and shall be approved by the City Engineer.
- 3. The minimum longitudinal curb slope shall be 0.40%.
- 4. Cuts into the existing curb shall be made full depth with full expansion joints drilled at each per Exhibit II-C-12 herein.

	RE\ DATE: 01/2011	VISIONS BY: Jhs	CURB AND GUTTER GENERAL NOTES SCALE:   CHECKED:   DRAWING NUMBER							
AUROR A	02/2013	DG								
******			DATE		DDAY (N.	EVHIBIT II C 5				
<b>ENGINEERING</b>			DATE:	03/08	DRAWN: J. MOORE	LXIIIDII II-C-3				

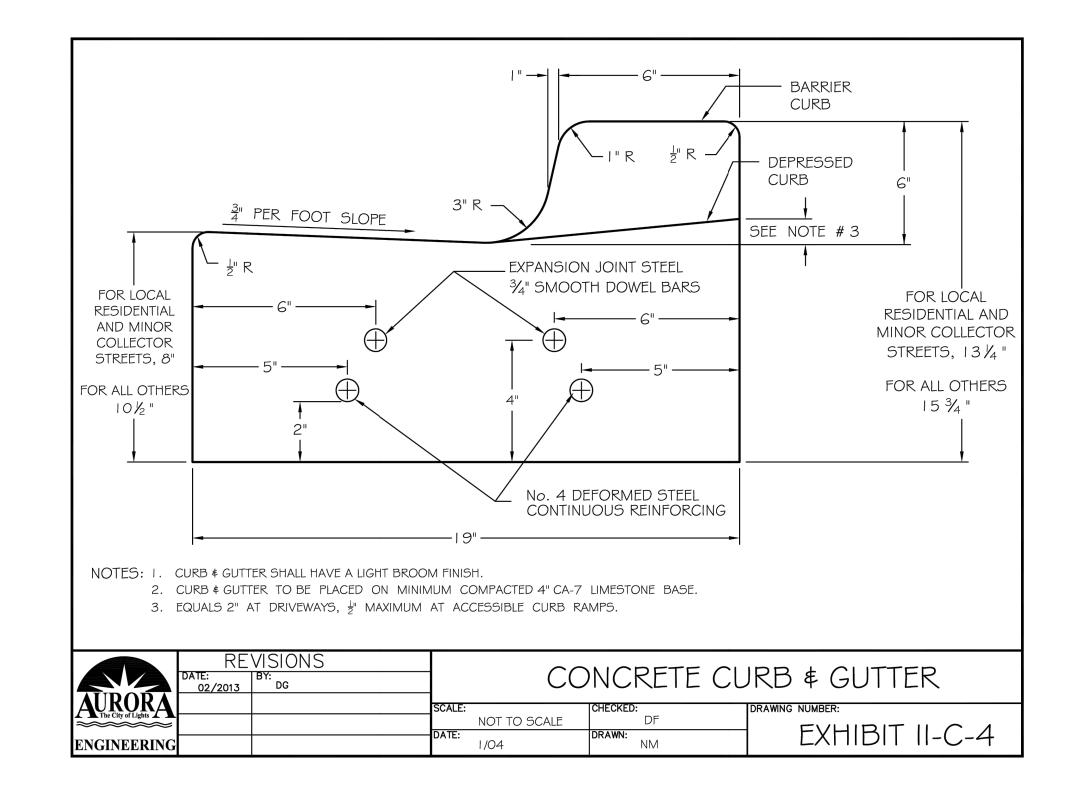

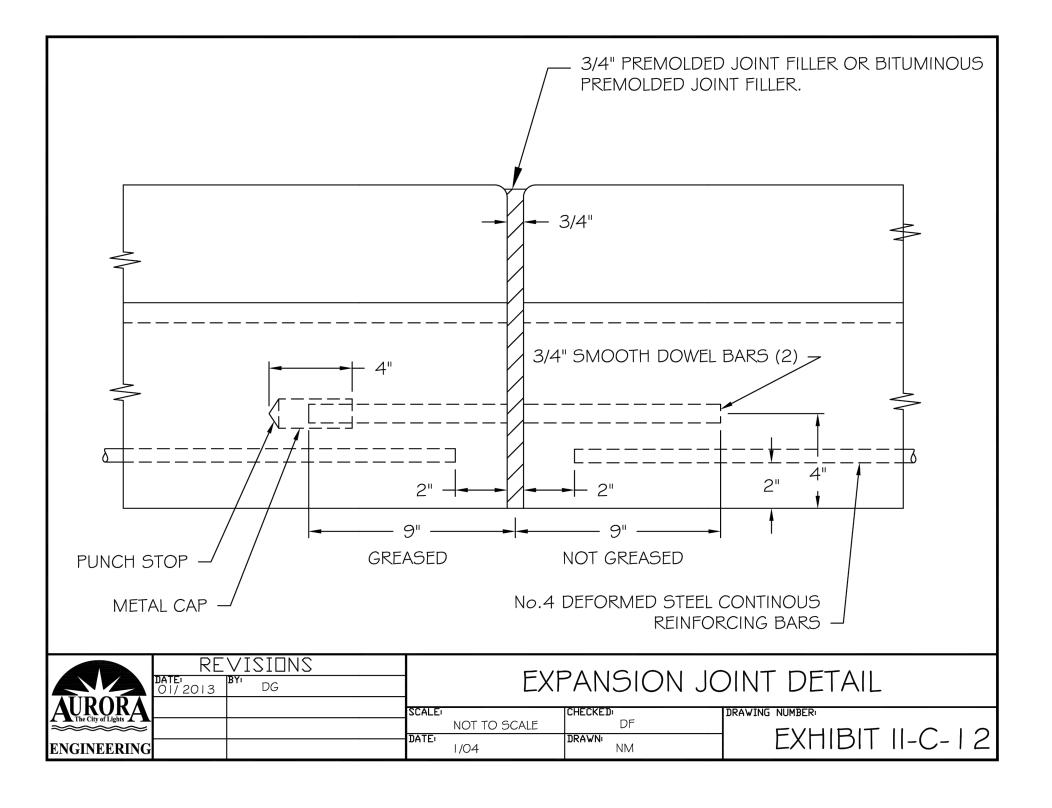

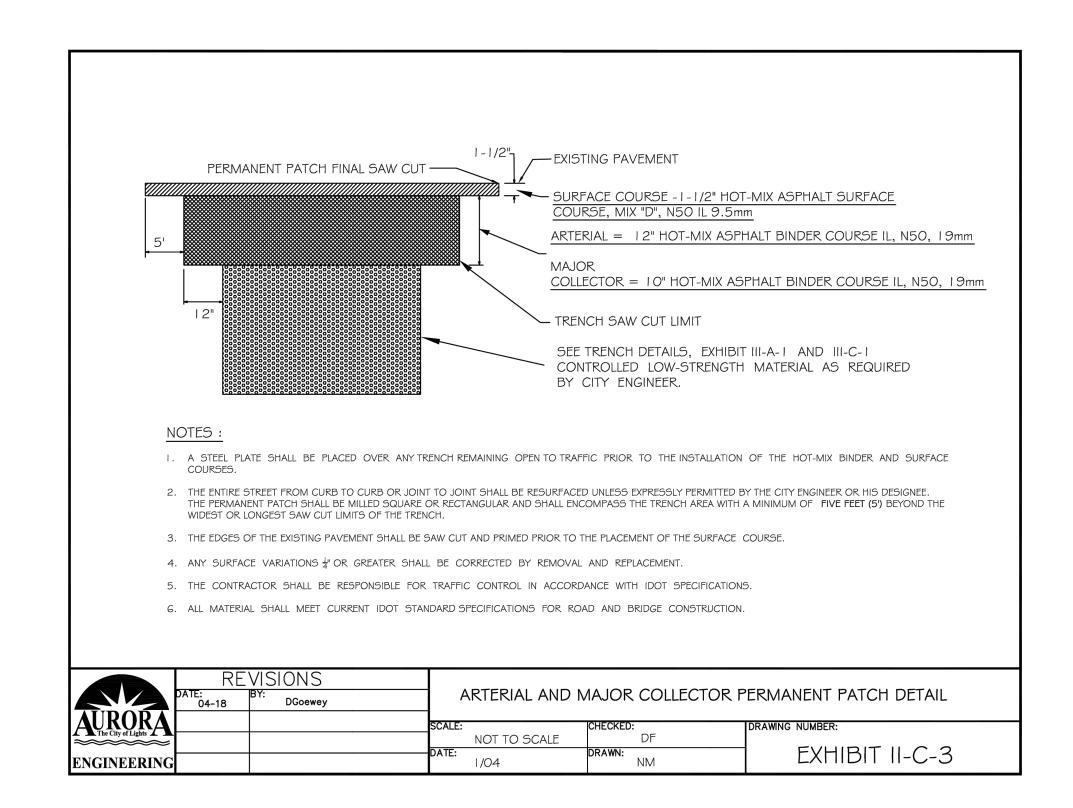



CITY OF AURORA ENGINEERING DIVISION 77 SOUTH BROADWAY AURORA, ILLINOIS 60505

**REVISIONS:** 

DESIGNED BY: NS CHECKED BY: KM SCALE: N.T.S.

DRAWN BY: MH APPROVED BY: KM DATE: 9/2023


N.T.S.
SHEET TITLE

KEATING DRIVE WATER MAIN IMPROVEMENTS

STANDARD DETAILS

SHEET NUMBER

TOTAL SHEETS 8

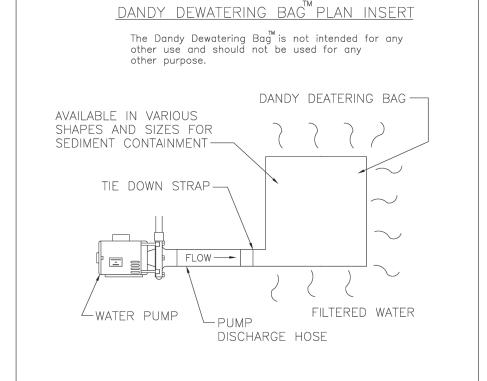

The Dandy Dewatering Bag[™] is designed to control sediment discharge in dewatering applications where water is being pumped.

- 1. Lifting straps, not included, should be placed under the Dandy Dewatering Bag[™] to facilitate removal
- 2. Place the Dandy Dewatering Bag[™]on a level stabilized area over dense vegetation/straw, or Gravel (if increased drainage surface area is needed) or as detailed in plans.
- 3. Insert discharge hose from pump into the Dandy Dewatering Bag[™] a minimum of six inches (6") and tightly secure with attached strap to prevent water from flowing out of the unit without being filtered.
- 4. Replace the unit when one half (1/2) full of sediment or when sediment has reduced the flow rate of the pump discharge to an impractical rate.


### <u>Maintenance</u>


Remove and dispose of the sediment in a manner satisfactory to the engineer/inspector or in one of the following ways:


- 1. Remove the unit and sediment from environmentally sensitive area and waterways. At the approved disposal site open or slit unit, remove sediment and grade smoothly into existing topography. Dispose of the Dandy Dewatering Bag,™ no longer in use, at an appropriate recycling or solid waste facility.
- 2. Bury unit on site; remove visible fabric and seed.

DANDY PRODUCTS, INC. 2011 HARRISBURG PIKE, SUITE R GROVE CITY, OHIO 43123

1-800-591-2284 (local) 614-875-2284 FAX: 614-875-6305 E-MAIL: dandy@dandyproducts.com

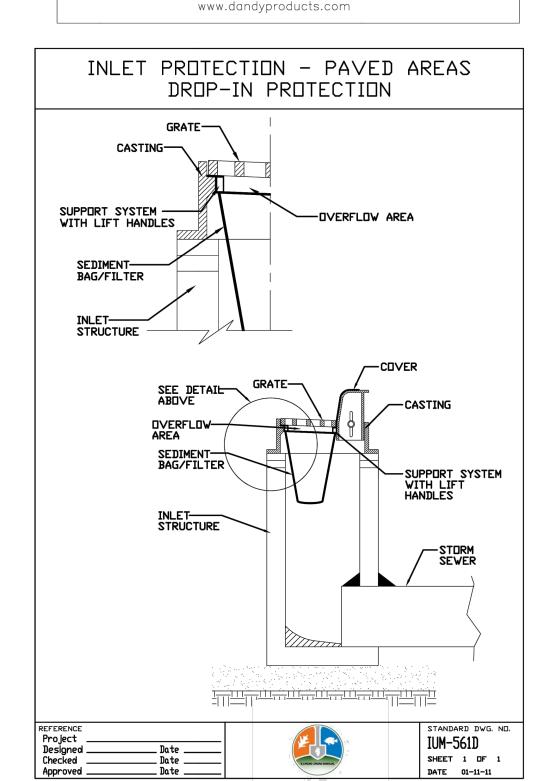

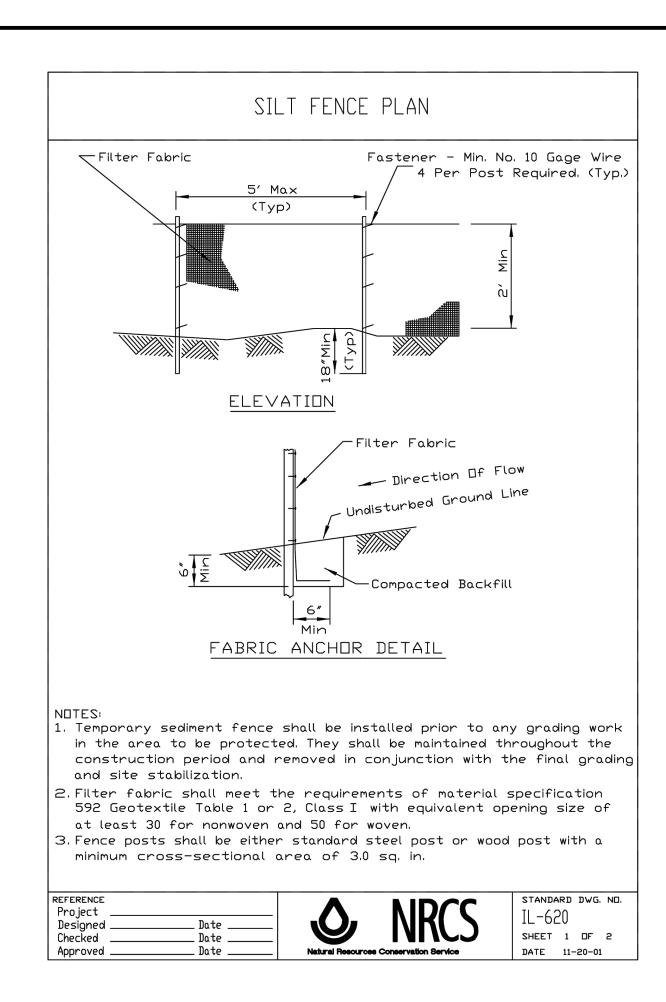

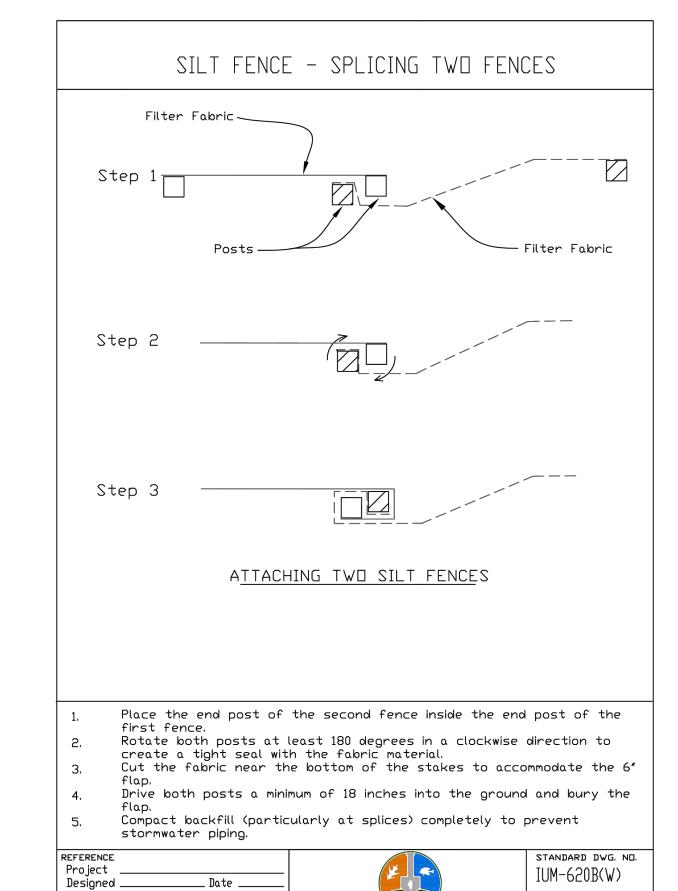

#### KANE-DUPAGE SOIL AND WATER CONSERVATION DISTRICT STANDARD NOTES

UNLESS OTHERWISE INDICATED, ALL VEGETATIVE AND STRUCTURAL EROSION AND SEDIMENT CONTROL PRACTICES WILL BE CONSTRUCTED ACCORDING TO MINIMUM STANDARDS AND SPECIFICATIONS IN THE ILLINOIS URBAN MANUAL REVISED FEBRUARY 2002.

THE KANE-DUPAGE SOIL AND WATER CONSERVATION DISTRICT(KDSWCD) MUST BE NOTIFIED ONE WEEK PRIOR TO THE PRE-CONSTRUCTION CONFERENCE, ONE WEEK PRIOR TO THE COMMENCEMENT OF LAND DISTURBING ACTIVITIES, AND ONE WEEK PRIOR TO THE FINAL INSPECTION.

A COPY OF THE APPROVED EROSION AND SEDIMENT CONTROL PLAN SHALL BE MAINTAINED ON THE SITE AT ALL

PRIOR TO COMMENCING LAND DISTURBING ACTIVITIES IN AREAS OTHER THAN INDICATED ON THESE PLANS (INCLUDING BUT NOT LIMITED TO , ADDITIONAL PHASES OF DEVELOPMENT AND OFF-SITE BORROW OR WASTE AREAS) A SUPPLEMENTARY EROSION CONTROL PLAN SHALL BE SUBMITTED TO THE OWNER FOR REVIEW BY

THE CONTRACTOR IS RESPONSIBLE FOR INSTALLATION OF ANY ADDITIONAL EROSION CONTROL MEASURES NECESSARY TO PREVENT EROSION AND SEDIMENTATION AS DETERMINED BY THE KDSWCD.

DURING DEWATERING OPERATIONS, WATER WILL SHALL BE PUMPED INTO SEDIMENT BASINS OR SILT TRAPS. DEWATERING DIRECTLY INTO FIELD TILES OR STORM WATER STRUCTURES IS PROHIBITED. IT IS THE RESPONSIBILITY OF THE LANDOWNER AND/OR GENERAL CONTRACTOR TO INFORM AND SUB-CONTRACTOR(S) WHO MAY PERFORM WORK ON THIS PROJECT, OF THE REQUIREMENTS IN IMPLEMENTING AND MAINTAINING THESE EROSION CONTROL PLANS AND THE NATIONAL POLLUTANT DISCHARGE ELIMINATION SYSTEM (NPDES) PERMIT REQUIREMENTS SET FORTH BY THE ILLINOIS EPA.

ALL DROP INLETS ON OR ADJACENT TO THE SITE MUST HAVE A SEDIMENT TRAPPING OR CONTAINMENT DEVICE INSTALLED DURING CONSTRUCTION ACTIVITIES.

ALL ADJACENT STREETS SHALL BE KEPT CLEAR OF DEBRIS, INSPECTED DAILY, AND CLEANED WHEN

ALL EROSION CONTROL MEASURES SHALL BE INSPECTED WEEKLY AND AFTER EACH RAINFALL EVENT OF 0.5"

IN AREAS WHERE WORK IS COMPLETE, PERMANENT STABILIZATION SHALL OCCUR WITHIN 7 DAYS OF COMPLETION, AND IN AREAS WHERE WORK HAS TEMPORARILY CEASED FOR 21 DAYS OR MORE, TEMPORARY STABILIZATION SHALL OCCUR BY THE 14TH DAY AFTER WORK HAS CEASED.

THE CONDITION OF THE CONSTRUCTION SITE FOR WINTER SHUTDOWN SHALL BE ADDRESSED EARLY IN THE FALL GROWING SEASON SO THAT SLOPES AND OTHER BARE EARTH AREAS MAY BE STABILIZED WITH TEMPORARY AND/OR PERMANENT VEGETATIVE COVER FOR PROPER EROSION AND SEDIMENT CONTROL. ALL OPEN AREAS THAT ARE TO REMAIN IDLE THROUGHOUT THE WINTER SHALL RECEIVE TEMPORARY EROSION CONTROL MEASURES INCLUDING TEMPORARY SEEDING, MULCHING, AND/OR EROSION CONTROL BLANKET PRIOR TO THE END OF THE FALL GROWING SEASON. THE AREAS TO BE WORKED BEYOND THE END OF THE GROWING SEASON MUST INCORPORATE SOIL STABILIZATION MEASURES THAT DO NOT RELY ON VEGETATIVE COVER SUCH AS EROSION CONTROL BLANKET AND HEAVY MULCHING.

#### SOIL STABILIZATION TABLE

### REQUIRED FOR ALL DISTURBED GRASS AREAS

### CITY OF AURORA MIX

✓ 24.93% ASAP PERENIAL RYEGRASS 24.46 % CADDIESHACK PERENNIAL RYGRASS 24.33% GOALKEEPER PERENNIAL RYEGRASS 12.37% GERONIMO KENTUCKY BLUEGRASS 12.29% KENTUCKY BLUEGRASS (VARIETY NOT STATED) 1.34% INERT MATTER 0.28% CROP √ 0.00% WEED

> MECHANICALLY CRIMPED STRAW OR HYDRO-MULCH

### CONTRACTOR'S CERTIFICATION:

I CERTIFY UNDER PENALTY OF LAW THAT I UNDERSTAND THE TERMS AND CONDITIONS OF THE GENERAL NATIONAL POLLUTION DISCHARGE ELIMINATION SYSTEM (NPDES) PERMIT (ILR10) THAT AUTHORIZES THE STORM WATER DISCHARGES ASSOCIATED WITH INDUSTRIAL ACTIVITY FROM THE CONSTRUCTION SITE IDENTIFIED AS PART OF THIS CERTIFICATION

SIGNED PRINT NAME

NAME OF COMPANY

### SEQUENCE OF CONSTRUCTION ACTIVITIES

- 1. INSTALL EROSION CONTROL MEASURES
- 2. CONSTRUCT WATER MAIN
- 3. BACKFILL WATER MAIN BORE PITS AND TRENCH
- 4. RESTORE AREAS DISTURBED BY CONSTRUCTION WITH HOT-MIX ASPHALT, CONCRETE, OR APPROPRIATE SEEDING
- 5. REMOVE TEMPORARY EROSION CONTROL MEASURES ONCE VEGETATION HAS BEEN ESTABLISHED.

#### **EROSION AND SEDIMENT CONTROLS**

REFER TO THE PLAN AND PROFILE SHEETS IN THIS PLAN SET.

EROSION AND SEDIMENT CONTROL MUST BE INSTALLED PER ILLINOIS URBAN MANUAL

TEMPORARY SEEDING - AS NEEDED PER DETAIL

PERMANENT SEEDING - PER PLAN

VEGETATION FILTERS - PRESERVE EXISTING GRASS AND VEGETATION DOWNSTREAM OF IMPROVEMENTS TO ACT AS VEGETATIVE FILTER.

ADDITIONAL EROSION AND SEDIMENT CONTROLS WILL BE INSTALLED AT THE DIRECTION OF THE CITY OR RESIDENT ENGINEER.

PERMANENT STABILIZATION - ALL DISTURBED AREAS WILL BE SEEDED, FERTILIZED, AND BLANKETED.

SEEDING SCHEDULE	NAN	FEB	MARCH	APRIL	MAY	JUNE	JULY	AUG	SEPT	ОСТ	NOV	DEC
PERMANENT SEEDING MIXTURE												
NON IRRIGATED												
IRRIGATED												
DORMANT (DOUBLE RATE)												
TEMPORARY SEEDING MIXTURE												
RYE OR WHEAT												
OATS												
MULCHING												

SHEET NUMBER ROJECT KEATING DRIVE WATER MAIN IMPROVEMENTS CHECKED BY: SCALE: N.T.S. DESIGNED BY: ΚM TOTAL SHEETS SHEET TITLE STORM WATER POLLUTION PREVENTION PLAN DATE: APPROVED BY: 9/2023



CITY OF AURORA **ENGINEERING DIVISION** 77 SOUTH BROADWAY AURORA, ILLINOIS 60505 **REVISIONS:** 

Checked

Approved _

_ Date .

DRAWN BY:

SHEET 1 OF 1

DATE 3-16-2012