

# Aerial







# **Gramercy & Chelsea Comparison**



#### Chelsea Manor Site Plan

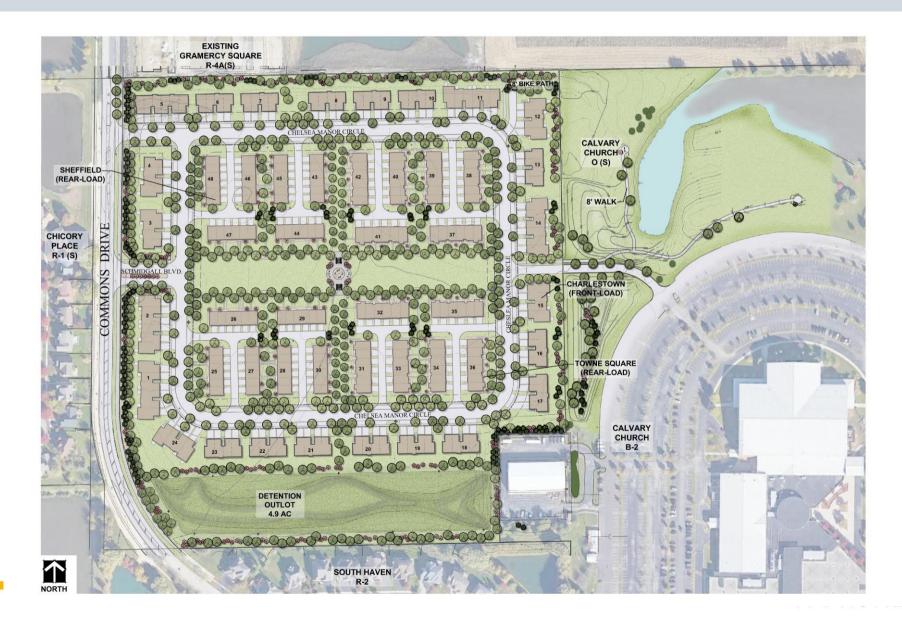

# Chelsea Manor Preliminary Plan

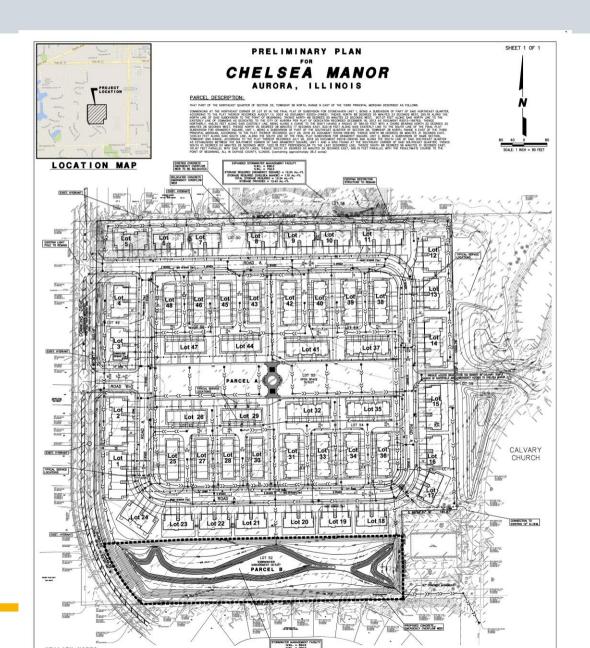



## **Charlestown Series**



Front Elevation - Farmhouse Style



#### Chelsea Manor Site Plan




# **Town Square Series**



Chelsea Manor Character Elevation



## Site Plan

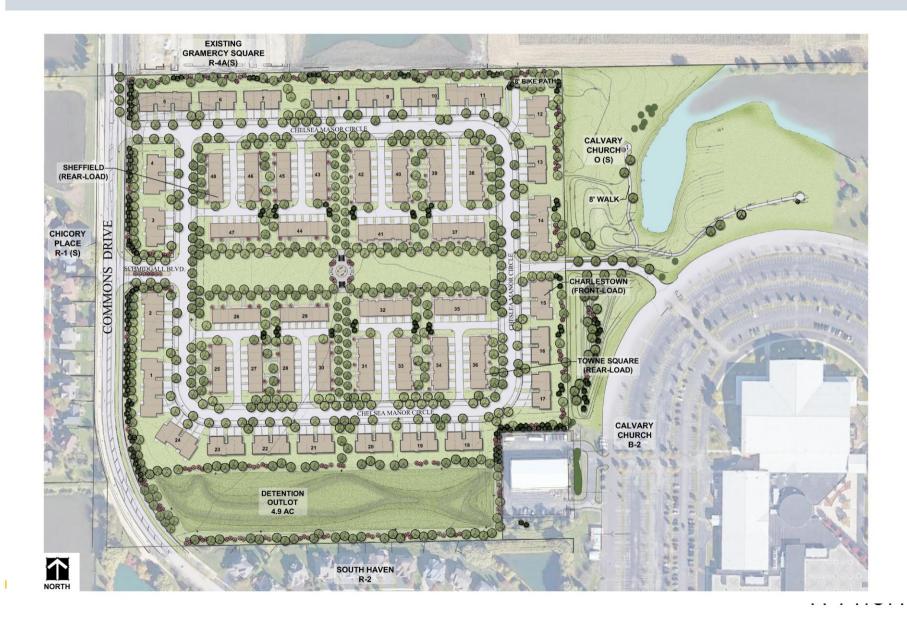

# Lincoln Square Series



Front Elevation



## **Questions and Answers**

Thank you for your time!



Table A COMMONS DRIVE AND CALVARY CHURCH SECONDARY ACCESS DRIVE SUNDAY AUGUST 22,2021

Dook House	Southbound		Northbound		Westbound	
Peak Hour	Through	Left	Through	Right	Right	Left
10:15-11:15 A.M.	29	42	37	0	62	1



#### Chelsea Manor Site Plan




## Pedestrian Plan





#### Chelsea Manor Site Plan

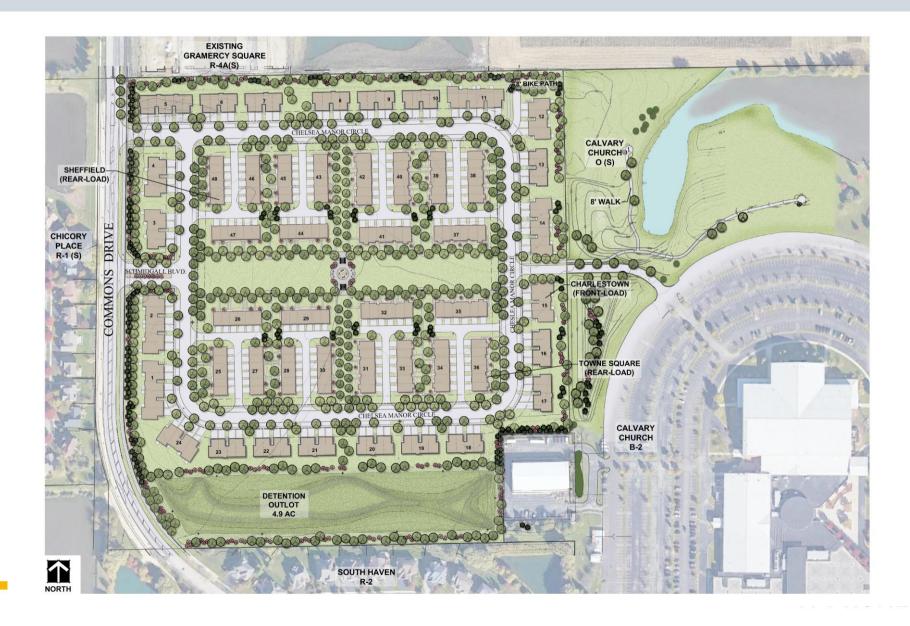





## M/I Homes

#### National:

- 13th largest Homebuilder
- Operating in 9 States

#### Illinois:

- 3rd largest Homebuilder
- 28 active communities
- 9 communities in planning
- 500 home closings projected



M/I HOMES













# Map View Lot Availability Available Homesite (0) Quick Move-In Home (8) Unavailable In Contract (13) Closed (114) Reserved (0) Other



## **Charlestown Series**



Rear Elevation
scale: 3/16" = 1'-0"





Right Elevation

Chelsea Manor Character Elevation

scale: 3/16" = 1'-0"

## **Town Square Series**



**Town Square** 

21

Aurora, IL

Chelsea Manor

**Character Elevations** 

# Lincoln Square Series






Chelsea Manor
Character Elevations





#### **Future Land Use**

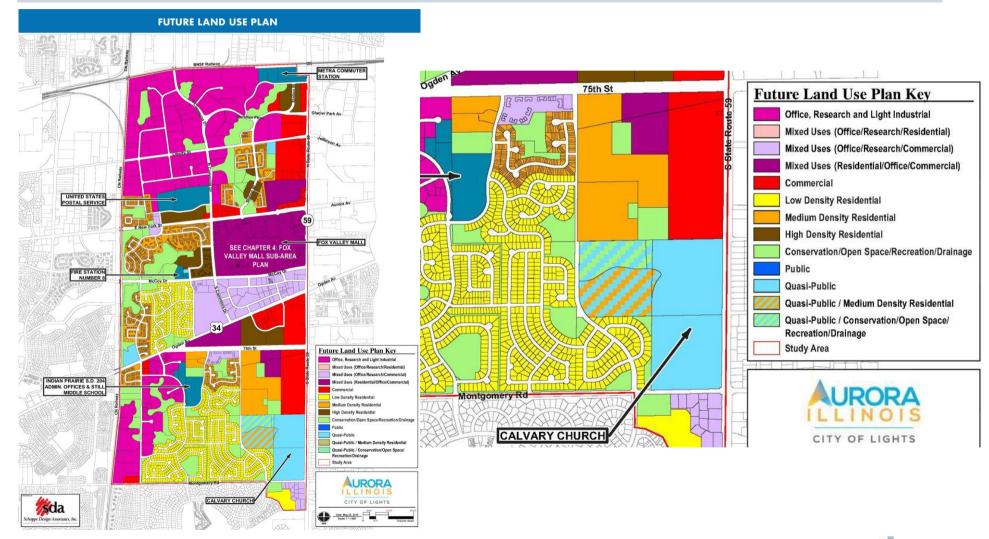



#### **Future Land Use**

#### Medium Density Residential Recommendations (MDR)


Characterized by attached single-family and multi-family units, developments in this land use category range in density from 6 to 12 units per acre and are not intended to be mixed with other uses. Traditionally, these types of medium density residential uses are constructed close to commercial uses, major transportation corridors, or higher density residential areas to provide a logical buffer between these uses and lower intensity uses such as single family residential development.

The Future Land Use Plan reflects a combination of both existing medium density residential projects comprised primarily of single-family attached/townhome units as well as areas for future medium density residential development. The majority of existing medium density residential uses are located in the west section of the study area, generally from New York Street on the north to Ogden Avenue on the south. An additional area of townhomes is located south of 75th Street slightly east of its intersection with Ogden Avenue.

Four new medium density residential pockets are recommended in the study area, all located south of the 75th Street corridor. The rationale for designating these areas as medium density residential includes several factors:

- Proximity to the heavily traveled 75th Street corridor;
- Proximity to adjacent and existing similar or higher density residential and commercial uses;
- Proximity to recommended future uses of similar or greater land use intensity; and
- Existing entitlement agreements.



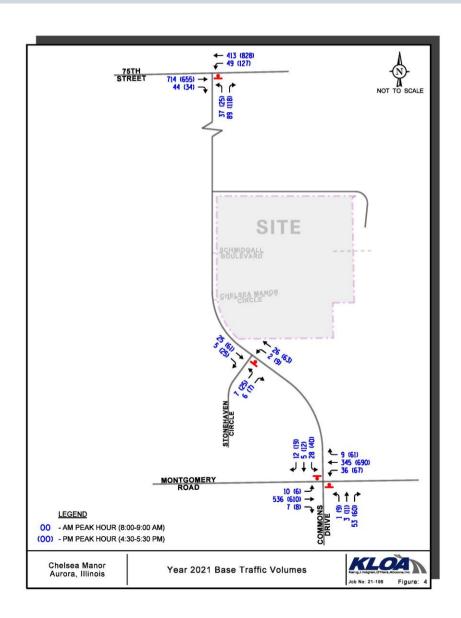




#### ESTIMATED SITE-GENERATED TRAFFIC VOLUMES

ITE Land			day Mo	•	W	eekday E Peak H	
Use Code	Type/Size	In	Out	Total	In	Out	Total
220	Townhomes (250 Units)	26	88	114	84	49	133



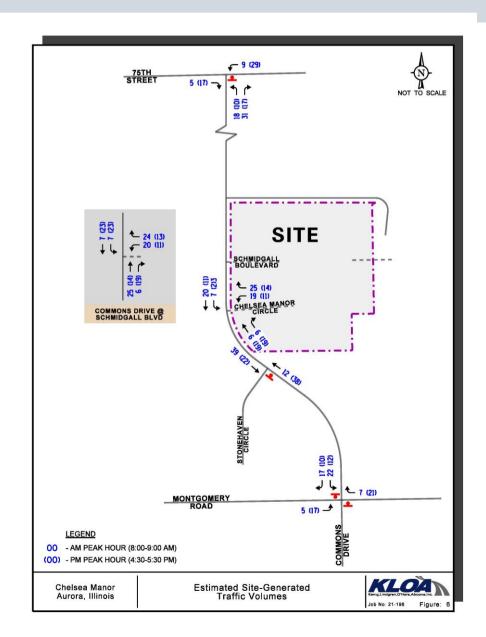



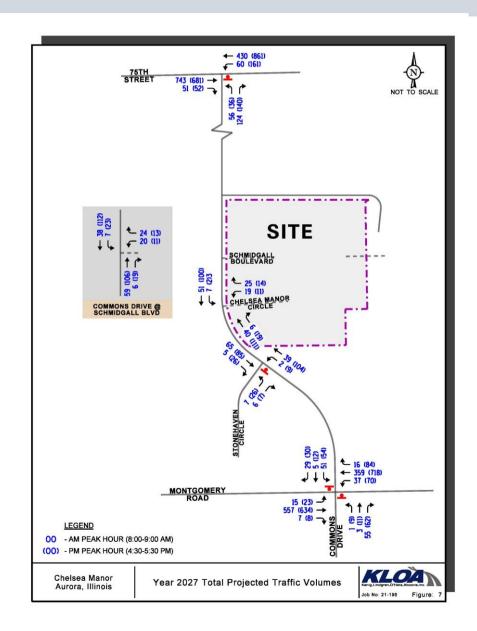




Table 3
CAPACITY ANALYSIS RESULTS – YEAR 2021 EXISTING CONDITIONS<sup>1</sup>


	The second secon	Morning Hour		Evening Hour
Intersection	LOS	Delay	LOS	Delay
Commons Drive with 75th Street				
Northbound Approach	В	13.1	В	12.9
<ul> <li>Westbound Left Turn</li> </ul>	A	9.9	A	9.8
Commons Drive with Stonehaven Circle				
Eastbound Approach	A	8.8	A	9.6
Northbound Left Turn	A	7.3	A	7.4
<b>Commons Drive with Montgomery Road</b>				
Northbound Approach	В	14.0	Е	39.9
Southbound Left Turn	D	32.1	F	99+
Southbound Through/Right Turn	В	14.3	D	30.4
Eastbound Left Turn	A	8.2	A	9.5
Westbound Left Turn	A	8.1	A	9.3
LOS = Level of Service 1 – All Intersections are Delay is measured in seconds	e Two-Way St	op Controlled		



Table 4
CAPACITY ANALYSIS RESULTS – YEAR 2027 PROJECTED CONDITIONS<sup>1</sup>

	The state of the s	Morning Hour		y Evening Hour
Intersection	LOS	Delay	LOS	Delay
Commons Drive with 75th Street				
Northbound Approach	В	14.0	В	14.0
Westbound Left Turn	В	10.2	В	10.3
Commons Drive with Stonehaven Circle				
Eastbound Approach	Α	9.1	В	10.2
Northbound Left Turn	A	7.4	A	7.5
Commons Drive with Montgomery Road				
Northbound Approach	В	14.5	F	54.9
Southbound Left Turn	Е	42.8	F	99+
Southbound Through/Right Turn	В	13.1	D	32.0
Eastbound Left Turn	Α	8.3	A	9.9
Westbound Left Turn	A	9.0	A	9.4
Commons Drive with Chelsea Manor Circle				
Westbound Approach	A	9.0	A	9.6
Southbound Left Turn	A	7.3	A	7.5
Commons Drive with Schmidgall Boulevard				
Westbound Approach	A	9.0	A	9.6
Southbound Left Turn	A	7.4	A	7.5
LOS = Level of Service Delay is measured in seconds.  1 – All Intersections Ar	e Two-Way S	top Controlled		



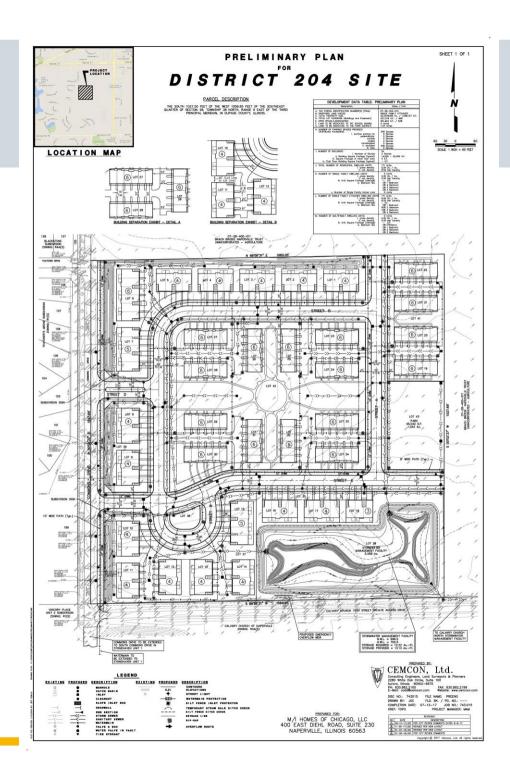













# Chelsea Manor Preliminary Plat

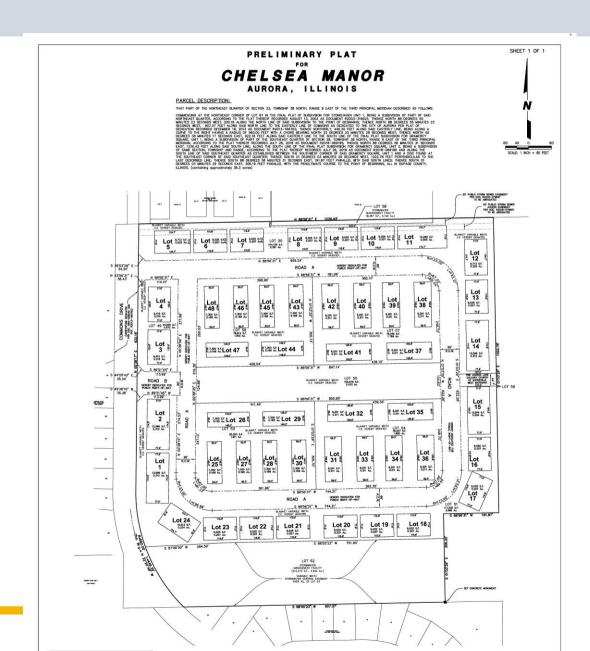



#### Chelsea Manor Fire Access Plan

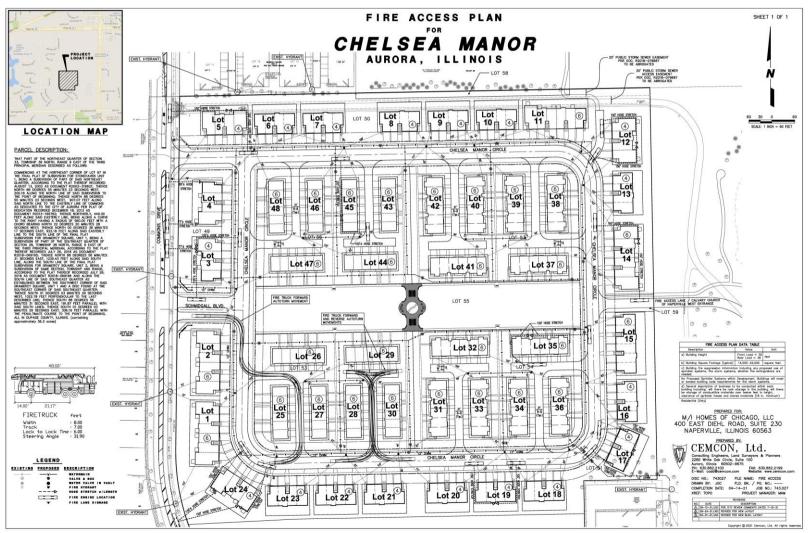



# Landscape Plan

#### Preliminary Landscape Plan

#### CHELSEA MANOR

Aurora, Illinois May 21, 2021








#### INDEX OF SHEETS SHEET NO DESCRIPTION


DESCRIPTION
COVER SHEET
OVERALL LANDSCAPE PLAN
LANDSCAPE PLAN
LANDSCAPE PLAN
OFF-SITE LANDSCAPE PLAN
LANDSCAPE DETAILS
TYPICAL FOUNDATION LANDSCAPE PLANS
TYPICAL FOUNDATION LANDSCAPE PLANS






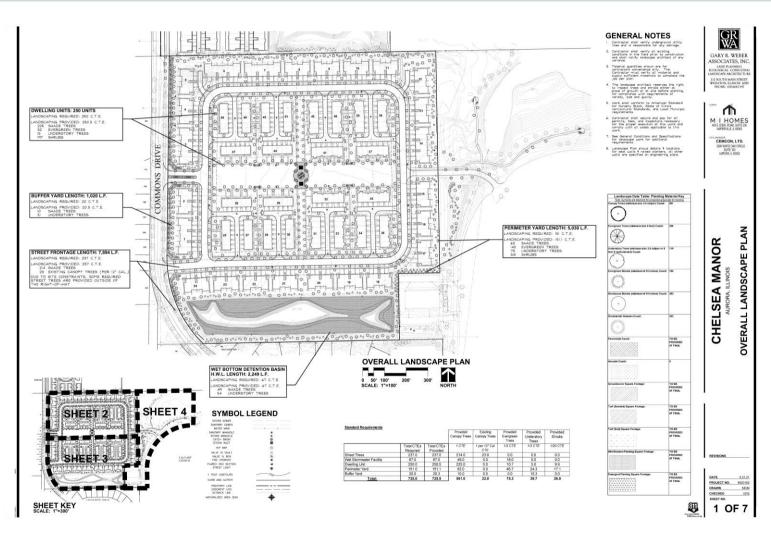



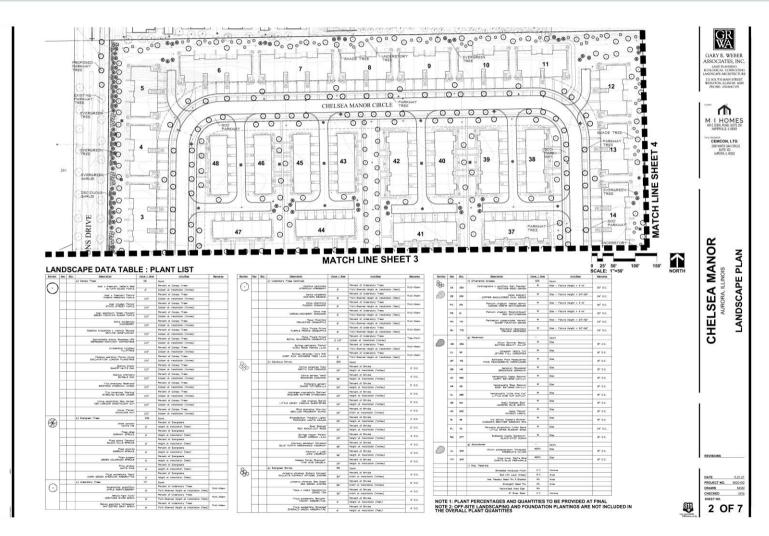




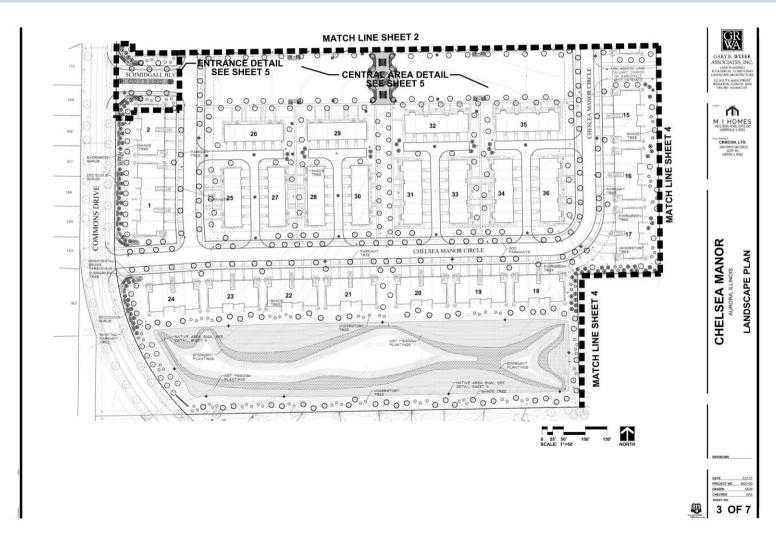




# Calvary Detention Improvement Plan

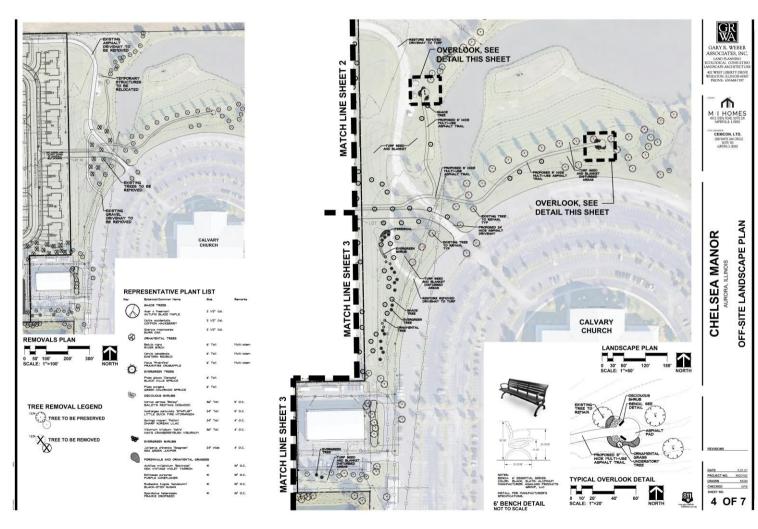




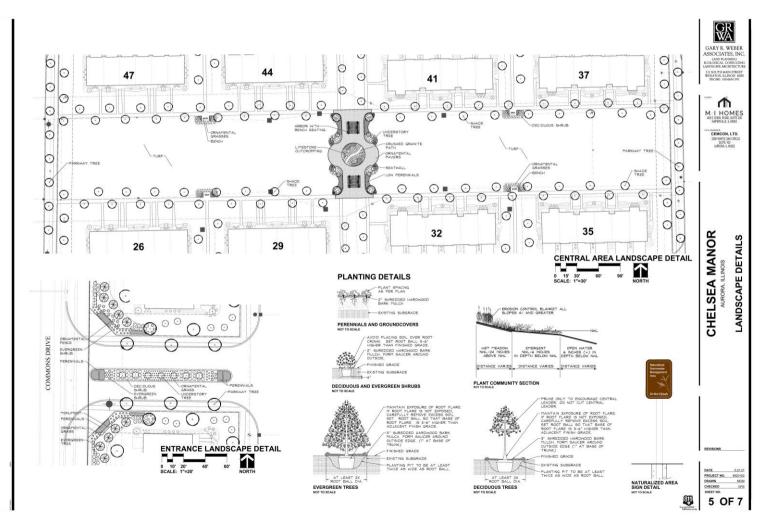




#### Central Plaza Plan

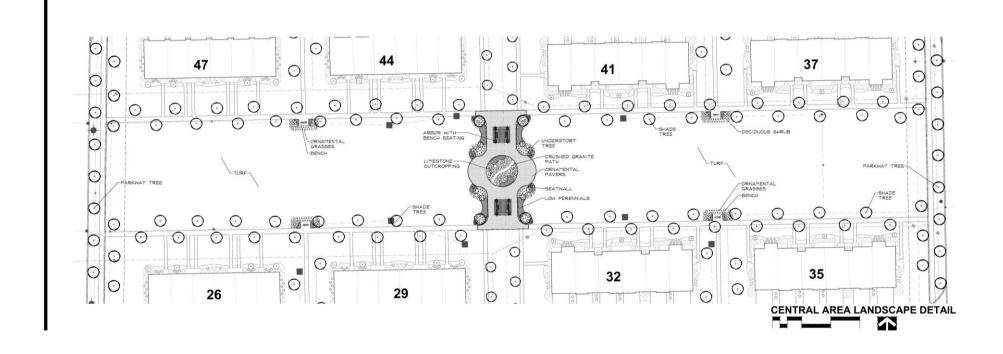



# Foundation Planting Plan

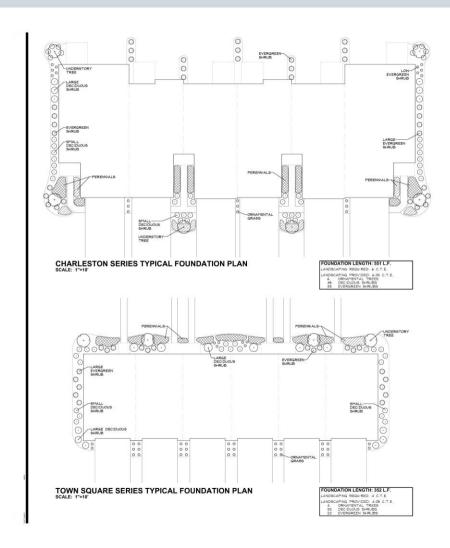

	ANT LIST		
Betarise/Common Name UNDERSTORY TREES	Size	Remarks	GA ASS
CORNELIANCHERRY DOGACOD	A' Tell		BOOK
Syrings perinensis 'Morton' CHINA SNOW PEKING LILAC	s' Tell		LANDS
Cercie canadensis EASTERN RED BUD	& Tell		212 9 WHE 7H
EVERGREEN TREES			
Thuja occidentalis "Smaragd" EMERALD GREEN ARBORVITAE	5' Tell		crews
DECIDUOUS SHRUBS			м
Comus sericeo 'Balleyi' BAILEY'S REDTHIG DOGHOOD	36° Tall	9 o.c.	460 E
Aronio melanocarpo 'Mortan' ROQUOIS BEAUTY CHOKEBERRY	24' Tall	3 O.C.	CALEM
lydronges quercifolis 'Alice' DAKLEAF HYDRANGEA	36" Toll	4 O.C.	2
Byringa meyeri "Palitin" DWARF KOREAN LILAC	24° Tell	4 0.6.	
/lbumum 'Juddi' JUDD VIBURNUM	34" Tell	5' O.C.	l
EVERGREEN SHRUBS			I
Jiniperus sobino "Blue Forest" BLUE FOREST JUNIPER	24' Hide	4 0.6	
Tacus e medio "Densiformis" DENSE TEX	24' Hide	# O.C.	1
PERENNALS AND ORNAMENTAL GRAS			l
Colomographia acutifions 'Korl Foerster' FEATHER REED GRASS		24° O.C.	l
Hemerocollis 'Happy Returns' HAPPY RETURNS DAYLILY	*	18° O.C.	l
Hosta 'Retrict' PATRIOT HOSTA	*1	18' O.C.	١.
Heuchers 'Georgia Peach' GEORGIA PEACH CORAL BELLS		ie' o.c.	<u> </u>
Pernisetum olopecuroides 'Homein' DNARF FOUNTAIN GRASS		24° O.C.	ıc
T FOUNDATION PLAN			MAN
FOUNDATION PLAN TH/WEST FACING) PL  Botonical/Common Name		Remorks	A MAN
FOUNDATION PLAN TH/WEST FACING) PL Betaried/Common Name UNDERSTORY TREES	ANT LIST	Remorks	SEA MAN
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FOUNDATION PLAN THIWEST FACING) PL Bidded/Greene Ware LOCKSTON FEED Acceptions gradient FACIAL SOURCE FACIAL SOURC	ANT LIST  Size  6' Totl  6' Totl  6' Totl  5' Totl		CHEI SEA MAN
FOUNDATION PLAN THIWEST FACING) PL Berried Common Nore LOCKSTON COMMON NORE AND COMMON NORE PAGE AND COMMON NORE P	Size 6' Toll 6' Toll 6' Toll 6' Toll 7' Toll 7' Toll 8' Toll 8' Toll		CHELSEA MAN
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# Foundation Planting Plan

