


**GENERAL NOTES:**  
 1. THESE PLANS ARE BASED ON THE BOUNDARY AND TOPOGRAPHIC SURVEY (SURVEY PROJECT #15-20592 DATED 06/16/15)  
 PREPARED BY: GENTILE AND ASSOCIATES, INC. 550 E. ST. CHARLES PLACE, LOMBARD, ILLINOIS 60148 (630) 916-6262  
 2. PRIOR TO CONSTRUCTION, CONTRACTOR TO CONTACT THE DESIGN ENGINEER AND ARCHITECT TO VERIFY THAT THEY ARE WORKING FROM THE MOST CURRENT SET OF PLANS AND SPECIFICATIONS.

**ON SITE PARKING DATA**

PROPOSED REGULAR SPACES	37
PROPOSED ADA ACCESSIBLE SPACES	2
PROPOSED TOTAL SPACES	39
EXISTING PARKING SPACES =	46
REQUIRED PARKING SPACES = 1 SPACE/3 SEATS	
EXISTING BUILDING HAS 62 SEATS,	
THEREFORE 62 SEATS/3 = 20.6 OR 21 SPACES	
39 PROPOSED SPACES > 21 REQUIRED SPACES	
EXISTING BUILDING AREA = 3,540 S.F.	

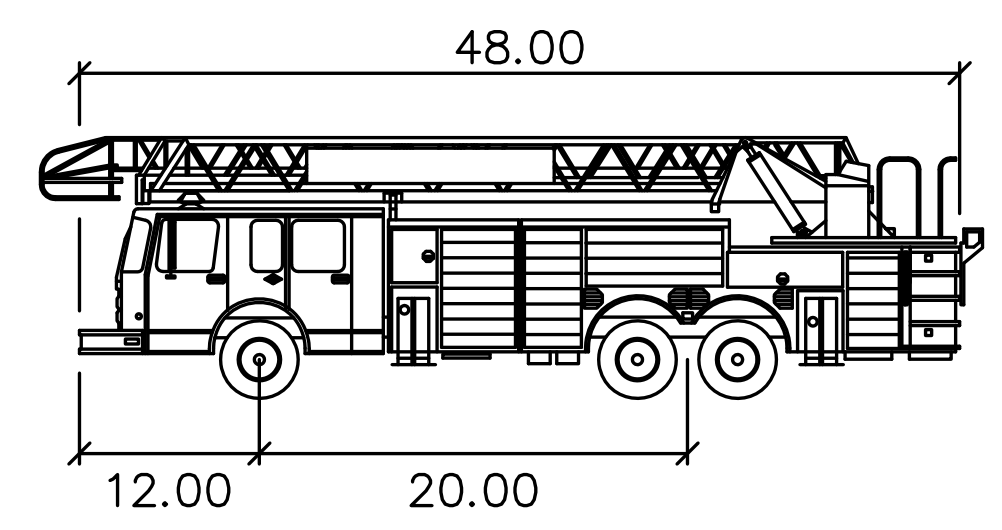

**Aurora** feet  
 Width : 8.00  
 Track : 7.00  
 Lock to Lock Time : 6.0  
 Steering Angle : 32.0

**LEGEND**

SYMBOL	EXISTING DESCRIPTION
□	UTILITY PEDESTAL
○	UTILITY POLE
☆	LIGHT STANDARD
+	SIGN POST
⊠	TRAFFIC SIGNAL CONTROL VAULT
Ⓣ	TELEPHONE SERVICE VAULT
⊙	FIRE HYDRANT
⊕	WATER SERVICE SHUTOFF VALVE
⊖	WATER VALVE VAULT
Ⓞ	CLOSED COVER DRAINAGE STRUCTURE
Ⓢ	OPEN COVER DRAINAGE STRUCTURE
Ⓜ	CURB INLET/CATCH BASIN
Ⓜ	SANITARY SEWER MANHOLE
Ⓜ	GAS SERVICE SHUTOFF VALVE
Ⓜ	CLEANOUT
Ⓜ	WATER SHUTOFF VALVE WITH 8" CASING
Ⓜ	ELECTRIC SERVICE VAULT
•	BOLLARDS
○	FLAG POLE
○	TREE

**Fire Access Plan Data Table**

Description	Value	Unit
a) Building Height	18'±	feet
b) Square footage of each building	3,540 S.F.	feet
c) Building fire suppression information including any proposed use of sprinkler systems, fire alarm systems, whether fire extinguishers are needed:	DOES NOT APPLY	
d) General description of business to be conducted within each building including: will there be rack storage in the building, will there be storage of combustible materials over twelve feet in height, clearance of sprinkler heads and stored materials (18 inch minimum):	DOES NOT APPLY	

DATE: \_\_\_\_\_


NO. \_\_\_\_\_

REVISIONS: \_\_\_\_\_

Prepared For: **McDonald's**  
 4320 Winfield Road, Suite 400  
 Warrenville, IL 60555  
**FIRE ACCESS PLAN FOR McDONALD'S - AURORA**  
 Lots 4, 5, and 6 of Stephenson's Addition  
 711 New York Street  
 Aurora, Illinois

Prepared By: **Watermark Engineering Resources, Ltd**  
 2631 Ginger Woods Parkway, Suite 100, Aurora, IL 60502  
 phone 630-375-1800 fax 630-236-9800 www.watermark-engineering.com

CHECKED BY: J. MILLER  
 DESIGN BY: K. SACK  
 DRAWN BY: K. SACK  
 DATE: JULY 22, 2015  
 SCALE: 1" = 20'  
 PROJECT NO.: 15-016

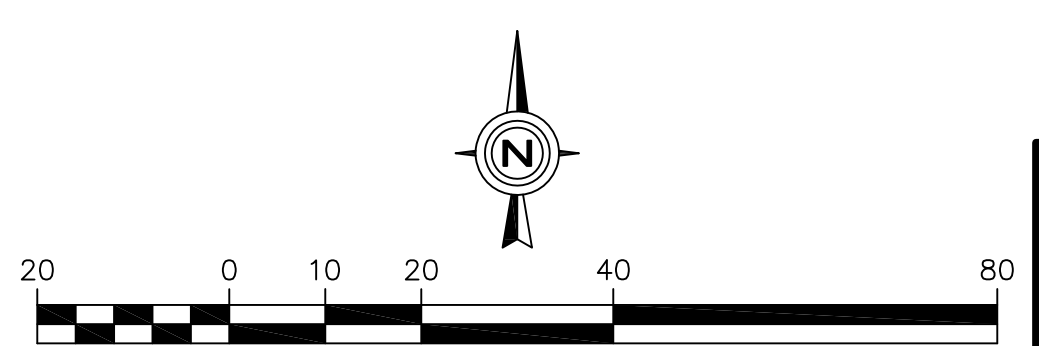

**FIRE ACCESS PLAN FOR McDONALD'S-AURORA**

**1 of 1**  
 LC #12-1792