Final Landscape Plan

Kirkland Crossings of Lot 5, Lot 2

Aurora, Illinois


December 8, 2021

CONSULTANTS:



LANDSCAPE ARCHITECT:

GARY R. WEBER ASSOCIATES, INC 402 W. LIBERTY DRIVE WHEATON, ILLINOIS 60187

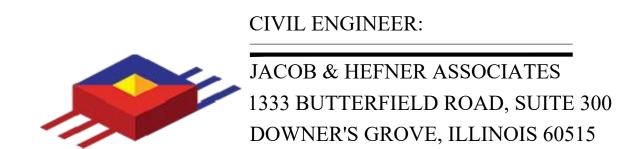



LOCATION MAP

SCALE: 1"=200'

INDEX OF SHEETS


SHEET NO.	DESCRIPTION
0	COVER SHEET
1	LANDSCAPE PLAN
2	LANDSCAPE SPECIFICATIONS

Landscape Data Table: Planting Material Key				
Note: Symbols are blackline for proposed grayscale for existing				
Canopy Trees (minimum size 2.5 caliper) Count:	8			
, , , , , , , , , , , , , , , , , , , ,				
Evergreen Trees (minimum size 6 feet) Count:	0			
Understory Trees (minimum size 2.5 caliper or 8	11			
feet if multi-stemed) Count:				
F				
Evergreen Shrubs (minimum of 18 inches) Count:	32			
Desiduence Objective (111)	400			
Deciduous Shrubs (minimum of 18 inches) Count:	162			
Owner what Owner are County				
Ornamental Grasses Count:	0			
Perennials Count:	0			
Perenniais Count:	U			
Annuals Count:	0			
Parituals Count.				
[+ + + + + + + + +				
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Groundcover Square Footage:	0			
Turf (Seeded) Square Footage:	0			
(Journal of Journal of Jour				
Turf (Sod) Square Footage:	11,004			
(Soa, Square i Soluge.	1,504			
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LANDSCAPE DATA: CTE'S PROVIDED

LANDOOAI E DATA. OTE OT NOTIDED						
	Total CTEs	Total CTEs				
	Required	Provided				
North Perimeter	4.5	4.5				
South Perimeter	1.5	1.5				
East Perimeter	7.5	7.5				
West Perimeter	4.0	4.0				
Parking Lot Islands	1.50	1.50				
Building Foundation	1.00	1.00				
* Trash Enclosure	0.00	0.00				
<u>Total:</u>	20.00	20.00				

^{*}Trash Enclosure is required to be screened. Evergreen trees are provided.

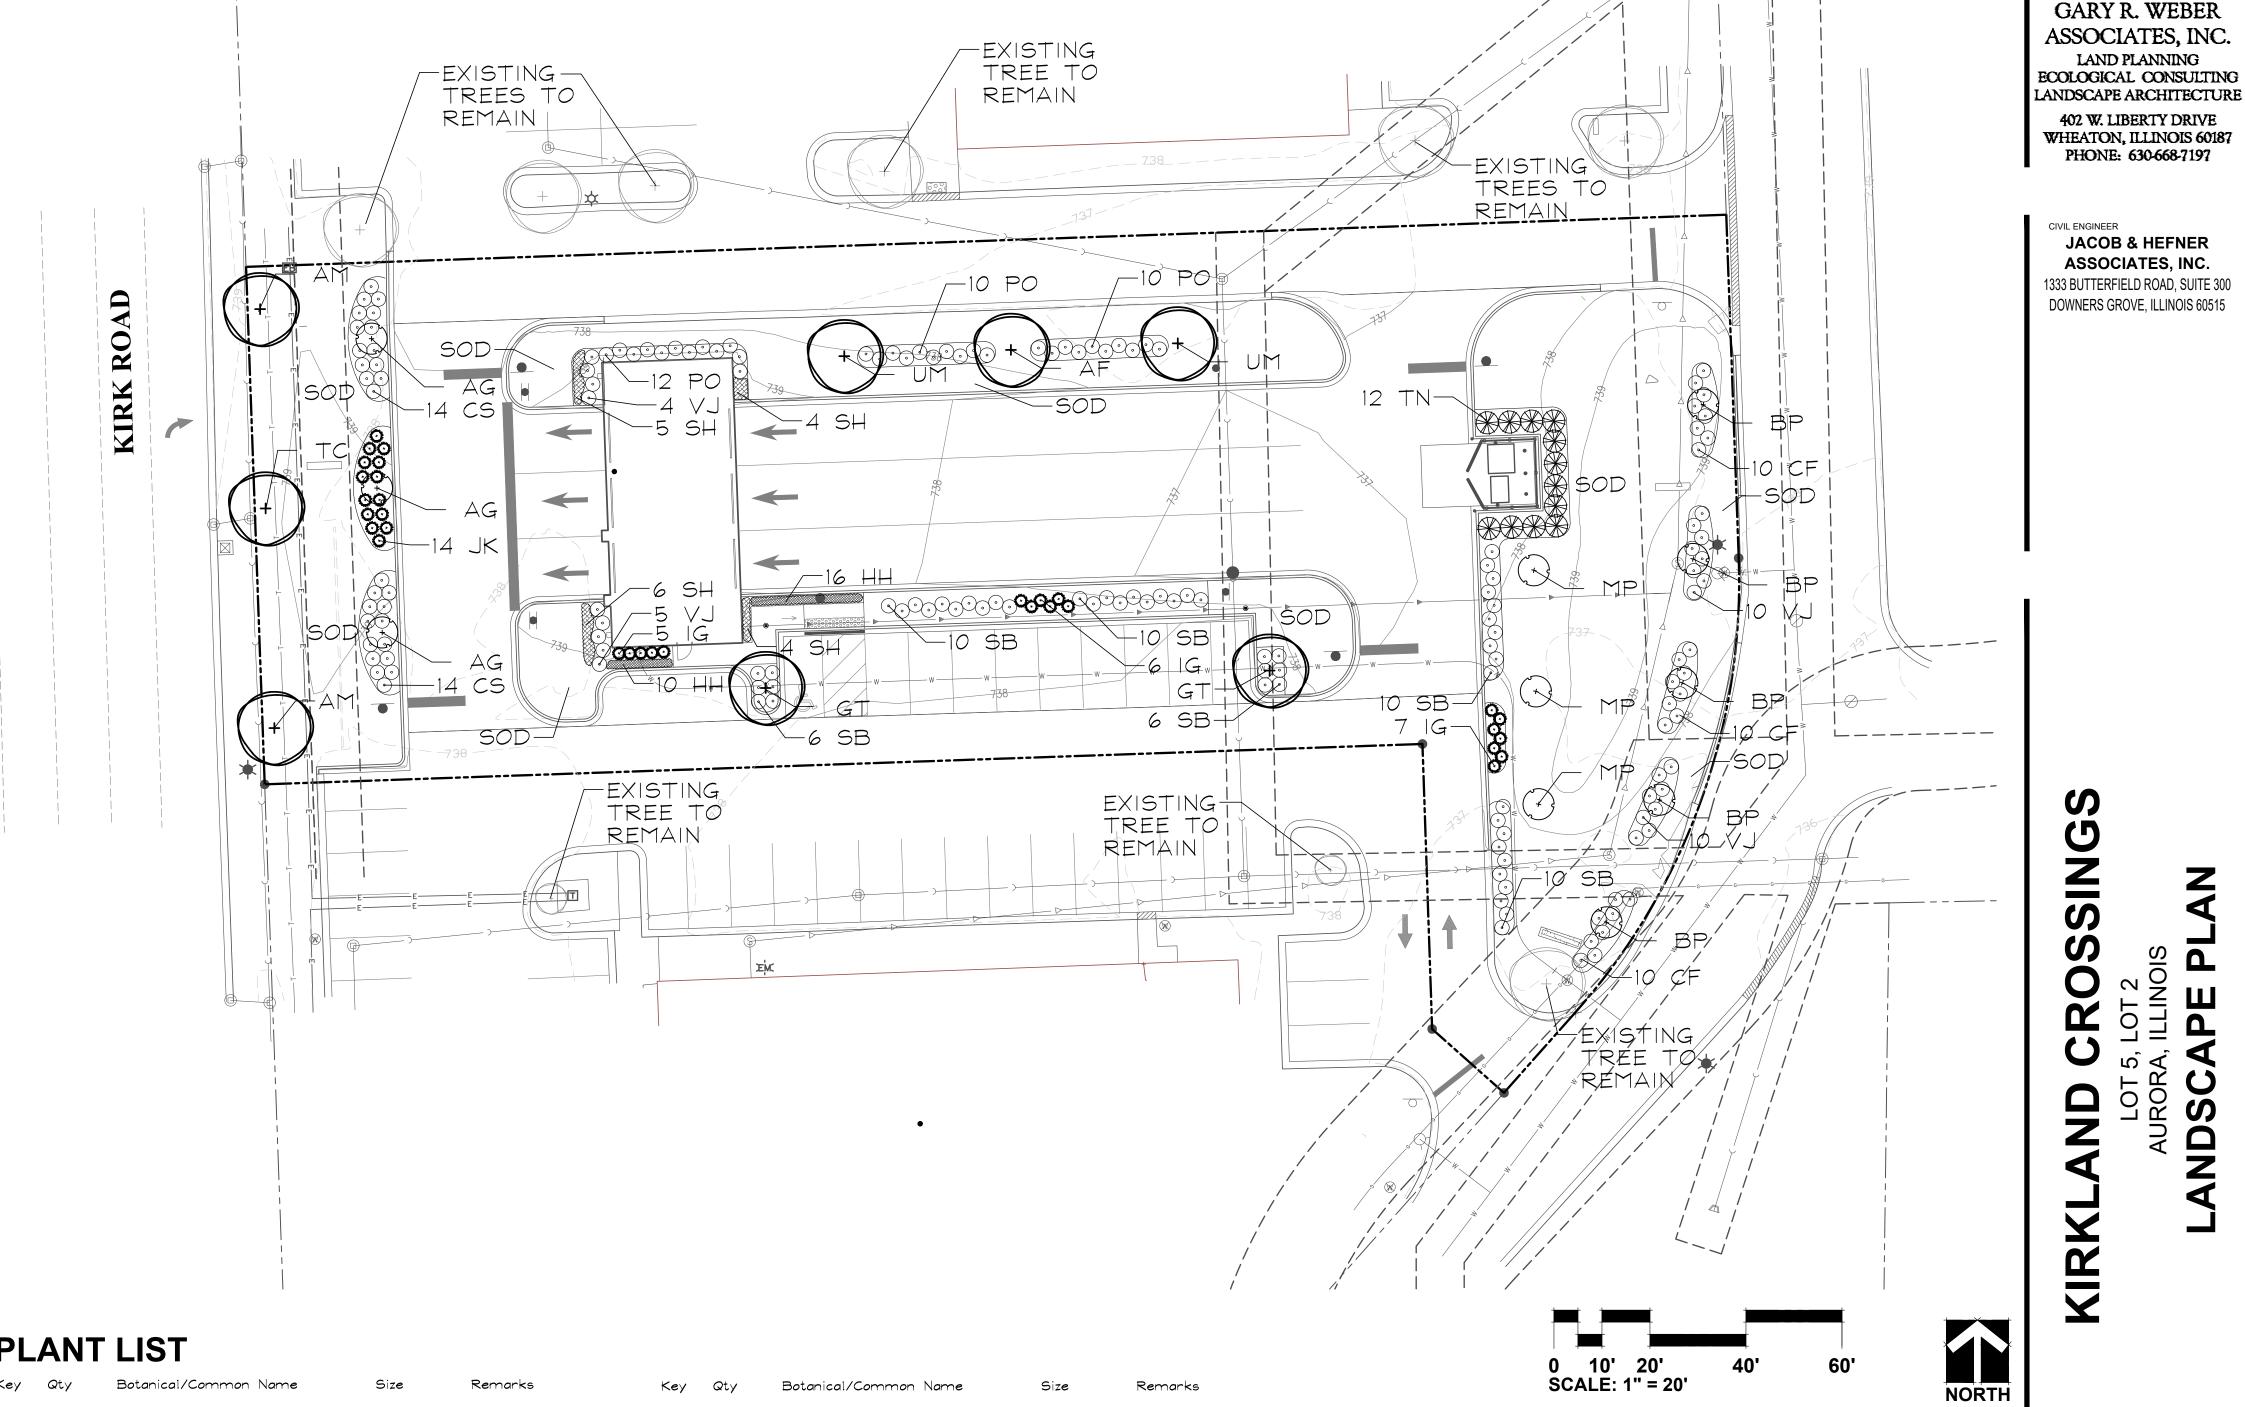

PLANT LIST

Viburnum x juddii JUDD VIBURNUM

Key	Qty	Botanical/Common Name	Size	Remarks	Key	Qty	Botanical/Common Name	Size	Remark
		SHADE TREES					EVERGREEN SHRUBS		
AF	1	Acer x freemanii 'Marmo' MARMO FREEMAN MAPLE	2 1/2" Cal.		IG	18	Ilex glabra 'Shamrock' SHAMROCK INKBERRY	24" Tall	3' O.C.
AM	2	Acer miyabei 'Morton' STATE STREET MAPLE	2 1/2" Cal.		JK	14	Juniperus chinensis 'Kallays Compact'	24" Wide	4' O.C.
GT	2	Gleditsia triacanthos var. inermis 'Skycole SKYLINE HONEYLOCUST	e' 2 1/2" Cal.				KALLAYS COMPACT PFITZER JUNIPER		
ТС	1	Tilia cordata 'Greenspire' GREENSPIRE LITTLELEAF LINDEN	2 1/2" Cal.		SH	19	ORNAMENTAL GRASSES Sporobolus heterolepis	#1	24" O.C.
UM	2	Ulmus 'Morton Glossy' TRIUMPH ELM	2 1/2" Cal.				PRAIRIE DROPSEED		
		IRIONPA ELM					PERENNIALS		
		ORNAMENTAL TREES			НН	26	Hemerocallis 'Happy Returns' HAPPY RETURNS DAYLILY	#1	18" O.C.
AG	3	Amelanchier x grandiflora APPLE SERVICEBERRY	6' Ht.	Multi-Stem			MISC. MATERIALS		
BP	5	Betula populifolia 'Whitespire' WHITESPIRE GRAY BIRCH	6' Ht.	Multi-Stem		18	SHREDDED HARDWOOD MULCH	C.Y.	
MP	3	Malus 'Prairifire' PRAIRIFIRE CRABAPPLE	6' Ht.	Multi-Stem		1143	SOD	S.Y.	
		EVERGREEN TREES							
TN	12	Thuja occidentalis 'Nigra' DARK GREEN ARBORVITAE	6' Ht.						
		DECIDUOUS SHRUBS							
CS	28	Cornus sericea 'Isantii' INSANTI REDTWIG DOGWOOD	24" Tall	4 ¹ O.C.					
CF	30	Cornus sericea 'Farrow' ARCTIC FIRE REDTWIG DOGWOOD	24" Tall	3' O.C.					
PO	32	Physocarpus opulifolius 'Donna May' LITTLE DEVIL NINEBARK	24" Tall	3' O.C.					
SB	43	Spiraea x bumalada 'Goldflame' GOLDFLAME SPIREA	24" Tall	3' O.C.					

24" Tall 4' O.C.

GENERAL NOTES

Contractor shall verify underground utility lines and is responsible for any damage.

SCALE: 1" = 20'

- 2. Contractor shall verify all existing conditions in the field prior to construction and shall notify landscape architect of any variance.
- 3. Material quantities shown are for contractors convenience only. The Contractor must verify all material and supply sufficient materials to complete the job per plan.
- 4. The landscape architect reserves the right to inspect trees and shrubs either at place of growth or at site before planting, for compliance with requirements of variety, size and quality.
- 5. Work shall conform to American Standard for Nursery Stock, State of Illinois Horticultural Standards, and Local Municipal requirements.
- 6. Contractor shall secure and pay for all permits, fees, and inspections necessary for the proper execution of this work and comply with all codes applicable to this work.
- 7. See General Conditions and Specifications for landscape work for additional requirements.

l 4	11.15.2021
2	12.08.2021

GARY R. WEBER

402 W. LIBERTY DRIVE

JACOB & HEFNER ASSOCIATES, INC.

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DATE	9.29.2021
PROJECT NO.	JH21115
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SHEET NO.	



LANDSCAPE WORK PART 1 - GENERAL

1.1 DESCRIPTION OF WORK

- A. The work shall consist of furnishing, transporting and installing all seeds, plants and other materials required for:
- 1. The establishment of trees, shrubs, perennials, annuals, lawn, and native areas as shown on Landscape Plan;
- 2. The provision of post-planting management as specified herein; 3. Any remedial operations necessary in conformance with the plans as
- specified in this document; 4. Permits which may be required.

1.2 QUALITY ASSURANCE

A. Work shall conform to State of Illinois Horticultural Standards and local municipal requirements.

B. Quality Control Procedures:

- 1. Ship landscape materials with certificates of inspection as required by governmental authorities. Comply with governing regulations applicable to landscape materials.
- 2. Do not make substitutions. If specified landscape material is not obtainable, submit to Landscape Architect proof of non-availability and proposal for use of equivalent material.
- 3. Analysis and Standards: Package standard products with manufacturer's certified analysis.

1.3 SUBMITTALS

A. Planting Schedule

Submit three (3) copies of the proposed planting schedule showing dates for each type of planting

B. Maintenance Instruction - Landscape Work

Submit two (2) copies of typewritten instructions recommending procedures to be established by the Owner for the maintenance of landscape work for one full year. Submit prior to expiration of required maintenance periods.

Instructions shall include: watering, fertilizing, spraying, mulching and pruning for plant material and trimming groundcover. Instructions for watering, fertilizing and mowing grass areas shall be provided ten (10) days prior to request for inspection for final acceptance. Landscape Architect shall receive copies of all instructions when issued.

- C. Submit two (2) copies of soil test of existing topsoil with recommendations for soil additive requirement to Landscape Architect for review and written approval.
- D. Submit two (2) samples of shredded hardwood bark mulch, erosion control blankets, and all other products and materials as specified on plans to Landscape Architect for review and written approval.
- E. Nursery packing lists indicating the species and quantities of material installed must be provided to the Owner and/or City upon request.

1.4 JOB CONDITIONS

- A. Examine and evaluate grades, soils and water levels. Observe the conditions under which work is to be performed and notify Landscape Architect of unsatisfactory conditions. Do not proceed with the work until unsatisfactory conditions have been corrected in an acceptable manner.
- B. Utilities: Review underground utility location maps and plans; notify local utility location service; demonstrate an awareness of utility locations; and certify acceptance of liability for the protection of utilities during course of work. Contractor shall be responsible for any damage to utilities or property.
- C. Excavation: When conditions detrimental to plant growth are encountered such as rubble fill, adverse drainage conditions or obstructions, notify Landscape Architect before planting.

1.5 GUARANTEES

- A. Guarantee seeded and sodded areas through the specified maintenance period and until final acceptance.
- B. Guarantee trees, shrubs, groundcover and perennials for a period of one year after date of acceptance against defects including death and unsatisfactory growth, except for defects resulting from neglect by Owner, abuse or damage by others or unusual phenomena or incidents which are beyond Landscape Installer's control.

C. Native Planting Area Performance Criteria

1st Full Growing Season: 90% of cover crop shall be established. There shall be no bare areas greater than two (2) square feet in seeded areas. At least 25% of vegetation coverage shall be native, non-invasive species. At least 50% of the emergent species, if planted as plugs shall be alive and apparent.

2nd Full Growing Season: All areas with the exception of emergent zones shall exhibit full vegetative cover. At least 50% of the vegetation coverage shall be native, non-invasive species.

3rd Full Growing Season: At least 90% of vegetation coverage shall be native, non-invasive species. Non-native species shall constitute no more than 10% relative aerial coverage of the planted area.

The native floristic quality index value (native FQI) shall be greater than or equal to 15 over the buffer area. A native mean coefficient of conservatism value (native mean Ĉ value) of greater than or equal to 3.0 shall be achieved within the buffer area. The floristic quality assessment method is described in Swink and Wilhelm, Plants of the Chicago Region.

Invasive species for this project shall include the following: Ambrosia artemisiifolia \$ trifida (Common \$ Giant Ragweed), Cirsium arvense (Canada Thistle), Dipsacus laciniatus (Cut-leaved Teasel), Dipsacus sylvestris (Common Teasel), Lythrum salicaria (Purple Loosestrife), Melilotus sp. (Sweet Clover), Phalaris arundinacea (Reed Canary Grass), Phragmites australis (Giant Reed), Fallopia japonica (Japanese Knotweed), Rhamnus cathartica \$ frangula (Common \$ Glossy Buckthorn), Typha sp. (Broadleaf, Narrowleaf, and Hybrid Cattail).

LANDSCAPE WORK PART 2 - PLANT MATERIALS

2.1 LAWN SOD

A. Provide strongly rooted sod, not less than two (2) years old and free of weeds and undesirable native grasses. Provide only sod capable of growth and development when planted (viable, not dormant) and in strips not more than 18" wide x 4' long. Provide sod composed of a 5-way blend of Kentucky Bluegrass such as: Midnight, Allure, Viva, Washington, Liberty.

2.2 LAWN SEED MIXTURE

Grass Seed: Provide fresh, clean, new crop seed complying with the tolerance for purity and germination established by the Official Seed Analysts of North America. Provide seed of the grass species, proportions and maximum percentage of weed seed, as specified.

- A. Lawn Seed Mixture 5 lbs./1,000 sq. ft.
- 50% Kentucky Bluegrass 98/85
- 15% Cutter Perennial Ryegrass 10% Spartan Hard Fescue
- 10% Edge Perennial Ryegrass
- 10% Express Perennial Ryegrass 5% Pennlawn Creeping Red Fescue

2.3 GROUNDCOVERS, PERENNIALS AND ANNUALS

Provide plants established and well-rooted in removable containers or integral peat pots and with not less than the minimum number and length of runners required by ANSI Z60.1 for the pot size shown or listed.

2.4 TREES AND SHRUBS

- A. Name and Variety: Provide nursery grown plant material true to name and
- B. Quality: Provide trees, shrubs and other plants complying with the recommendations and requirements of ANSI Z60.1 "Standard for Nursery Stock" and as further specified.
- C. Deciduous Trees: Provide trees of height and caliper listed or shown and with branching configuration recommended by ANSI Z60.1 for type and species required. Provide single stem trees except where special forms are shown or listed. Provide balled and burlapped (B\$B) deciduous trees.
- D. Deciduous Shrubs: Provide shrubs of the height shown or listed and with not less than the minimum number of canes required by ANSI Z60.1 for the type and height of shrub required. Provide balled and burlapped (B\$B) deciduous
- E. Coniferous Evergreen: Provide evergreens of the sizes shown or listed. Dimensions indicate minimum spread for spreading and semi-spreading type evergreens and height for other types. Provide quality evergreens with well-balanced form complying with requirements for other size relationships to the primary dimension shown. Provide balled and burlapped (B\$B) evergreen trees and containerized shrubs.
- F. Inspection: All plants shall be subject to inspection and review at the place of growth or upon delivery and conformity to specification requirements as to quality, right of inspection and rejection upon delivery at the site or during the progress of the work for size and condition of balls or roots, diseases, insects and latent defects or injuries. Rejected plants shall be removed immediately from the site.

2.5 PLANTING SOIL MIXTURE

A. Provide planting soil mixture consisting of clean uncompacted topsoil (stockpiled at site) for all planting pits, perennial, groundcover, lawn and native areas. No topsoil shall be imported to the site without approval from the general contractor and landscape architect. Topsoil shall be conditioned based on any recommendations resulting from the soil test in 1.3.C.

2.6 EROSION CONTROL

- A. Lawn Seed Areas Erosion Control Blanket: North American Green DS75, or equivalent approved equal.
- B. Native Areas Erosion Control Blanket: North American Green S150, or equivalent approved equal.
- C. Refer to latest Engineering \$ Erosion Control Plans for any areas to receive permanent or long-term blanket installation.

LANDSCAPE WORK PART 3 - EXECUTION

3.1 PLANTING SCHEDULE

A. At least thirty (30) days prior to the beginning of work in each area, submit a planting schedule for approval by the Landscape Architect.

3.2 PLANTINGS

- A. Sodding New Lawns
 - 1. Remove any existing grass, vegetation and turf. Dispose of such material legally off-site, do not turn over into soil being prepared for lawns.
 - 2. Till to a depth of not less than 6"; apply soil amendments as needed; remove high areas and fill in depressions; till soil to a homogenous mixture of fine texture, remove lumps, clods, stones over 1" diameter, roots and other extraneous matter. Dispose of such material legally
 - 3. Sodded areas shall receive an application of commercial fertilizer at the rate of 10 lbs. per 1,000 sq. ft. and shall have an analysis of 16-8-8.
 - 4. Lay sod within 24 hours from time of stripping.
 - 5. Lay sod to form a solid mass with tightly fitted joints. Butt ends and sides of sod strips; do not overlap. Stagger strips to offset joints in adjacent courses. Work from boards to avoid damage to subgrade or sod. Tamp or roll lightly to ensure contact with subgrade. Work sifted soil into minor cracks between pieces of sod; remove excess to avoid smothering of adjacent grass.
 - 6. Water sod thoroughly with a fine spray immediately after planting.

B. Seeding New Lawns

- 1. Remove any existing grass, vegetation and turf. Dispose of such material legally off-site. Do not turn over into soil being prepared for lawns.
- 2. Till to a depth of not less than 6"; apply soil amendments; remove high areas and fill in depressions; till soil to a homogenous mixture of fine texture, remove lumps, clods, stones over 1" diameter, roots and other extraneous matter. Dispose of such material legally off-site.
- 3. Seeded lawn areas shall receive an application of commercial fertilizer at the rate of 5 lbs. per 1,000 sq. ft. and shall be 6-24-24. Fertilizer shall be uniformly spread and mixed into the soil to a depth of 1" inches.
- 4. Do not use wet seed or seed which is moldy or otherwise damaged in transit or storage.
- 5. Sow seed using a spreader or seeding machine. Do not seed when wind velocity exceeds five (5) miles per hour. Distribute seed evenly over entire area by sowing equal quantity in two directions at right angles to each other.
- 6. Sow not less than specified rate.

7. Rake lawn seed lightly into top 1" of soil, roll lightly and water with a

8. After the seeding operation is completed, spray a wood fiber mulch (Conweb 2000 with tacifier or approved equal) over the entire grassed area at the rate of 2,000 lbs. per acre. Use a mechanical spray unit to insure uniform coverage. Exercise care to protect buildings, automobiles and people during the application of the mulch.

C. Groundcover and Perennial Beds

Groundcover, perennials, and annuals shall be planted in continuous beds of planting soil mixture a minimum of 8" deep. Install per spacing indicated on

D. Trees and Shrubs

1. Set balled and burlapped (B\$B) stock plumb and in center of pit or trench with top of ball at an elevation that will keep the root flare exposed upon backfill and mulching. Remove burlap from top and sides of balls; retain on bottoms. When set, place additional topsoil backfill around base and sides of ball and work each layer to settle backfill and eliminate voids and air pockets. When excavation is approximately 2/3 full, water thoroughly before placing remainder of backfill. Repeat watering until no more is absorbed. Water again after placing final layer of backfill.

- 2. Dish top of backfill to allow for mulching. Provide additional backfill berm around edge of excavations to form shallow saucer to collect water.
- 3. Mulch pits, trenches and planted areas. Provide not less than 2" thickness of mulch and work into top of backfill and finish level with adjacent finish grades. Maintain exposed root flare at all times
- 4. Prune only injured or dead branches from flowering trees, if any. Protect central leader of tree during shipping and pruning operations. Prune shrubs to retain natural character in accordance with standard horticultural practices.
- 5. Remove and replace excessively pruned or ill-formed stock resulting from improper pruning.
- 6. The Contractor shall be wholly responsible for assuring that all trees are planted in a vertical and plumb position and remain so throughout the life of this contract and guarantee period. Trees may or may not be staked and guyed depending upon the individual preference of the Contractor; however, any bracing procedure(s) must be approved by the Owner prior to its installation.

3.3 INITIAL MAINTENANCE

- A. Begin maintenance immediately after planting, continuing until final acceptance. A minimum of thirty (30) days.
- B. Maintain planted and seeded areas by watering, rolling/regrading, replanting and implementing erosion control as required to establish vegetation free of eroded or bare areas.
- C. Compensatory Storage and Native Planting areas are to be mowed only once per spring during the initial three year establishment period.

3.4 CLEAN UP AND PROTECTION

- A. During landscape work, store materials and equipment where directed. Keep payements clean and work areas and adjoining areas in an orderly condition.
- Protect landscape work and materials from damage due to landscape operations, operations by other trades and trespassers. Maintain protection during installation and maintenance periods. Treat, repair or replace damaged landscape work as directed by Landscape Architect.

3.6 INSPECTION AND ACCEPTANCE

maintenance.


- A. The Landscape Architect reserves the right to inspect seeds, plants, trees and shrubs either at place of growth or at site before planting for compliance with requirements for name, variety, size, quantity, quality and mix proportion.
- B. Supply written affidavit certifying composition of seed mixtures and integrity of plant materials with respect to species, variety and source.
- C. Notify the Landscape Architect within five (5) days after completing initial and/or supplemental plantings in each area.


D. When the landscape work is completed, including maintenance, the Landscape

acceptability. After final acceptance, the Owner will be responsible for

Architect will, upon request, make a final inspection to determine

PLANTING DETAILS

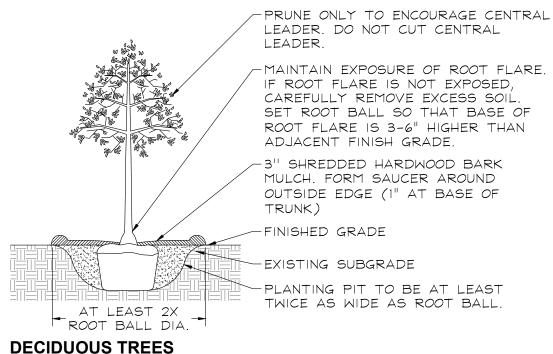

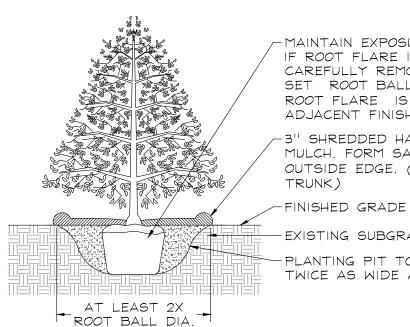


-MAINTAIN EXPOSURE OF ROOT FLARE. IF ROOT FLARE IS NOT EXPOSED. CAREFULLY REMOVE EXCESS SOIL. SET ROOT BALL SO THAT BASE OF ROOT FLARE IS 3-6" HIGHER THAN ADJACENT FINISH GRADE.

-3" SHREDDED HARDWOOD BARK MULCH. FORM SAUCER AROUND OUTSIDE EDGE. (1" AT BASE OF TRUNK)


EXISTING SUBGRADE -PLANTING PIT TO BE AT LEAST TWICE AS WIDE AS ROOT BALL.

EVERGREEN TREES NOT TO SCALE

NOT TO SCALE

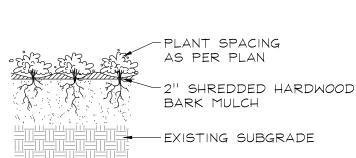

PERENNIALS AND GROUNDCOVERS NOT TO SCALE

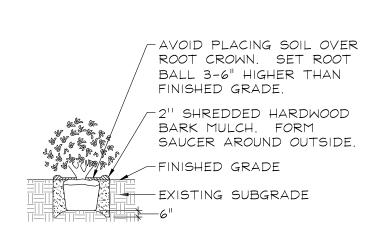

DECIDUOUS AND EVERGREEN SHRUBS

NOT TO SCALE

GARY R. WEBER ASSOCIATES, INC. LAND PLANNING ECOLOGICAL CONSULTING ANDSCAPE ARCHITECTURE 402 W. LIBERTY DRIVE WHEATON, ILLINOIS 60187 PHONE: 630-668-7197

CIVIL ENGINEER **JACOB & HEFNER** ASSOCIATES, INC. 1333 BUTTERFIELD ROAD, SUITE 300 DOWNERS GROVE, ILLINOIS 60515

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12.08.2021 11.15.2021 **REVISIONS**

DATE 9.29.2021 PROJECT NO. JH21115 DRAWN NDS CHECKED GFB SHEET NO.