SECTION 00 91 03 ADDENDUM NUMBER 3

DATE: MARCH 6, 2020

PROJECT: CITY OF AURORA - CITY CLERK AND BUDGET DEPARTMENT

RENOVATION

44 E. DOWNER PLACE AURORA, ILLINOIS 60507

PROJECT NO: 19-130-1267

OWNER: CITY OF AURORA

44 E. DOWNER PLACE AURORA, ILLINOIS 60507

TO: PROSPECTIVE BIDDERS / PLANHOLDERS OF RECORD

This Addendum forms a part of the Contract Documents and modifies the Bidding Documents dated February 14, 2020, with amendments and additions noted below. Acknowledge receipt of this Addendum in the space provided in the Bid Form. Failure to do so may subject the Bidder to disqualification.

This Addendum consists of two (2) pages, Specification Section 01 41 00, and Drawings G100, A310, A800, E210 & E310.

CHANGES TO ADDENDA

1.01 ADDENDUM NUMBER 2 - Issued March 3, 2020

- A. Under CONTRACTOR QUESTIONS
 - 1. Roof patching will be required as part of this project. Is the existing roof under warranty? If yes, please provide the contact information of the contractor installed the roof.
 - a. Existing roof **IS** under warranty. Tremco was the installing Contractor.

CONTRACTOR QUESTIONS

2.01 Is the sub panel (located under the windows) being fed by main panel in closet? I viewed the prints and did not see indication.

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A. Existing sub panel is fed from distribution in basement.

2.02 Can you please provide clarification on drawing E310 relating to the QTY-6 locations by desks with homerun to existing building security system?

A. Contractor to provide duress button and wiring back to Coordinate exact security requirements with Owner's security representative - Alarm Detection Systems, Inc.

2.03 Are these to be in conduit?

A. Security cabling is not required to be in conduit.

2.04 What type of cable and how many per location?

A. For bidding purposes only: assume 1 - 22AWG, 4 wire stranded security cable at each device location.

2.05 Where is the main Security panel located?

A. Main security panel is located in the basement level near the elevator, approximately 60' from area of work.

2.06 Does the City have a security service associated for programming etc.?

A. Alarm Detection Systems, Inc. - (630)844-6302. System # 80014254, Acct # 9611.

2.07 Can you please clarify where the QTY-2 existing fuse panels located on the east wall below the windows originated from? Are these to be totally demoed?

A. Existing fuse panels are fed from distribution panels in basement. These panels are to be demolished. Existing circuits in the panels are to be traced and relocated if branch circuitry is still feeding active devices.

2.08 Confirm asbestos survey was performed and no asbestos found?

A. The Owner has confirmed that testing in other areas was performed. No asbestos is anticipated in the project area.

2.09 Confirm hazardous material abatement (if required) is not to be included by GC.

A. If materials discovered, Owner will address separately.

2.10 Window sills at new metal framed east wall 4' aff: confirm it is drywall sills? I could not find a cut through that wall or see anywhere that solid surface window sills are required.

A. The existing window sills are metal and will remain. Contractor to re-paint to match wall color.

CHANGES TO SPECIFICATIONS

3.01 SECTION 01 41 00 - REGULATORY REQUIREMENTS

A. Updated Paragraph 1.06 - Regulatory Requirements to indicate corrected code references. See attached revised Specification Section 01 42 00.

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CHANGES TO THE DRAWINGS

4.01 DRAWING G100 - COVER SHEET, GENERAL NOTES, SYMBOLS AND DRAWING INDEX

A. Corrected the Applicable Codes section to indicate corrected code references. See attached reissued Sheet G100 reflecting these revisions.

4.02 DRAWING A310 - FIRST FLOOR & REFLECTED CEILING PLAN

- A. Added two fire extinguishers and wall brackets. Refer to Keynote 10.401 and drawing Rooms 111 & 118. See attached re-issued Sheet A310 reflecting these revisions.
- B. Added Keynote to address re-painted of the existing window sill. See re-issued Sheet A310.

4.03 DRAWING A800 - DOOR, FRAME & HARDWARE SCHEDULES, ROOM FINISH SCHEDULE, INTERIOR ELEVATIONS

- A. Detail 3: Revised height of transaction countertop to be 3'-0" AFF and enlarged transaction window size.
- B. Frame Types: Revised size of Frame Type 2. Revised height above finished floor to bottom of window to be 3'-0". Revised window frame height to be 4'-2".
- C. See attached re-issued Sheet A800 reflecting these revisions.

4.04 DRAWING E210 - ELECTRICAL FIRST FLOOR & REFLECTED CEILING DEMOLITION PLAN

A. See attached re-issued Sheet E210 for Revision Cloud 2 items.

4.05 DRAWING E310 - FIRST FLOOR ELECTRICAL POWER PLAN

A. See attached re-issued Sheet E310 for Revision Cloud 2 items.

END OF DOCUMENT

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SECTION 01 41 00 REGULATORY REQUIREMENTS

PART 1 GENERAL

1.01 SECTION INCLUDES

- A. General.
- B. Definitions.
- C. Quality Assurance.
- D. Regulatory Requirements.

1.02 RELATED SECTIONS

- A. Section 01 10 00 Summary.
- B. Section 01 42 00 References.

1.03 GENERAL

- A. Comply with all applicable laws, rules, regulations, codes and ordinances.
- B. If the Contractor observes that the Contract Documents may be at variance with specified codes, notify the Architect/Engineer immediately. Architect/Engineer shall issue all changes in accordance with the General Conditions.
- C. It shall not be the Contractor's primary responsibility to make certain that the Contract Documents are in accordance with all applicable laws, rules and regulations, however, when the Contractor performs work knowing or having reason to know that the work in question is contrary to applicable laws, rules, and regulations, and fails to notify the Architect/Engineer, the Contractor shall pay all costs arising therefrom.

1.04 DEFINITIONS

- A. Definitions:
 - 1. Codes: Codes are statutory requirements, rules or regulations of governmental entities.
 - 2. Standards: Standards are requirements that have been established as accepted criteria, set general consent.

1.05 QUALITY ASSURANCE

- A. The Architect/Engineer has designed the project to applicable code requirements and has copies of said codes available for the Contractor's inspection.
- B. The Contractor shall:
 - 1. Ensure that copies of codes and standards referenced herein or specified in individual specifications sections are available to Contractor's personnel, agents, and Sub-Contractors.
 - 2. Ensure that Contractor's personnel, agents, and Sub-Contractors are familiar with the workmanship and requirements of applicable codes and standards.

1.06 REGULATORY REQUIREMENTS

- A. Source and Requirements: Verify amendments with local code officials.
 - 1. Local code requirements:
 - a. ICC International Building Code, 2015 Edition.
 - b. ICC International Mechanical Code, 2015 Edition.
 - c. ICC International Fire Code, 2015 Edition.
 - d. ICC International Fuel and Gas Code, 2015 Edition.
 - e. ICC International Existing Building Code, 2015 Edition.
 - f. National Electrical Code, 2014 Edition. [ADDENDUM #3].
 - 2. State code requirements:
 - a. Capital Development Board (CDB):
 - 1) 2009 ICC ANSI A117.1 and its references to the 2010 Americans with Disabilities Act. [ADDENDUM #3].
 - 2) 2018 Illinois Accessibility Code [ADDENDUM #3].
 - 3) Illinois Energy Conservation Code (ICC International Energy Conservation Code, 2018 Edition, with State of Illinois modifications. [ADDENDUM #3].
 - b. Illinois Department of Labor (IDOL): Safety Glazing Materials Act Illinois Revised Statutes, chap. 111 1/2, paragraph 3101, et seq.
 - c. Illinois Department of Public Health (IDPH):
 - 1) 2014 Illinois Plumbing Code (Illinois Administrative Code, Title 77, Chapter I, Subchapter r, Part 890). [ADDENDUM #3].
 - d. Illinois Environmental Protection Agency (IEPA):
 - 1) Air-Pollution Standards.
 - 2) Noise Pollution Standards.
 - 3) Water Pollution Standards.
 - 4) Public Water Supplies
 - 5) Solid Waste Standards.
 - 6) Illinois Recommended Standards for Sewage Works (Illinois Administrative Code, Title 35, Subtitle C, Chapter II, Part 370).
 - e. Illinois State Fire Marshal (OSFM):
 - 1) Boiler & Pressure Vessel Safety Code (Illinois Administrative Code, Title 44, Chapter I, Part 120).
 - 2) Illinois Rules & Regulations for Fire Prevention & Safety (as amended).
 - 3) Gasoline and Volatile Oils (Illinois Revised Statutes, chap. 17 1/2, paragraph 31, et seq.).
 - 3. Information and Requirements for Utility Services: Local utility companies.

PART 2 PRODUCTS - NOT USED

PART 3 EXECUTION - NOT USED

END OF SECTION

INDEX OF DRAWINGS

SECOND FLOOR & REFLECTED CEILING DEMOLITION

G100 COVER SHEET, GENERAL NOTES, SYMBOLS, &

A310 FIRST FLOOR & REFLECTED CEILING PLAN

SCHEDULE, INTERIOR ELEVATIONS A1100 INTERIOR PARTITION TYPES & DETAILS

M330 MECHANICAL ROOF PLAN AND SCHEDULES

E310 FIRST FLOOR ELECTRICAL POWER PLAN

E050 ELECTRICAL SYMBOLS LIST & ABBREVIATIONS

ELECTRICAL FIRST FLOOR & REFLECTED CEILING

MF210 MECHANICAL AND FIRE PROTECTION FIRST FLOOR

MF310 FIRST FLOOR MECHANICAL AND FIRE PROTECTION

A320 SECOND FLOOR & REFLECTED CEILING PLAN

DRAWING INDEX

DEMOLITION PLANS

DEMOLITION PLAN

A330 ROOF PLAN

STANDARD ABBREVIATIONS

EXPANSION

FLOOR DRAIN

FOUNDATION

FOUNDATION

FLOOR

FOOTING

GALVANIZED

HARDENER

GAUGE

FIRE EXTINGUISHER

FIRE HOSE CABINET

FURRING CHANNEL

GENERAL CONTRACTOR

GENERAL CONTRACTOR

GYPSUM WALL BOARD (TYPE)

HEATING/VENTILATING/AIR CONDITIONING

INCLUDE / INCLUDING / INCLUDED

INSULATION/INSULATING/INSULATED

LAMINATE /LAMINATING /LAMINATED

MARKERBOARD (LENGTH IN FEET)

MECHANICAL CONTRACTOR

MOP SERVICE BASIN (SINK)

OVERALL OR OUTSIDE AIR

OUTSIDE FACE OR OPPOSITE FACE

OPPOSITE OR OPPOSITE HAND

POUNDS PER SQUARE FOOT

MINIMUM OR MINUTE(S)

GYPSUM PLASTER (TYPE)

HEAVY DUTY OR HARD

HARD WOOD (TYPE)

HOLLOW METAL

INSIDE DIAMETER

KNOCK DOWN

LEFT HAND

LOW POINT

LIGHTWEIGHT

MASONRY

MATERIAL

MAXIMUM

MECHANICAL

MOUNT(ED)

NOMINAL

NUMBER

ON CENTER

NOT IN CONTRACT

OUTSIDE DIAMETER

NOT TO SCALE

LONG LEG VERTICAL

MASONRY OPENING

METAL THRESHOLD

HORIZONTAL

EXP

FDN

FNDN

FUR CHN'L

GEN CONTR

HDNR

LT WT

MB (16)

MECH

NTS

OC

OD

OPNG

EXP CONST

ELECTRIC WATER HEATER

EXPOSED CONSTRUCTION

FIRE EXTINGUISHER CABINET

FIRE RETARDANT TREATED

A. GENERAL NOTES

- ALL CONTRACTORS ARE REQUIRED TO VISIT THE SITE AND BE KNOWLEDGEABLE REGARDING EXISTING CONDITIONS AND THEIR EFFECT ON THE PROPOSED WORK. CONTRACTORS SHALL VERIFY AND BE RESPONSIBLE FOR, ANY CONDITIONS REQUIRING MODIFICATION BEFORE PROCEEDING WITH THE PROJECT.
- 2. NOTIFY THE OWNER'S REPRESENTATIVE A MINIMUM OF 72 HOURS PRIOR TO THE INTERRUPTION OF ANY UTILITY. PROTECT AND KEEP IN SERVICE ACTIVE UNDERGROUND UTILITIES, PIPES, OR CONDUITS, WHETHER INDICATED ON THE DRAWINGS OR NOT, UNLESS SPECIFICALLY CALLED FOR TO BE REMOVED, RELOCATED, OR DISCONNECTED AND
- 4. CONTRACTORS AND SUBCONTRACTORS SHALL COORDINATE THEIR WORK WITH THAT OF OTHER TRADES.
- 5. NO WORK WILL BE PERMITTED TO BE INSTALLED WITHOUT RECIPT AND SUBSEQUENT REVIEW OF FULL AND COMPLETE SUBMITTALS BY THE ARCHITECT/ENGINEER.
- 6. DO NOT SCALE DRAWINGS, DIMENSIONS INDICATED TAKE PRECEDENCE OVER SCALE.

ANCHOR BOLT

ACOUSTICAL CEILING PANEL

ACOUSTICAL CEILING TILE

ADJACENT OR ADJUSTABLE

ABOVE FINISH FLOOR

ABOVE FINISH GRADE

ABRASIVE

ACOUSTIC

ADDITIONAL

ALUMINUM

ALTERNATE

ACCESS PANEL

APPROXIMATI

ANCHOR

ASPHALT

AVERAGE

BASEMENT

BOTTOM OF

BOARD

BETWEEN **BITUMINOUS**

BUILDING

BENCH MARK

BEARING

BRACKET

BLOCKING (WOOD)

BENT STEEL PLATE

CAST-IN-PLACE

CLEAR

CLEAN-OUT

COMBINATION

CONCRETE OPENING

CONCRETE

CONDITION

COUNTER

CENTER(S)

DIMENSION

DRAWINGS

DOOR

DETAIL

DOWELS

ELEVATION

EMBEDMENT

EMERGENCY

EPOXY

EQUAL

EACH

DOOR OPENING

EXPANSION JOINT

ELECTRIC/ELECTRICAL

ELECTRICAL CONTRACTOR

ELEVATOR OR ELEVATION

CONTINUOUS

CONTRACT(OR

CARPET (TYPE)

COUNTER SINK

CERAMIC TILE (TYPE)

CABINET UNIT HEATER

CABINET UNIT VENTILATOR

CEMENT PLASTER (TYPE)

CONCRETE MASONRY UNIT

COMPRESSIBLE OR COMPACTED

CERAMIC PAVER TILE (TYPE)

CONSTRUCTION OR CONTRACTION JOINT

AUTOMATIC

ADDITION

ABR

ANCHR

APPROX

CEM PL-(1)

CT PAV-(1

COMP

CONC

CONT

CONTR

CPT-(1

CT-(1)

CTR SK

CTR

CTRS

DWGS

DWL'S

ELEC

ELEV

EMBED

EMER

ELEC CONTR

CONC OPNG

- VERIFY ALL DIMENSIONS AND ELEVATIONS IN THE FIELD. WHERE DISCREPANCIES ARE FOUND BETWEEN DIMENSIONS OR ELEVATIONS SHOWN AND ACTUAL FIELD CONDITIONS, NOTIFY ARCHITECT/ENGINEER.
- WHERE CONFLICTS MAY EXIST BETWEEN THE REQUIREMENTS OF PORTIONS OF THE CONTRACT DOCUMENTS. THE GREATER QUANTITY, HIGHER QUALITY OR MORE STRINGENT REQUIREMENT SHALL GOVERN. THEREFORE, BY EXECUTING A CONTRACT FOR CONSTRUCTION. THE CONTRACTOR AGREES THAT, IF IT RAISED NO QUESTIONS REGARDING SUCH CONFLICTS DURING THE BIDDING PROCESS. AND IN THE ABSENCE OF A CLARIFYING ADDENDUM ISSUED DURING THE BIDDING PROCESS, IT HAS VOLUNTEERED TO COMPLY WITH THE MORE EXPENSIVE REQUIREMENT AS PART OF ITS BASE BID AND IS NOT ENTITLED TO ANY ADDITIONAL COMPENSATION TO RESOLVE THE CONFLICT.
- 9. THE CONTRACT DOCUMENTS REQUIRE THE CONTRACTOR TO FURNISH AND INSTALL COMPLETE PRODUCTS. SYSTEMS COMPONENT OR UNIT OF A PRODUCT, SYSTEM OR SERVICE. THE CONTRACTOR FURTHER AGREES THAT, AS PART OF ITS BID, IT MUST FURNISH AND INSTALL EVERY LENGTH, SEGMENT, PIECE, PART, COMPONENT OR UNIT OF A PRODUCT, SYSTEM OR SERVICE AND, CONSEQUENTLY, THE CONTRACTOR IS NOT ENTITLED TO ANY ADDITIONAL COMPENSATION FOR ANY LENGTH, SEGMENT, PIECE, PART COMPONENT OR UNIT OF A PRODUCT, SYSTEM OR SERVICE BECAUSE IT IS NOT EXPRESSLY DEPICTED HEREIN.

B: MISCELLANEOUS AND DEMOLITION NOTES

- COORDINATE PENETRATIONS AND/OR SLEEVES REQUIRED IN WALLS, FLOORS, CEILINGS OR ROOFS FOR MECHANICAL AND ELECTRICAL WORK REQUIRED BY ARCHITECTURAL, MECHANICAL, ELECTRICAL, AND
- SEAL WITH UL APPROVED MATERIALS PENETRATIONS OF DUCTWORK, CONDUIT AND PIPES THROUGH FIRE-RATED ASSEMBLIES, TO MAINTAIN THE RATING INTEGRITY OF THOSE ASSEMBLIES. PROVIDE FIRE DAMPERS AS INDICATED ON THE DRAWINGS.

SEAL WITH ACOUSTICAL SEALANT PENETRATIONS OF DUCTWORK, CONDUIT AND PIPES THROUGH

- NON-RATED FLOORS, FULL-HEIGHT WALLS/PARTITIONS, ACOUSTICALLY INSULATED WALLS/PARTITIONS. AND SOUND-RATED WALLS/PARTITIONS, TO MAINTAIN THE ACOUSTICAL INTEGRITY OF THOSE
- APPLY APPROPRIATE & COMPATIBLE SEALANT MATERIALS AS REQUIRED TO SEPARATE DISSIMILAR METALS, FILL GAPS IN EXISTING ASSEMBLIES OR WHERE NEW AND EXISTING ASSEMBLIES MEET OR WHERE OTHERWISE REQUIRED BY THE SPECIFICATIONS.
- BRING ANY UNFORESEEN OR CONFLICTING CONDITIONS TO THE IMMEDIATE ATTENTION OF THE ARCHITECT/ENGINEER BEFORE PROCEEDING WITH THE WORK.
- REPAIR. PATCH. OR REPLACE FINISH MATERIALS OR VISIBLE ASSEMBLIES THAT ARE SOILED. CUT OR DAMAGED IN ANY FASHION DURING THE COURSE OF THE WORK. PERFORM PATCHING SUCH THAT EDGES BLEND INTO CONTIGUOUS SURFACES SMOOTHLY, MATCHING TEXTURE AND COLOR OF ADJACENT
- KLUBER INC. HAS REVIEWED THE IMPOSED LOADINGS TO THE EXISTING STRUCTURE BY THE NEW EQUIPMENT AND MODIFICATIONS ARE NOT REQUIRED. THE EXISTING ROOF STRUCTURE IS A CAST IN PLACE CONCRETE PAN JOIST SYSTEM THAT HAS BEEN DESIGNED AS A FLOOR SYSTEM IDENTICAL TO THE FLOOR BELOW. THE NEW EQUIPMENT HAS A TOTAL WEIGHT OF 375 POUNDS. THIS LOADING IS CONSIDERED NEGLIGIBLE AND WILL NOT ADVERSELY IMPACT THE EXISTING STRUCTURE.

PVMT

PLAM

PLB'G

R OR RAD

SCHED

SOG

SPEC(S)

SPK'R

STD

STD WT

STRUCT

T/BEAM

T/BEAM

T/FNDN

VEN PL (1)

VERT

SYM

SEAL/HDNR

PAVEMENT PIECE

PLASTIC LAMINATE(D)

PLUMBING CONTRACTOR

POLYVINYL CHLORIDE

GYPSUM PLASTER (TYPE)

RUBBER FLOORING (TYPE)

REINFORCE/REINFORCING/REINFORCED

PRECAST (CONCRETE) OPENING

PLATE

PLASTER

PLUMBING

PLYWOOD

RADIUS

ROOF DRAIN

RIGHT HAND

REQUIRED

SQUARE FOOT

SQUARE INCH

SERVICE SINK

SQUARE

SECTION

SIMILAR

SPACING

SPEAKER

STANDARD

SUSPEND(ED)

SYMMETRICAL

TOP OF BEAM

TOP OF CURB

TOP OF STEEL

TOP OF WALL

TOP OF MASONRY

VINYL BASE COVED

VERTICAL

WITHOUT

WINDOW

WEIGHT

WATER PROOF

WIDE OR WIDTH

VINYL BASE STRAIGHT

VINYL COMPOSITION TILE

VENEER PLASTER (TYPE)

WALL CORNER GUARD

WELDED WIRE FABRIC

WALL SERVICE BASIN

SCHEDULE

STAINLESS STEEL

SEALER/HARDENER

SLAB ON GRADE

SPECIFICATION(S)

STANDARD WEIGHT

TONGUE AND GROOVE

TOP OF FOUNDATION

TACKBOARD (LENGTH IN FEET)

(WINDOW) UNIT DIMENSION

UNLESS NOTED OTHERWISE

STRUCTURE OR STRUCTURAL

ROUGH OPENING

6 A9.16 5	SYMB	AURORA
A6.05	30LS /	ILLINOI
. 26	Z	
. 26	M	CITY OF LIGHT

DR.

TING

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S

DETAIL NUMBER-DRAWING NUMBER —

DETAIL NUMBER-

DETAIL NUMBER

DRAWING NUMBER -

DETAIL NUMBER -

DRAWING NUMBER -

REFERENCE LINE NO.

COLUMN NO.

ELEVATION

NUMBER

DOOR NO. NEW

DOOR NO. EXISTING

NOMINAL THICKNESS · CONSTRUCTION TYPE SPECIAL CONDITION

IDENTIFICATION

WINDOW TYPE IDENTIFICATION

TOILET ACCESSORY

IDENTIFICATION

ELEVATION

CONCRETE

CONCRETE

BRICK MASONRY IN

MASONRY IN PLAN

(RUNNING BOND)

MASONRY IN PLAN

STONE MASONRY I

RAKED JOINT IN

CTRL./EXP. JOIN

BRICK MASONRY

SECTION DETAIL

CONCRETE

MASONRY IN

SECTION DETAIL

STONE MASONRY II

SECTION DETAIL

STEEL IN SECTION

DISCONTINUOUS

ROUGH WOOD

BLOCKING IN

CONTINUOUS

in Section

ROUGH WOOD

FRAMING/BLOCKING

FINISHED WOOD IN

SECTION DETAIL

RIGID BOARD

INSULATION

RIGID BOARD

INSULATION

BATT INSULATION

GYPSUM BOARD

ACOUSTICAL

BITUMINOUS

AGGREGATE

SECTION

EARTH

UNDISTURBED

EARTH BACKFILL

(ASPHALT) PAVING

BALLAST, FILL OR BACKFILL IN

CONCRETE

CEILING PANEL

(ROOFING)

(STACK BOND)

203.2

203.1X

DRAWING NUMBER —

CITY OF AURORA - CITY CLERK **PROJECT**

AND BUDGET DEPT. RENOVATIONS

44 E. DOWNER PLACE AURORA, IL 60507

CITY OF AURORA **OWNER**

44 E. WEST DOWNER PLACE

AURORA, IL 60507

ARCHITECT/ **KLUBER ARCHITECTS + ENGINEERS**

10 S. SHUMWAY AVE. **ENGINEER BATAVIA, ILLINOIS 60510** TEL (630) 406-1213

FAX (630) 406-9472 www.kluberinc.com

100% CONSTRUCTION DOCUMENTS

REQUIRED CODE COMPLIANCE INFORMATION

UNDER 2015 INTERNATIONAL CODES STATE OF ILLINOIS ACCESSIBILITY CODE, AND THE STATE OF ILLINOIS PLUMBING CODE CODE REVIEW DATA

GENERAL STATEMENT OF OVERALL PROJECT SCOPE AND INTENT


PROJECT CONSISTS OF INTERIOR ALTERATIONS AND REMODELING TO AN EXISTING MULTI-STORY OFFICE BUILDING. BUILDING COMPONENTS AND SYSTEMS MODIFIED OR REPLACED AS PART OF THE WORK OF THIS PROJECT HAVE BEEN BROUGHT UP TO MEET THE REQUIREMENTS OF THE APPLICABLE CURRENT CODES. THE AREAS ALTERED FOR OFFICE USE ARE CLASSIFIED AS GROUP B

- A. USE AND OCCUPANCY GROUP(S) CLASSIFICATION: B.
- B. TYPE OF CONSTRUCTION: IIB
- C. SQUARE FOOTAGE OF BUILDING: NOT APPLICABLE; RENOVATED AREAS SQUARE FOOTAGE IS 1,229. ALLOWABLE SQUARE FOOTAGE: NOT APPLICABLE; NO CHANGE OF USE.
- FULLY SPRINKLERED; ALARMED OCCUPANT LOAD BASED ON INTERNATIONAL BUILDING CODE: 36 BUSINESS OCCUPANCY
- OCCUPANT LOAD BASED ON ILLINOIS PLUMBING CODE: 18
- DESIGNED LIVE LOADS: NOT APPLICABLE; THIS IS AN EXISTING BUILDING, TO WHICH NO MODIFICATIONS ARE BEING MADE TO STRUCTURAL COMPONENTS.
- G. THE DESIGN PROFESSIONALS IN RESPONSIBLE CHARGE ARE IDENTIFIED IN THE SEALS AND CERTIFICATES AREA, BELOW.


SEALS & CERTIFICATIONS

I HAVE PREPARED, OR CAUSED TO BE PREPARED UNDER MY DIRECT SUPERVISION, THE ATTACHED PLANS AND SPECIFICATIONS AND STATE THAT TO THE BEST OF MY KNOWLEDGE AND BELIEF, AND TO THE EXTENT OF MY CONTRACTUAL OBLIGATION, THEY ARE IN COMPLIANCE WITH IBC 2015 EDITION, THE ENVIRONMENTAL BARRIERS ACT AND THE ILLINOIS ACCESSIBILITY


KLUBER, INC. ILLINOIS PROFESSIONAL DESIGN FIRM LICENSE #184-001284

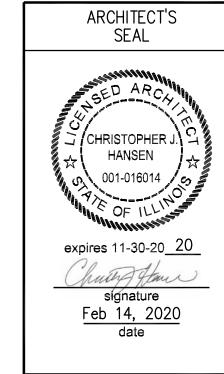


"G" SERIES. "A" SERIES

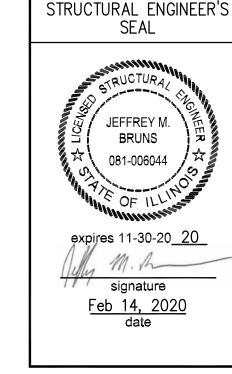

"G" SERIES. NEW EQUIPMENT LOADING SEE NOTE B.7

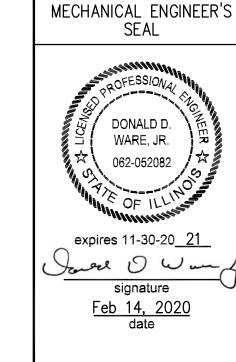

"G" SERIES, "M" SERIES, "F" SERIES

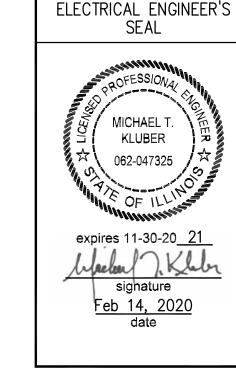

APPLICABLE CODES

2015 INTERNATIONAL BUILDING CODE

2015 INTERNATIONAL FIRE CODE

2018 ILLINOIS ACCESSIBILITY CODE

> 2014 NATIONAL ELECTRICAL CODE

2014 ILLINOIS PLUMBING CODE

2009 ICC/ANSI A117.1

2015 INTERNATIONAL MECHANICAL CODE

2015 INTERNATIONAL FUEL AND GAS CODE

2015 INTERNATIONAL EXISTING BUILDING CODE

LOCAL AMENDMENTS TO THE ABOVE CODES

2018 INTERNATIONAL ENERGY CONSERVATION CODE

"G" SERIES, "E" SERIES

A210 FIRST FLOOR & REFLECTED CEILING DEMOLITION PLAN A800 DOOR, FRAME & HARDWARE SCHEDULES, ROOM FINISH


COVER SHEET, **GENERAL NOTES,** SYMBOLS AND **DRAWING INDEX**

JOB NO. 19-130-1267 CHECKED APPROVED SHEET TITLE

SHEET NUMBER

EACH WAY POUNDS PER SQUARE INCH ELECTRIC WATER COOLER PRESSURE TREATED OR PAINT

THE MATERIALS, ABBREVIATIONS, AND DRAFTING SYMBOLS LEGEND ARE EACH AN ALL INCLUSIVE MASTER LIST USED BY THIS FIRM. THE INCLUSION OF THESE LEGENDS INTO THESE DOCUMENTS DOES NOT IMPLY THAT ALL THE SYMBOLS OR MATERIALS INCLUDED IN THESE LEGENDS ARE INCORPORATED INTO THIS PROJECT. ABBREVIATIONS MAY APPEAR WITH PERIODS OR OTHER PUNCTUATION SEPARATING CHARACTERS ON THE DRAWINGS; THE MEANING REMAINS THE SAME.

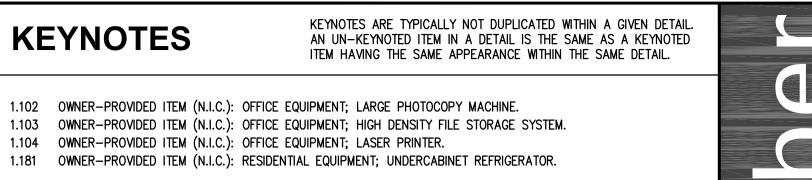

8.310 ACCESS DOOR: VENTED TYPE TO ALLOW ACCESS TO STEAM PIPE CHASE. TOTAL QUANTITY (12) AT SOUTH

WALL LOCATION OF RENOVATION DEVELOPMENT AREA. REFER TO SPECIFICATIONS. 9.212 GYPSUM BOARD: 5/8" THICK; TYPE "X" - WALL PATCHING AT REMOVED WALL OR ELECTRICAL DEVICE

LOCATIONS. TYPICAL THROUGHOUT RENOVATION SPACE WHETHER INDICATED OR NOT.

9.213 GYPSUM BOARD: 5/8" THICK; TYPE "X" OVER 1/2" KEVLAR PANELS FULL HEIGHT FROM FLOOR TO CEILING LINE AT TRANSACTION COUNTER LOCATION. REFER TO SPECIFICATIONS.

9.510 ACOUSTICAL CEILING PANELS AND GRID. 9.921 INTERIOR PAINTING: PREPARE, PRIME AND TWO COATS OF WHITE SEMI-GLOSS PAINT ON EXISTING "L-SHAPED" 🖍

METAL DRAPERY POCKET TRIM SCHEDULED FOR RE-USE. TYPICAL.

9.922 INTERIOR PAINTING: EXISTING METAL WINDOW SILL TO REMAIN; RE-PAINT TO MATCH NEW WALL COLOR.

10.263 CORNER GUARD; FULL WALL HEIGHT. MOUNT 4.5" A.F.F. TO CEILING LINE. REFER TO SPECS.

10.401 FIRE EXTINGUISHER AND WALL BRACKET; DRY CHEMICAL TYPE, CLASS A-B-C, SIZE 10. LARSEN'S MANUFACTURING COMPANY OR EQUAL. PROVIDE INSPECTION / CERTIFICATION TAG AND GRAPHIC IDENTIFICATION ON WALL. SIGN PRODUCT: WWW.COMPLIANCESIGNS.COM; FIRE EXTINGUISHER SIGN NHE-27897 PROJ (2D

PROJECTION MOUNT). INSTALL SIGN AT 80 INCHES A.F.F. INSTALL BRACKET AT 48" A.F.F.

12.240 ROLLER WINDOW SHADES: MANUALLY OPERATED.


21.130 SPRINKLER PIPING/FITTING/HEAD; REFER TO FIRE PROTECTION DRAWINGS.

23.370 MECHANICAL DIFFUSER/GRILLE: MAKE UP AIR; REFER TO MECHANICAL DRAWINGS. 23.371 MECHANICAL EQUIPMENT: V.R.F. UNIT. REFER TO MECHANICAL DRAWINGS.

23.372 MECHANICAL EQUIPMENT COVER: PREFINISHED BEIGE METAL HEATING SUPPLY AND RETURN PIPING COVER TO CONCEAL EXPOSED HVAC PIPES. PROVIDE 1" PIPE INSULATION ON PIPING PRIOR TO ENCASING BEHIND NEW METAL COVERS. METAL COVERS AS APPROVED BY OWNER.

26.001 LIGHT FIXTURE: REFER TO ELECTRICAL DRAWINGS.

CORNER GUARD LEGEND

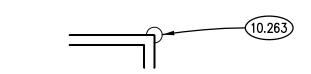

CEILING SYMBOL LEGEND

SYMBOL	DESCRIPTION	SYMBOL	DESCRIPTION
	ACQUICTICAL OFFILING THE C' V 4'	\boxtimes	MECHANICAL DIFFUSER: SUPPLY
	ACOUSTICAL CEILING TILE: 2' X 4'	Ø	MECHANICAL DIFFUSER: RETURN
		回	MECHANICAL DIFFUSER: EXHAUST
			MECHANICAL DIFFUSER: LINEAR SUPPLY
			LIGHT FIXTURE: 2' X 4'

100


ROOM SCHEDULE

RM. NO.	ROOM NAME	RM. NO.	ROOM NAME
100	EXISTING LOBBY	117	CLERK TRANSACTION COUNTER
105	EXISTING CORRIDOR	118	WORK AREA
110	CORRIDOR	119	OPEN OFFICE
111	FINANCE		
112	OFFICE		
113	EXISTING ELECTRICAL ROOM		
114	OFFICE - FINANCE DIRECTOR	200	EXISTING STAIRWAY
115	FILES	201	EXISTING COUNCIL CHAMBERS
116	CLERKS OFFICE	202	EXISTING EQUIPMENT CLOSET

GENERAL NOTES

- 1. REFER TO DRAWING G100 FOR PROJECT GENERAL NOTES.
- 2. GYPSUM WALLS ARE WALL TYPE G3e UNLESS TAGGED OTHERWISE.
- 3. IN METAL STUD/GYPSUM BOARD PARTITIONS AND WALLS, PROVIDE 2X FIRE RETARDANT TREATED WOOD BLOCKING FOR WALL-MOUNTED ITEMS REQUIRING MECHANICAL ANCHORAGE.
- 4. SPOT ELEVATIONS ARE DESIGNATED NOMINAL HEIGHTS ABOVE FINISHED FLOOR UNLESS NOTED OTHERWISE. COORDINATE FINAL HEIGHTS OF CEILING ELEMENTS WITH INFORMATION CONTAINED ON STRUCTURAL, MECHANICAL, PLUMBING, FIRE PROTECTION AND ELECTRICAL DRAWINGS.
- ALL CEILING TO BE AT A HEIGHT OF 9'-0" ABOVE FINISHED FLOOR UNLESS OTHERWISE NOTED.
- ARE NOT SHOWN FOR REUSE. REMOVE ANY IN WALL JUNCTION BOXES, CONDUIT AND WIRING BACK TO SOURCE. CONTRACTOR SHALL INCLUDE IN HIS BID THE PATCHING OF ALL WALL, FLOOR AND CEILING SURFACES WITH PRODUCTS TO MATCH EXISTING AND REFINISH ENTIRE SURFACE WITH ONE COAT OF PRIMER AND TWO COATS OF PAINT. TYPICAL.

KEY PLAN

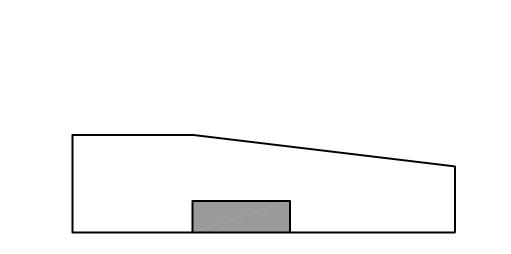


AND

FIRST FLOOR & REFLECTED CEILING

SHEET NUMBER


SHEET TITLE

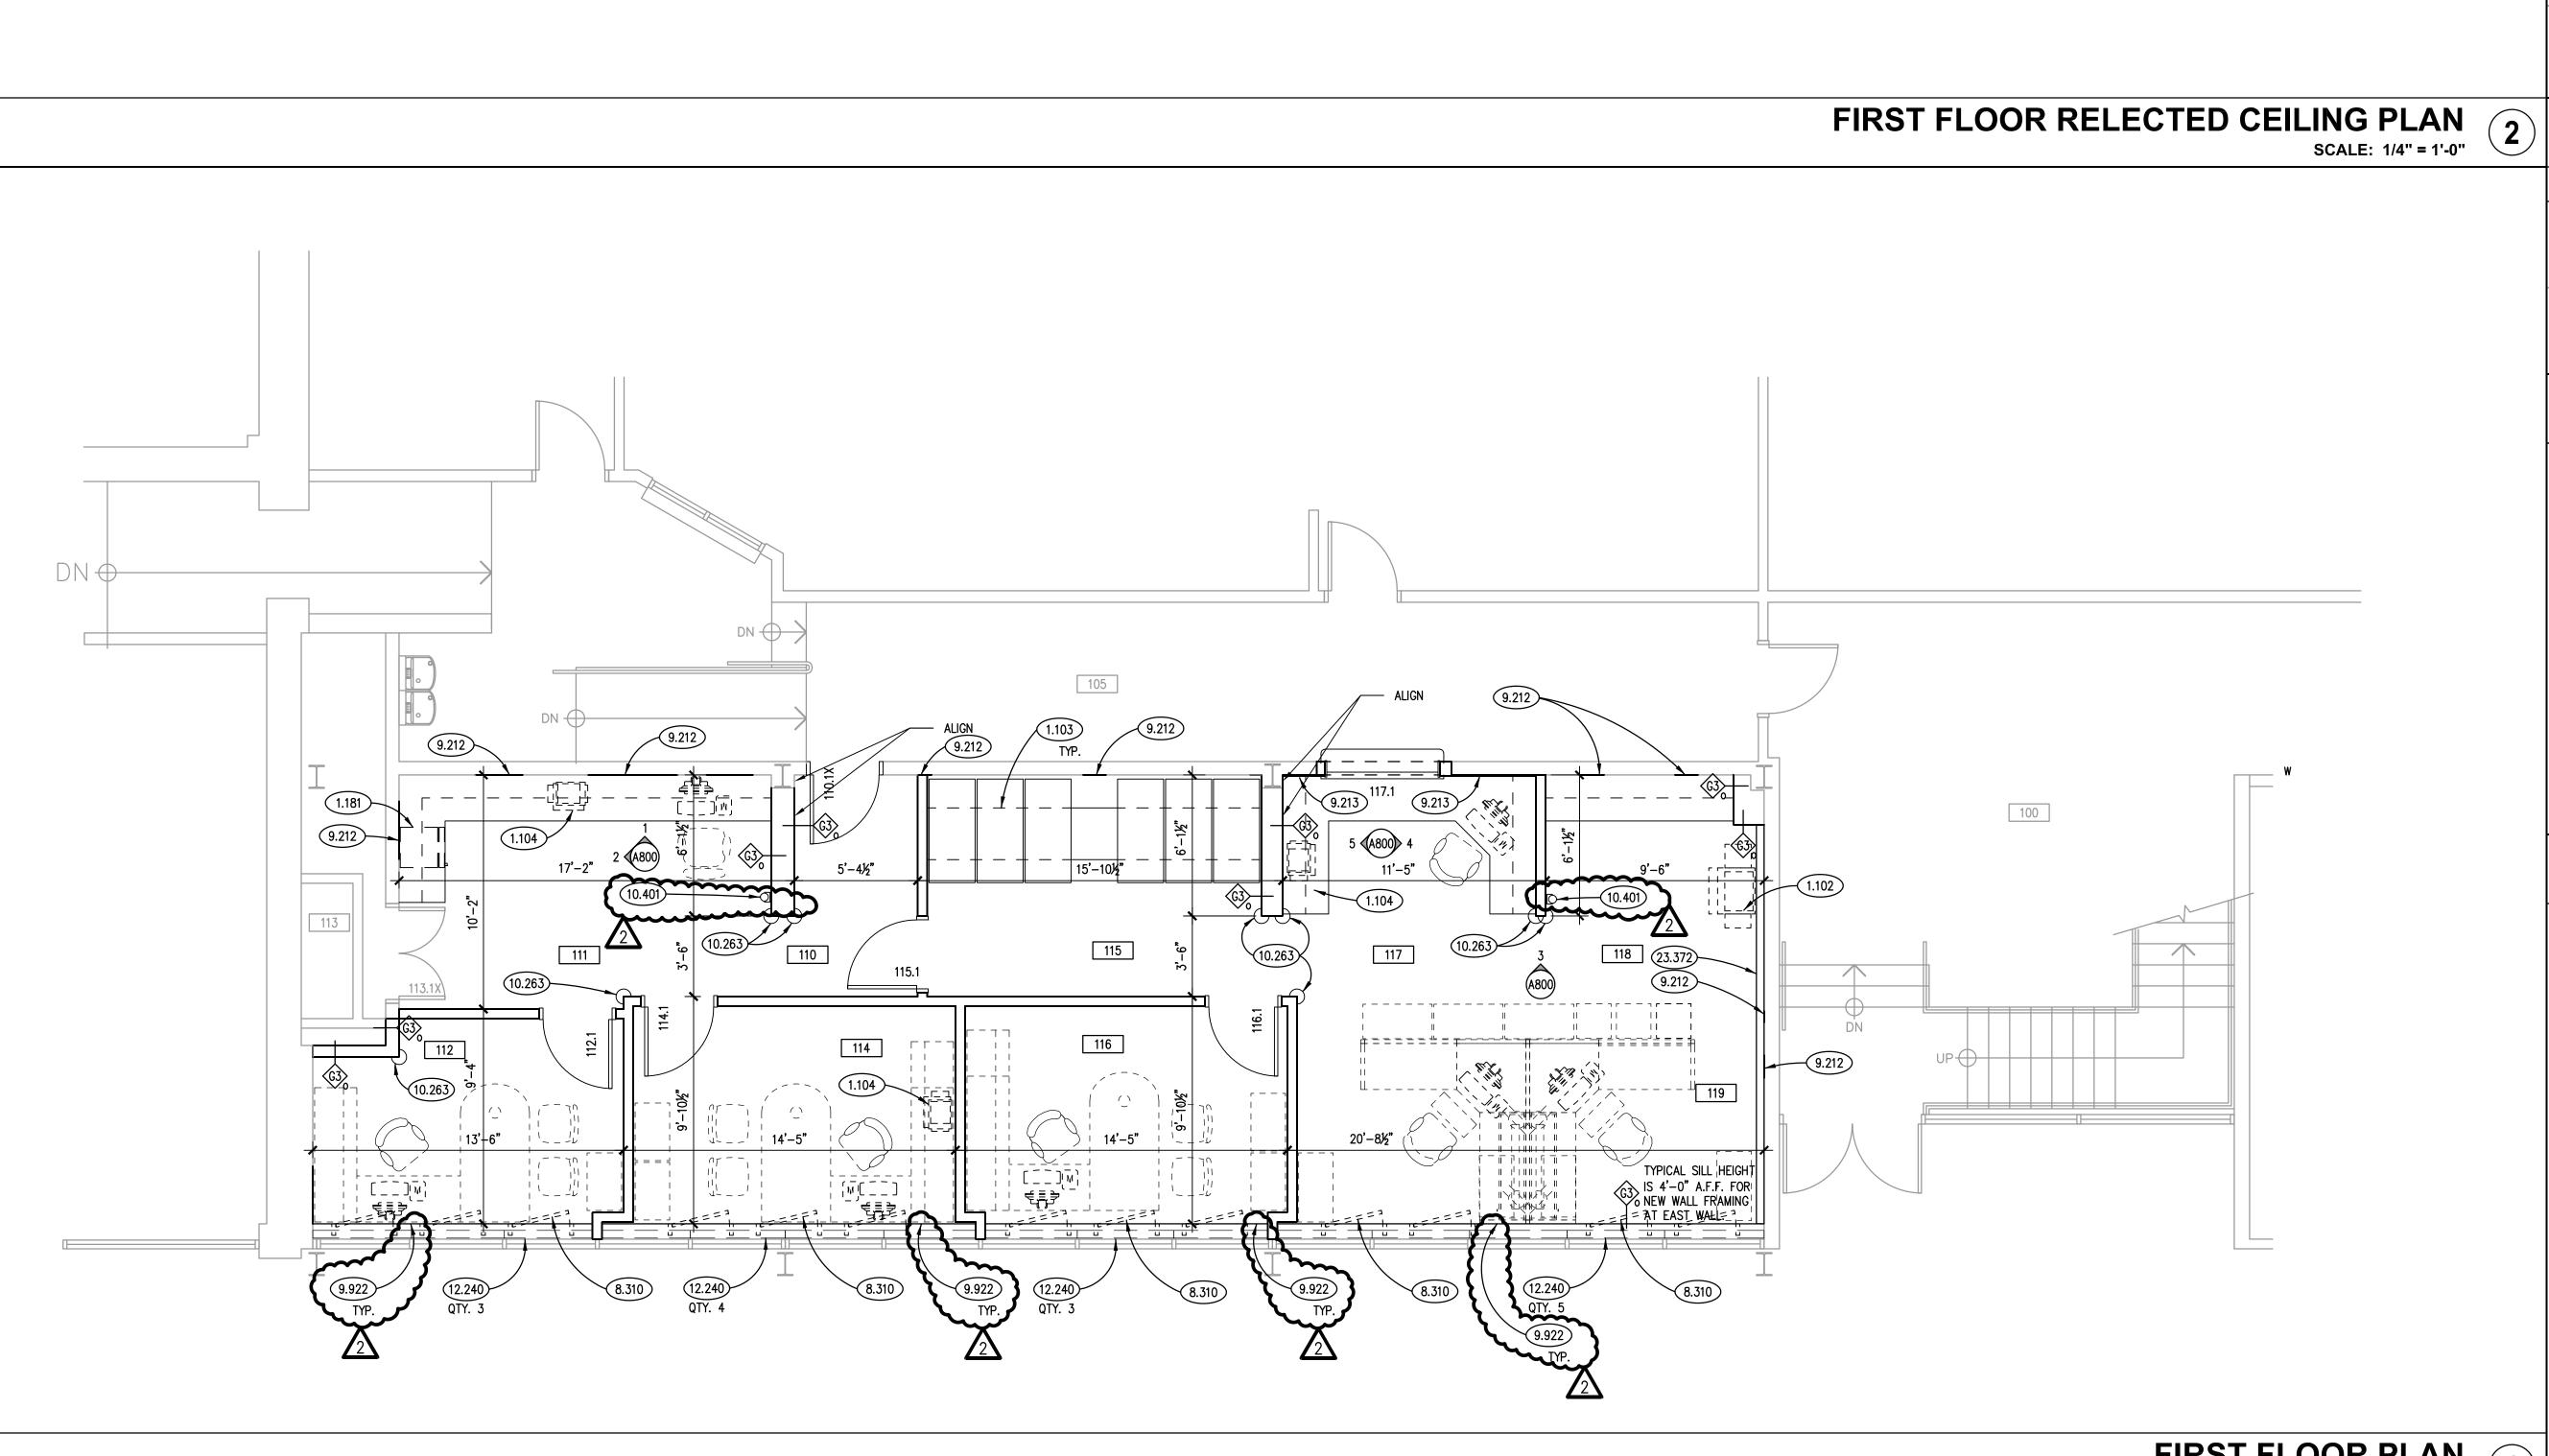

105

FIRST FLOOR PLAN

SCALE: 1/4" = 1'-0"

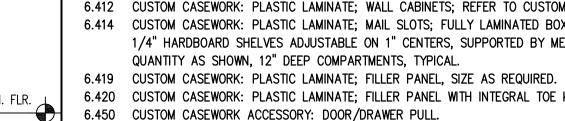

6.450	CUSTOM CASEWORK ACCESSORY: DOOR/DRAWER PULL.
6.461	CASEWORK ACCESSORY: COUNTER SUPPORT BRACKET. METAL. REFER TO SPECIFICATIONS.
8.110	STEEL DOOR FRAME: REFER TO DOOR, FRAME AND BORROWED LIGHT SCHEDULE.

0.110	CIELE BOOK TRAME. RELEX TO BOOK, TRAME AND BOTHOURS EIGHT CONEBCE.
8.111	STEEL INTERIOR WINDOW FRAME: REFER TO DOOR, FRAME AND BORROWED LIGHT SCHEDULE.
8.142	WOOD DOOR: REFER TO DOOR, FRAME AND BORROWED LIGHT SCHEDULE.
8.800	GLAZING: REFER TO DOOR/FRAME/WINDOW SCHEDULES FOR TYPE.

9.213	GYPSUM BOARD: 5/8" THICK; TYPE "X" OVER 1/2" I	KEVLAR PANELS FULL HEIGHT FROM FLOOR TO CEILING
	LINE AT TRANSACTION COUNTER LOCATION. REFER	TO SPECIFICATIONS.

	LINE AT TRANSACTION COUNTER LOCATION.	REFER	TO S
9.651	RESILIENT BASE: REFER TO A800 DRAWING.		

12.365	COUNTERTOP:	SOLID	SURFACING;	1-1/4"	EDGE	THICKNESS,	U.N.O.

DOOR HARDWARE SCHEDULE REMARKS	DOOR SCHEDULE REMARKS

D.O.

DOOR TYPES

	DOOR HARDWARE SCHEDULE													
SET NO.	HINGES	LOCK SET	EXIT DEVICE	CLOSER	HOLDER	STOP	THRES- HOLD	KICK PLATE	MOP PLATE	WEATHER STRIPPING	SWEEP	PUSH/ PULL	REMOV. MULLION	REMARKS
1	BUTT	OFFICE	_	_	_	WALL	_	_	_	_	_	_	_	1
2	BUTT	ENTRY	_	YES	_	WALL	_	YES	_	_	_	_	_	2
3	BUTT	CLASSROOM	-	-	-	WALL	-	YES	_	_	_	-	_	3

ROOM NO.

CORRIDOR

FINANCE

114 OFFICE - FINANCE DIRECTOR

117 CLERK TRANSACTION COUNTER

CLERKS OFFICE

WORK AREA 119 OPEN OFFICE

OFFICE

ROOM NAME

 OFFICE FUNCTION LOCKSET. 2. EXISTING DOOR FRAME, ELECTRIC STRIKE, DOORBELL & CARD READER TO BE REUSED. FURNISH AND INSTALL NEW ENTRY LOCKSET, BUTT HINGES, WOOD DOOR, WALL STOP, DOOR GLAZING, CLOSER AND KICK PLATE.

OFFICE FUNCTION LOCKSET.

1. UNDERCUT DOOR 3/4".

HDWR RATING REMARKS (MIN.)

2.	BULLET RESISTANT GLAZING IN HOLLOW METAL FRAME.	REFER TO SPECIFICATIONS FOR GLAZING INFORMATION AND THICKNESS.

D.O.

								R
	ROOM NO.		ROOM NAME			FLOO		
						FIN.	CC.	FIN.
	100	EXISTING LOBB	Υ			EX	_	EX
	105	EXISTING CORF	RIDOR	·		EX	-	EX
	110	CORRIDOR	<u> </u>	<u> </u>		F2	CPT1	B1


DOOR AND FRAME SCHEDULE

GA. MDL. CORE GRD. CORE VENEER CUT MATCH

WOOD DOORS

STEEL DOORS

	ROOM FINISH SCHEDULE											COLOR CODES SCHEDULE												
ЭМ	ROOM NAME	FLO	OOR	В	ASE	NO	ORTH	SO	WA	LLS EA	ST	WF	EST	CEI	LING	REMARKS		FINIS	SH E MATERIAL		DECORPTION			AREA
0.	ROOM NAME	FIN.	CC.	FIN.	CC.	FIN.	cc.	FIN.	cc.	FIN.	cc.	FIN.	cc.	FIN.	CC.		AREA	COD	E MATERIAL	MANUFACTURER	DESCRIPTION			FLOOR
100	EXISTING LOBBY	EX	_	EX	_	EX	_	EX	-	EX		EX	_	EX	_	- A	FLOORING	CPT	1 BROADLOOM CARPET	MOHAWK GROUP	PRODUCT: PURE GENIUS II COLLECTION	; ARTIST II		
105	EXISTING CORRIDOR	EX	_	EX	_	EX	_	EX	_	P1) 1	_	EX	_	EX	_	6)1	T LOOKING				COLOR: 689 ARCHITECT	<u>*</u>		1
110	CORRIDOR	F2	CPT1	B1	RB1	P1	PT1	P1	PT1	PI	PT3	P1	PT1	C1	ACT1	4					CARPET PAD: AS SPECIFIED			
111	FINANCE	F2	CPT1	B1	RB1	P1	PT1	P1	PT1	P1	PT3	P1	PT1	C1	ACT1	4								
112	OFFICE	F2	CPT1	B1	RB1	P1	PT3	P1	PT1	P1	PT1	P1	PT1	C1	ACT1	4, 5	WALL BASE	RB ⁻	RUBBER BASE	MANNINGTON	SERIES: TRADITIONAL; SYNC LINE	COLOR	: #904 – BARK	
113	EXISTING ELECTRICAL ROOM	EX	-	EX	_	EX	_	EX	_	EX	-	EX	_	EX	_						TYPE: COVE	SI	ZE: 4" H.	BASE
114	OFFICE - FINANCE DIRECTOR	F2	CPT1	B1	RB1	P1	PT1	P1	PT3	P1	PT1	P1	PT1	C1	ACT1	4, 5								1
115	FILES	F2	CPT1	B1	RB1	P1	PT1	P1	PT1	P1	PT3	P1	PT1	C1	ACT1	4		PT'	PAINT - FIELD	PPG	COLOR: CREAM 9-300XI/01 (#947203		FINISH: EGGSHELL	
116	CLERKS OFFICE	F2	CPT1	B1	RB1	P1	PT3	P1	PT1	P1	PT1	P1	PT1	C1	ACT1	4, 5	WALLS				TYPE: LOW VOC	INTERIOR WAI	LLS) REFER TO SPEC.	
117	CLERK TRANSACTION COUNTER	F2	CPT1	B1	RB1	P1	PT1	P1	PT1	P1	PT1	P1	PT3	C1	ACT1	4								WALLS
118	WORK AREA	F2	CPT1	B1	RB1	P1	PT3	P1	PT1	P1	PT1	P1	PT1	C1	ACT1	4		PT2	PAINT	PPG	COLOR: TO BE DETERMINED (DOOR FR	AMES)	FINISH: SEMI-GLOSS	
119	OPEN OFFICE	F2	CPT1	B1	RB1	P1	PT3	P1	PT1	P1	PT1	P1	PT1	C1	ACT1	4, 5					TYPE: LOW VOC		REFER TO SPEC.	
																	4	PTS	3 PAINT	PPG	ACCENT WALL COLOR: TO BE DETERM	MED	FINISH: EGGSHELL	GLASS
						1												F 13	PAINT		TYPE: LOW VOC	NED	REFER TO SPEC.	02/100
200	EXISTING STAIRWAY	EX	_	FX	_	EX	_	FX	_	EX	_	FX	_	FX	_		\dashv				TIFE. LOW VOC		REFER TO SPEC.	
201	EXISTING COUNCIL CHAMBERS	EX	_	FX	_	EX	_	FX	_	EX	_	FX	_	FX	_									
202	EXISTING EQUIPMENT CLOSET																							
																		CG.	CORNER GUARDS	KOROGARD	PRODUCT: G815 COLOR: TO BE	SELECTED TO	MATCH WALL COLOR	
																	WALL				SIZE: 1-1/2" FULL WALL HEIGHT			1
																	PROTECTION							1
	i			1									1	i						1				1

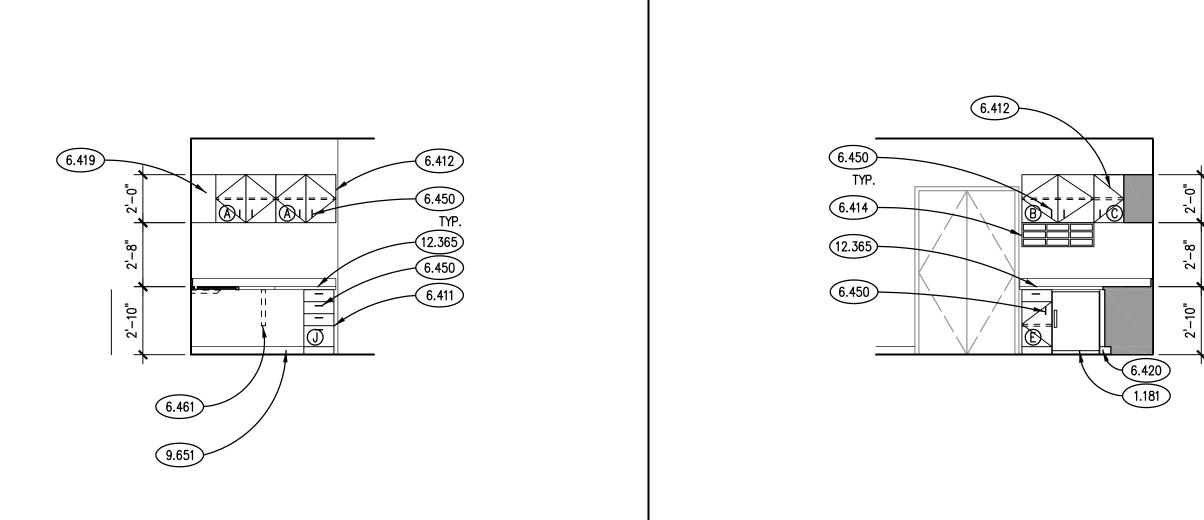

	CG1	CORNER GUARDS	KOROGARD	PRODUCT: G815 COLOR: TO BE SELECTED TO MATCH WALL COLOR	
WALL				SIZE: 1-1/2" FULL WALL HEIGHT	
PROTECTION					
CEILINGS	ACT1	ACOUSTIC CEILING TILE	CERTAINTEED	SYSTEM: PERFROMA - BAROQUE SIZE: 24"x24"x5/8" COLOR: WHITE	
				EDGE: REVEAL BET-164	4
				GRID: TEE; 15/16" (TYPE SS1)	
					2
COUNTERTOP	SSM1	SOLID SURFACE	WILSONART	COLOR: CHAMPAGNE ICE 9205CE THICKNESS: 1/2"	
MATERIAL				· · · · · · · · · · · · · · · · · · ·	3
					4
MILLWORK	PLAM1	PLASTIC LAMINATE	WILSONART	COLOR: 7919-38 AMBER CHERRY FINISH: MATTE	'
					5
					~
SPECIALTY	SP1	WINDOW SHADES	THERMOVEIL	PRODUCT: MECHOSHADE SYSTEMS STYLE: 3000 SERIES SATIN	6
				COLOR: AS SELECTED OPACITY: 3% OPEN	

FRAME TYPES

D.0.

TAG	TYPE	WIDTH	HEIGHT	DEPTH	DESCRIPTION
Α	WALL	30"	24"	12"	CONFIGURATION AS SHOWN
В	WALL	36"	24"	12"	CONFIGURATION AS SHOWN
С	WALL	15"	24"	12"	CONFIGURATION AS SHOWN
D	WALL	30"	36"	12"	CONFIGURATION AS SHOWN
E	BASE	15"	34"	24"	BASE CABINET WITH DRAWER
F	BASE	18"	34"	24"	BASE CABINET WITH DRAWER
G	BASE	30"	34"	24"	BASE CABINET WITH DRAWER
Н	BASE	36"	34"	24"	BASE CABINET WITH DRAWER
J	BASE	15"	34"	24"	BOX-FILE-FILE

	AREA	FIN.	DESCRIPTION	AREA	FIN.	DESCRIPTION
	FLOOR	F1	RESILIENT TILE: 12"X12"	CEILING	C1	ACP: 24"X24"; MTL. SUSP. SYS. SS1
		F2	CARPET - ROLL GOODS WITH PAD			
		F3	VINYL PLANK FLOORING			
ARK						
	BASE	B1	RESILIENT BASE AS SPECIFIED: 4" COVE			
GGSHELL				_		
TO SPEC.				4		
	WALLS	W1	NOT USED			
MI-GLOSS				PAINT	P1	LATEX - "EGGSHELL" OR "SATIN"
TO SPEC.					P2	LATEX - "SEMI-GLOSS"
GGSHELL	GLASS	G-2	INTERIOR TEMPERED GLASS; 1/4" THICK		P3	LATEX — "FLAT"
TO SPEC.		G-6	LAMINATED SAFETY GLASS; 1/2" THICK		P4	ENAMEL - "SEMI-GLOSS"
		G-9	BULLET RESISTANT - REFER TO SPECS		P5	PREFINISHED: REFER TO SPECS.
					P6	EPOXY - "SEMI-GLOSS"
					P7	DRYFALL
LL COLOR						
			FINISH SCHEDU	JLE	RE	MARKS
			· · · · · · · · · · · · · · · · · · ·			

FINISH TYPES

1. PAINT WEST WALL AT NEW MECHANICAL CHASE TO MATCH EXISTING.

2. INSTALL NEW VINYL BASE AT MECHANICAL CHASE TO MATCH EXISTING AS REQUIRED.

3. INSTALL NEW ACOUSTICAL CEILING TILE AND GRID AT LOCATION OF MECHANICAL SHAFT AS REQUIRED TO

4. PAINT ONE WALL IN ROOM AN ACCENT COLOR TO BE DETERMINED.


DOOR SCHEDULE ABBREVIATIONS

DOC	OR / FRAME MATERIAL	STEEL DOOR GAGE			OD DOOR GRADE	WOOD DOOR VENEER CUTS		
AL	ALUMINUM	20	LEVEL 1 — STD. DUTY	Р	PREMIUM	PS	PLAIN SLICED	
STL	STEEL	18	LEVEL 2 - HEAVY DUTY	С	CUSTOM	QS	QUARTER SLICED	
WD	WOOD	16	LEVEL 3 – EXTRA HVY. DUTY	Ε	ECONOMY	RC	RIFT CUT	
SPECIAL DOOR TYPES			LEVEL 4 - MAXIMUM DUTY	WOOD DOOR CORE		R	ROTARY CUT	
AC	ACCORDION	STE	TEEL DOOR MODEL		HONEYCOMB			
AP	AP ACCESS PANEL		1 FULL FLUSH MB		MINERAL BOARD	WOC	D DOOR VENEER MATCHIN	
DK	DARKROOM REVOLVING	2	SEAMLESS	PC5	5-PLY PARTICLE BOARD	BK	BOOK MATCH	
HS	OVERHEAD HIGH-SPEED	3	STILE & RAIL	SC	SOUND-RATED	SL	SLIP MATCH	
OR	OVERHEAD ROLLING		STEEL DOOR CORE			RAN	RANDOM MATCH	
0S	OVERHEAD SECTIONAL	НС	HC HONEYCOMB		OD DOOR VENEER	Ε	END MATCH	
RV	REVOLVING	MB	MINERAL BOARD	BW	BIRCH - WHITE (SAPWOOD)	CON	CONTINUOUS MATCH	
SG	OVERHEAD SECURITY GRILLE	PS	POLYSTYRENE	НВ	PRIMED HARDBOARD	RUN	RUNNING MATCH	
DO	OR / FRAME FINISHES	PU	POLYURETHANE	HPDL	DECORATIVE LAMINATE		BALANCE MATCH	
Α	ANODIZED	SS	STEEL STIFFENERS	MW	MAPLE - WHITE (SAPWOOD)	CB	CENTER BALANCE MATO	
P_	PAINTED - SEE FIN. SCHED.			OR	RED OAK	P	PAIR MATCH	
S_	STAINED - SEE FIN. SCHED.			OW	WHITE OAK	S	SET MATCH	
				P0	POPLAR			
			_		_			

6.412 6.450 1.104		6.419
(12.365) (6.411)		2'-8"
6.450		2'-10"
_	0.651	(£ 461)


9.651 INTERIOR ELEVATION
SCALE: 1/4" = 1'-0"

5 INTERIOR ELEVATION
SCALE: 1/4" = 1'-0"

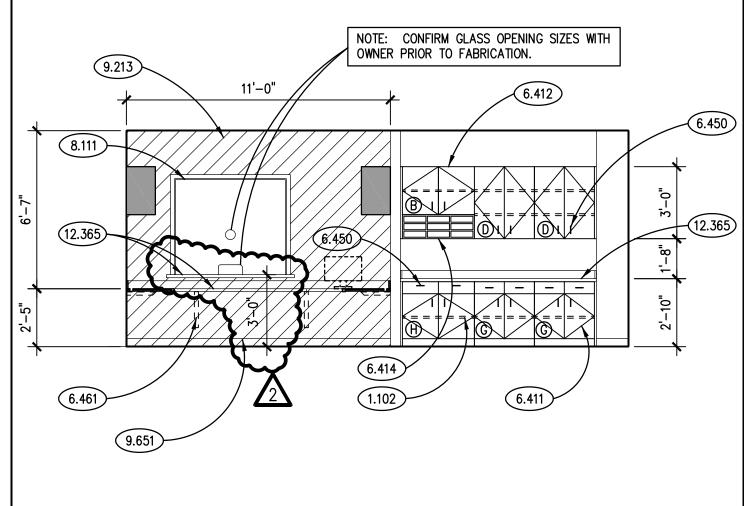

INTERIOR ELEVATION 4

SCALE: 1/4" = 1'-0"

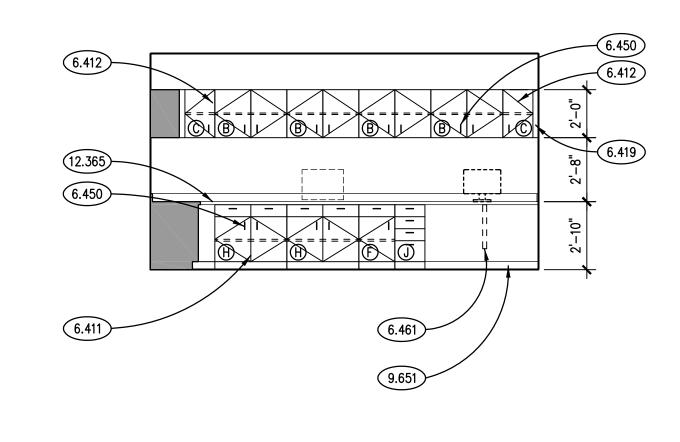

INTERIOR ELEVATION
SCALE: 1/4" = 1'-0"

INTERIOR ELEVATION
SCALE: 1/4" = 1'-0"

GENERAL CASEWORK NOTES

- ALL EXPOSED SURFACES AND SEMI-EXPOSED SURFACES SHALL BE COVERED IN HIGH-PRESSURE PLASTIC LAMINATE FINISH. INTERIORS OF CABINETS SHALL BE "WHITE" MELAMINE. SEE SPECIFICATIONS. PROVIDE
- PROVIDE FILLER PANELS TO MATCH ADJACENT CABINETS SCRIBBED TO WALL EDGES AS SHOWN, WIDTHS AS
- 3. FURNISH AND INSTALL GROMMETS IN COUNTERTOPS IN LOCATIONS AS PER OWNER. GROMMETS TO BE SELECTED BY OWNER.
- 4. ANCHOR COUNTERTOPS SECURELY TO BASE UNITS. COUNTERTOPS SHALL HAVE ROUNDED EDGES (¾" RADIUS) AND ROUNDED CORNERS (1 ½" RADIUS.)
- 5. PULLS FOR BASE CABINETS AND DRAWERS AS SPECIFIED.
- 6. LOCKS ARE REQUIRED FOR ALL CABINET DRAWERS AND DOORS. KEY ALIKE PER ROOM.
- 7. PROVIDING RESILIENT BASE AT ALL BASE CABINET TOE KICKS TO MATCH ADJACENT WALL BASE TYPICAL.
- 8. SEE SPECIFICATIONS FOR ADDITIONAL INFORMATION.
- 9. REFER TO FINISHES SCHEDULE ON FOR FINISH AND MATERIAL INFORMATION.

HARDWARE MOUNTING HEIGHTS

HARDWARE COMPONENT	PREFERRED MOUNTING HEIGHT FROM BOTTOM OF DOOR FRAME	ACCEPTABLE RANGE IF PREFERRED MOUNTING HEIGHT NOT POSSIBLE			
LOCKSETS, LATCHSETS	39" TO CENTERLINE OF LEVER	38" TO 42"			
EXIT DEVICES	39" TO CENTERLINE OF PUSH PAD	38" TO 42"			
DEADBOLT LOCKS	46" TO CENTERLINE OF CYLINDER	30" TO 48"			
PUSH PLATES	45" TO CENTERLINE OF PUSH PLATE	N/A			
PULLS, COMBINATION PUSH/PULL BARS	42" TO CENTERLINE OF PULL/BAR	N/A			
ROLLER LATCHES	45" TO CENTERLINE OF LATCH STRIKE	N/A			


GENERAL NOTES

- REFER TO A310 SERIES REFLECTED CEILING PLANS FOR CEILING HEIGHTS.
- 2. REFER TO ROOM FINISH SCHEDULE FOR SPECIFIC DOOR AND FRAME FINISHES AND GLAZING TYPES.
- 3. PROVIDE FRP FACED ALUMINUM DOORS IN ALUMINUM FRAMES.


CHECKED **APPROVED** SHEET TITLE DOOR, FRAME &

> HARDWARE SCHEDULES, ROOM FINISH SCHEDULE INTERIOR ELEVATIONS SHEET NUMBER

A800

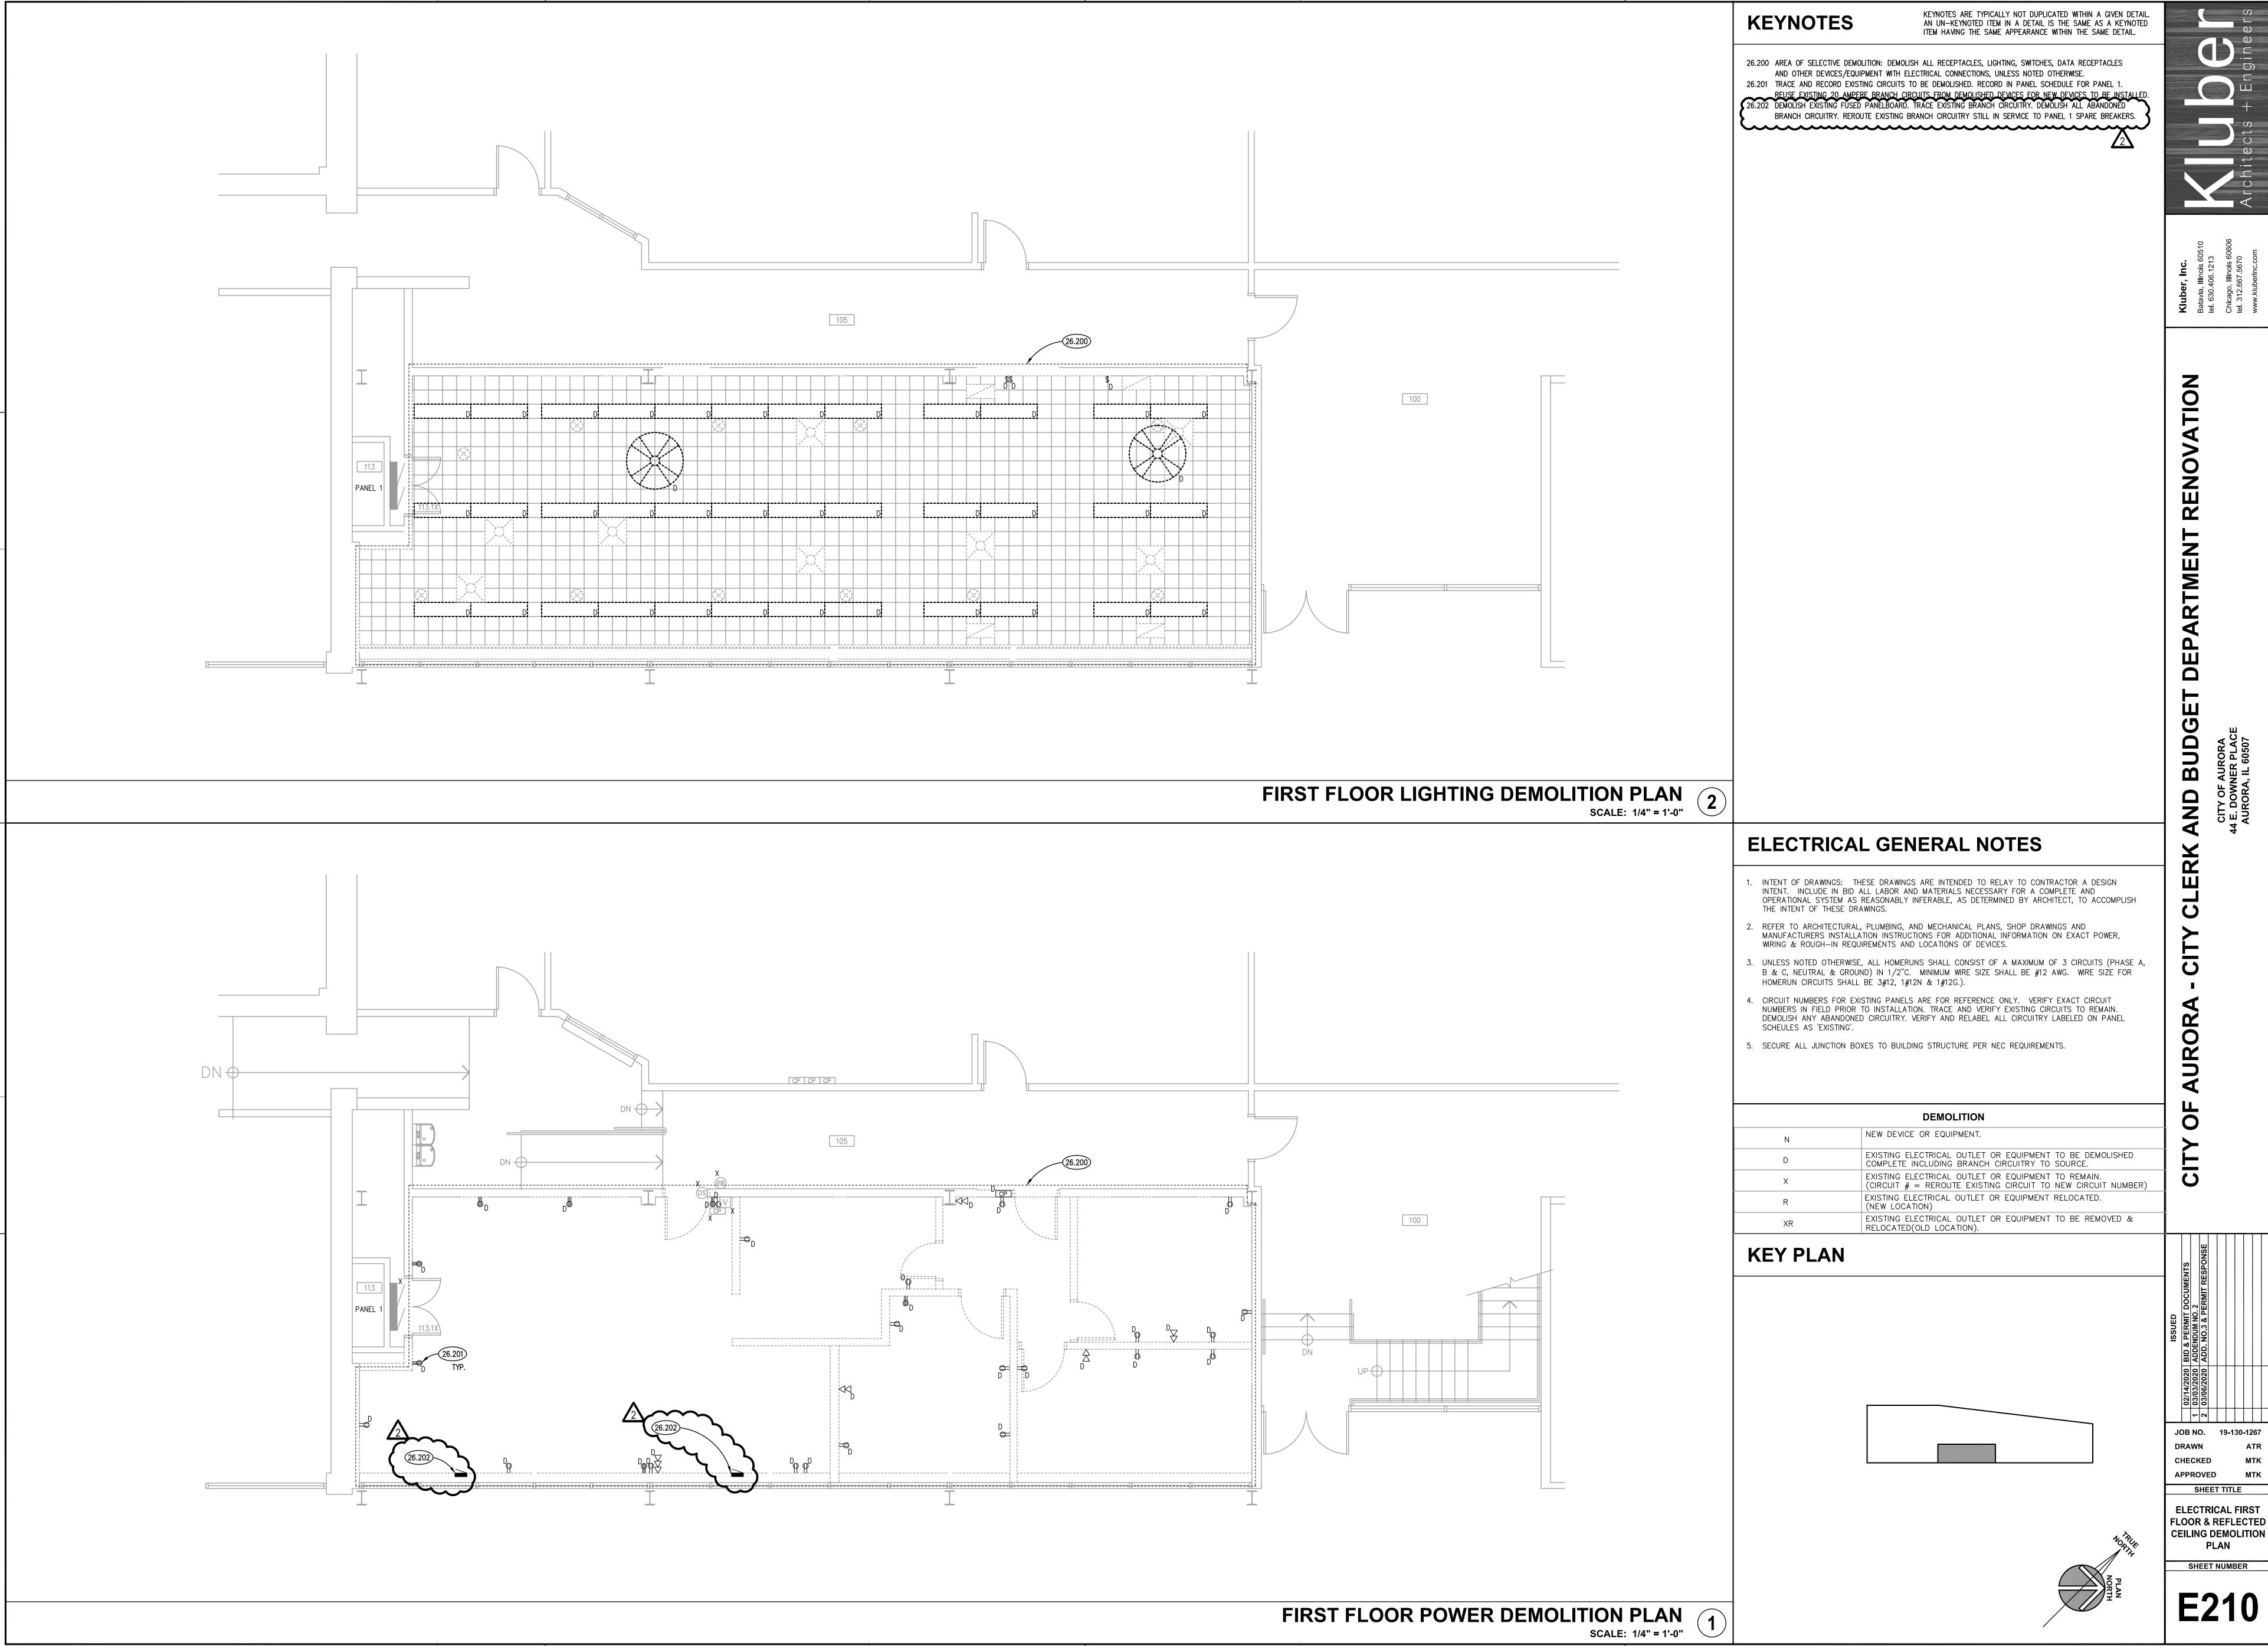

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KEYNOTES ARE TYPICALLY NOT DUPLICATED WITHIN A GIVEN DETAIL. AN UN-KEYNOTED ITEM IN A DETAIL IS THE SAME AS A KEYNOTED ITEM HAVING THE SAME APPEARANCE WITHIN THE SAME DETAIL.

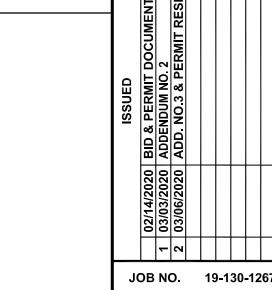26.300 HOMERUN NEW BRANCH CIRCUITRY TO EXISTING SPARE BREAKERS IN PANEL 1.

27.100 PROVIDE CONDUIT AND CABLING FOR DATA RECEPTACLES. HOMERUN CABLE TO SECOND FLOOR DATA CLOSET NORTH OF ROOM 202. DATA RECEPTACLES AND FINAL TERMINATIONS BY OWNER.

28.100 PROVIDE DURESS BUTTON AND HOMERUN TO EXISTING SECURITY PANEL LOCATED IN OFFICE ACROSS CORRIDOR 105. FOR BIDDING PURPOSES ONLY: ASSUME 22 AWG, 4 WIRE STRANDED CABLE. COORDINATE EXACT DEVICE AND WIRING REQUIREMENTS WITH OWNER'S SECURITY VENDOR PRIOR TO INSTALLATION. ALARM DETECTION SYSTEMS, INC. - (630)844-6302. SYSTEM # 80014254, ACCT # 9611.

......

BUD AND

ROOM NAME

117 | CLERK TRANSACTION COUNTER

118 WORK AREA

119 OPEN OFFICE

ELECTRICAL GENERAL NOTES

ROOM SCHEDULE

100 EXISTING LOBBY 105 EXISTING CORRIDOR

112 OFFICE
113 EXISTING ELECTRICAL ROOM

114 OFFICE - FINANCE DIRECTOR

110 CORRIDOR

111 FINANCE

115 FILES

116 CLERKS OFFICE

ROOM NAME

1. INTENT OF DRAWINGS: THESE DRAWINGS ARE INTENDED TO RELAY TO CONTRACTOR A DESIGN INTENT. INCLUDE IN BID ALL LABOR AND MATERIALS NECESSARY FOR A COMPLETE AND OPERATIONAL SYSTEM AS REASONABLY INFERABLE, AS DETERMINED BY ARCHITECT, TO ACCOMPLISH THE INTENT OF THESE DRAWINGS.

REFER TO ARCHITECTURAL, PLUMBING, AND MECHANICAL PLANS, SHOP DRAWINGS AND MANUFACTURERS INSTALLATION INSTRUCTIONS FOR ADDITIONAL INFORMATION ON EXACT POWER, WIRING & ROUGH-IN REQUIREMENTS AND LOCATIONS OF DEVICES.

3. UNLESS NOTED OTHERWISE, ALL HOMERUNS SHALL CONSIST OF A MAXIMUM OF 3 CIRCUITS (PHASE A, B & C, NEUTRAL & GROUND) IN 1/2"C. MINIMUM WIRE SIZE SHALL BE #12 AWG. WIRE SIZE FOR HOMERUN CIRCUITS SHALL BE 3#12, 1#12N & 1#12G.).

4. CIRCUIT NUMBERS FOR EXISTING PANELS ARE FOR REFERENCE ONLY. VERIFY EXACT CIRCUIT NUMBERS IN FIELD PRIOR TO INSTALLATION. TRACE AND VERIFY EXISTING CIRCUITS TO REMAIN. DEMOLISH ANY ABANDONED CIRCUITRY. VERIFY AND RELABEL ALL CIRCUITRY LABELED ON PANEL SCHEULES AS 'EXISTING'.


5. SECURE ALL JUNCTION BOXES TO BUILDING STRUCTURE PER NEC REQUIREMENTS.

KEY PLAN

SHEET TITLE

FIRST FLOOR **ELECTRICAL POWER** PLAN

E310

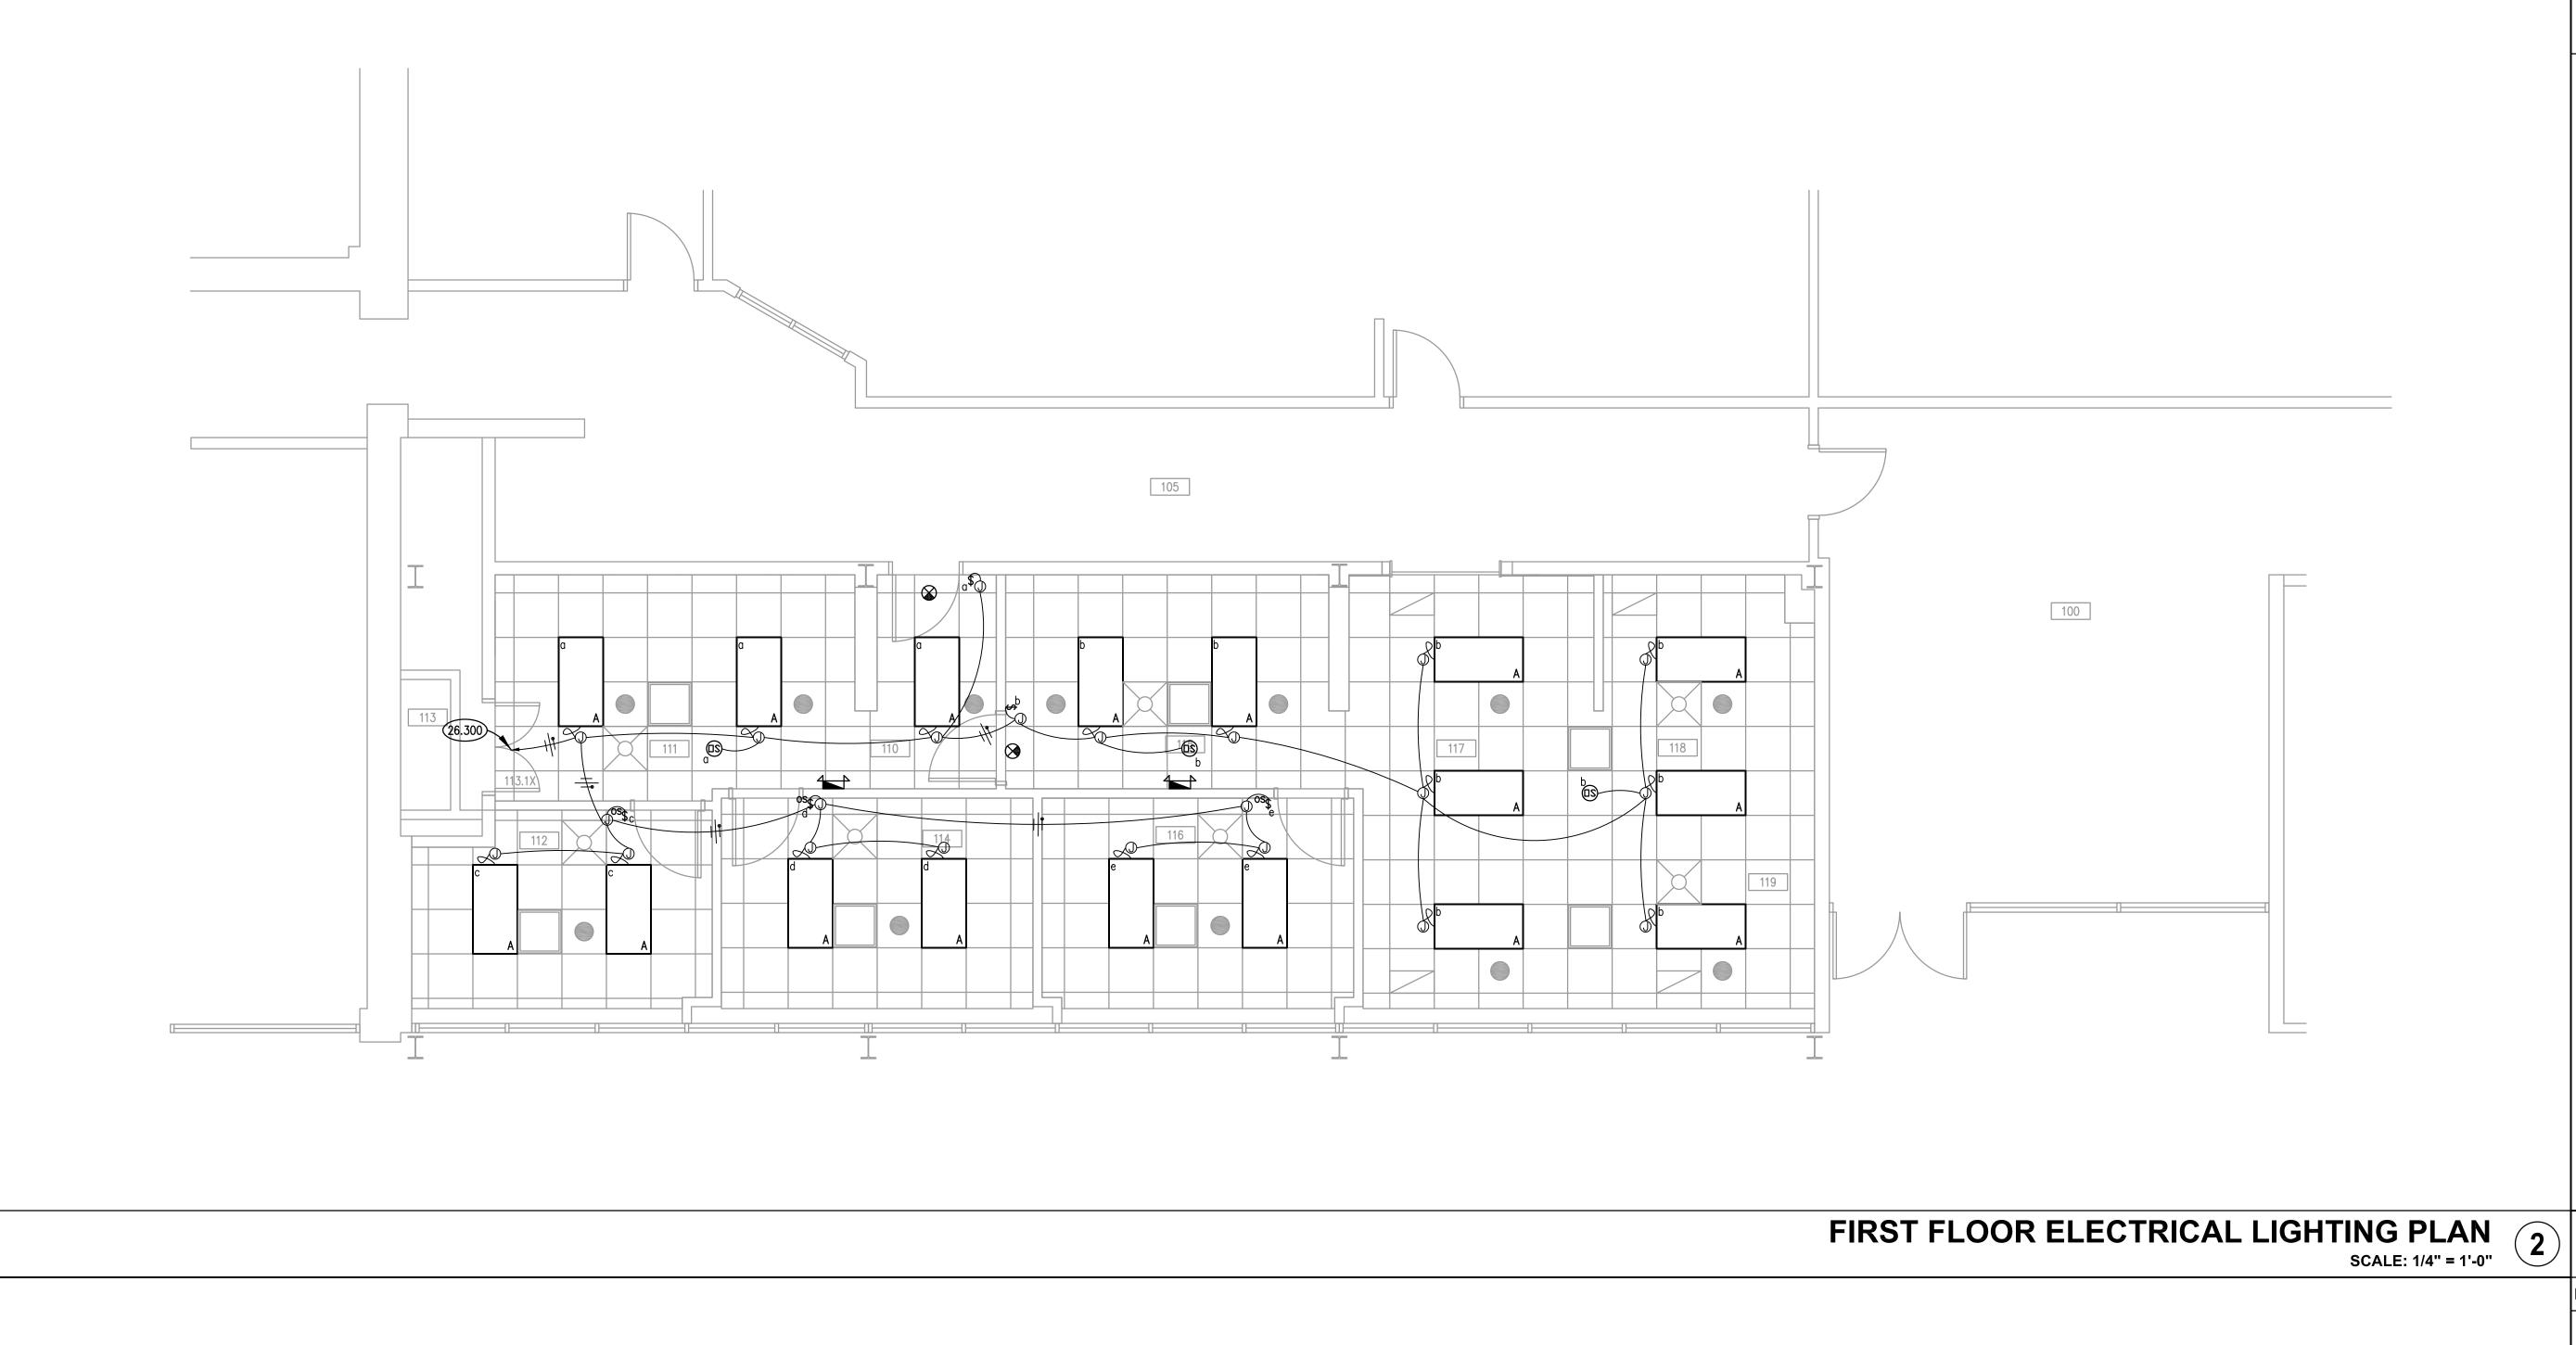

DN			28.100 CP I CP I CP	2			
	DN	DN DN X OS	TO EXIST. CARD ACCESS SYSTEM	27.100 TYP	HR TO EXIST. BUILDING SECURITY SYSTEM		W W
	VRF 02		VRF 04	VRF 06			
	113.1X TYP. 113.1X VRF 01	VRF 03	115.1 116 VRF 05	V V	VRF 119	DN	
		28.100			28.100		

FIRST FLOOR ELECTRICAL POWER PLAN
SCALE: 1/4" = 1'-0"