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	 8a PRECAST CONCRETE, 8x16 PATTERN, CHARCOAL 8b PRECAST CONCRETE, 8x16 PATTERN, CREAM 8c PRECAST PANEL WITH LINIER FORM LINER, CHARCOL 8d METAL SCREEN WITH DECORATIVE PATTERN 9 42" HIGH GUARDRAIL SYSTEM 	 16 PROJECT BUILDING SIGN 17 PARKING GARAGE SIGNAGE 18 OVERHEAD INSULATED G & SPEC' 19 PREF-FINISH ALUM. STOF INSULATED GLAZING





1 - HIGH-DENSITY FIBER CEMENT



2 - HIGH-DENSITY FIBER CEMENT





ELEVATIONS

1	
ND	20 CAST STONE SILL
	21 FIRE PROTECTION STROBE/HORN
STEPS	22 OVERFLOW ROOF DRAIN DISCHARGE
Take Louver - See Mech. Uver	23 STEEL BOLLARD - PAINT
	24 CAST STONE CAP
& Thermally broken frame - Hedule	25 OVERFLOW NOZZLE, PLUMBING DWG'S
G	26 LIGHT FIXTURE - SEE ELEC DWG'S
NAGE	27 PRE-FINISH ALUMINUM FLASHING
AGE	28 SIAMESE CONNECTION W/ ALARM & STROBE
GARAGE DOOR SEE SCHEDULE	29 PRECAST PANEL TO MATCH METAL CLADDING IN COLOR, AND JOINT LINE SIZE, SHAPE AND LOCATION.
DREFRONT SYSTEM W/	

	R	owHouse	s		Apartment	ts / Retail			
MATERIAL LIST	East:	North:	South:	North:	South:	West:	East:	(SF) TOTALS:	(%) TOTAL:
HIGH-DENSITY FIBER CEMENT - DARK	1,044	95	197			1,335	4,382	7,053	10.1%
HIGH-DENSITY FIBER CEMENT - LIGHT	845			1,966	2,392			5,203	7.4%
HIGH-DENSITY FIBER CEMENT - TEXTURED				1,780	2,498	3,763		8, 0 41	11.5%
WOOD LOOK - PHENOLIC OR ACM	573	127		1,591	2,193	97	1,216	5,797	8.3%
BRICK - CREAM				1,276	3,746	7,092		12,114	17.3%
BRICK- SMOKE GREY	1,878	431	493		1,765			4,567	6.5%
PRE-CAST CONC BRICK LOOK				1,511	1,176	676	647	4,010	5.7%
METAL PANEL - DARK GRAY				632	1,255	1,208		3,095	4.4%
PRE-CAST CONC TO MATCH METAL PANEL				147	125	45		317	0.5%
GLAZING	1,739	77	72	2,906	4,486	8,741	1,714	19,735	28.2%
TOTAL (SF)	6,079	730	762	11,809	19,636	22,957	7, <mark>9</mark> 59	69,932	100.0%



	<u>Value</u>	<u>Unit</u>
a) Building Height in feet (typical)	79.00	feet
b) Total Building Square Footage (typical)	304,408.00	Square Feet
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e) Exterior Material List (including colors) for all		
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MATERIAL TYPE	
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PRE-CAST (BRICK-LOOK)	5.7%
PRECAST (MTL PANEL LOOK)	0.5%
METAL PANEL	4.4%
PHENOLIC OR ACM PANEL (WOOD-LOOK)	8.3%
HIGH-DENSITY FIBER CEMENT PANEL	29.0%
GLAZING	28.2%
	100.0%

NOTES:

1. ALL ROOF DRAIN TO RUN INTERNALLY, NO EXTERIOR DOWNSPOUTS.

ALL SIGNAGE TO MEET THE AURORA SIGN ORDINANCE.



9500 BORMET DRIVE, SUITE #205 MOKENA, IL 60448 (815) 806-0146 www.rjaarchitects.com

JONATHAN R. MURAWSKI, AIA, NCARB IL LICENSE NUMBER: 001-022816

PROFESSIONAL DESIGN FIRM REGISTRATION: STATE OF ILLINOIS CORPORATE LICENSE #184-000167

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ZSW Architects

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NOT FOR CONSTRUCTION

-	PLANING AND ZONING REVIEW	04/25/2023
-	PLANING AND ZONING REVIEW	04/21/2023
-	PLANING AND ZONING REVIEW	03/23/2023
No.	ISSUES & REVISIONS	DATE

CLIENT PACIFICA RIVERVIEW DEVELOPMENT

NEW CONSTRUCTION

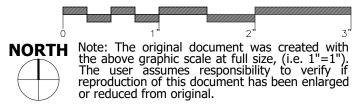
ADDRESS NORTH RIVER STREET AURORA, IL

EXTERIOR ELEVATIONS

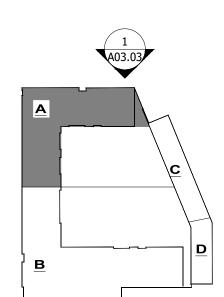
SHEET NUMBER

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GRAPHIC SCALE:



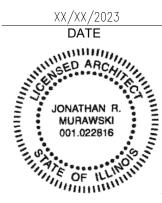
Project No.: 22068 A-10 Drawn By: NS Drawn By: NBC Checked By: JRM





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15 - PANEL: DUSTY CHARCOAL INTE: BUILDING DEPARTMENT These documents (plans & specifications) are valid for permits only when the architects original seal and signature appears and is affixed; and unless otherwise provided in writing, are intended as a permit submittal for one (1) building only. 2023 Robert Juris and Associates Architects,



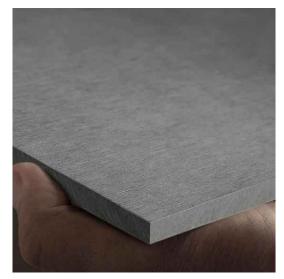
EXPIRES 11-30-2024



WEST EXTERIOR ELEVATION SCALE: 1/16" = 1'-0"



1 - HIGH-DENSITY FIBER CEMENT



2 - HIGH-DENSITY FIBER CEMENT



WOOD LOOK



ELEVATIONS

ID	20 CAST STONE SILL
	21 FIRE PROTECTION STROBE/HORN
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TOTAL (SF)	6,079	730	762	11,809	19,636	22 <mark>,</mark> 957	7,959	69,932	100.0%



Elevation Data Table: Elevations						
<u>Description</u>	<u>Value</u>	<u>Unit</u>				
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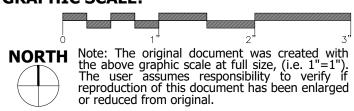
ADDRESS

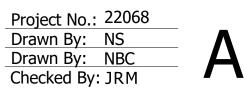
NORTH RIVER STREET AURORA, IL

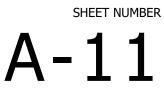
EXTERIOR ELEVATIONS

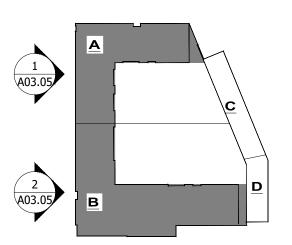
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GRAPHIC SCALE:











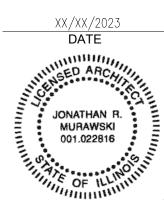
EL:21'-0"

EL:11'-0"

— EL:0'-0"



15 - PANEL: DUSTY CHARC DAL INTE: BUILDING DEPARTMENT These documents (plans & specifications) are valid for permits only when the architects original seal and signature appears and is affixed; and unless otherwise provided in writing, are intended as a permit submittal for one (1) building only. 2023 Robert Juris and Associates Architects,



EXPIRES 11-30-2024

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	9 42" HIGH GUARDRAIL SYSTEM	19 INSULATED GL







1 - HIGH-DENSITY FIBER CEMENT



2 - HIGH-DENSITY FIBER CEMENT



WOOD LOOK



ELEVATIONS

- STONE BAND TRY DOOR CONCRETE STEPS
- D HVAC INTAKE LOUVER SEE MECH. K GRAY LOUVER
- TAL DOOR & THERMALLY BROKEN FRAME -PEC'S & SCHEDULE
- L CLADDING
- ILDING SIGNAGE
- RAGE SIGNAGE
- NSULATED GARAGE DOOR SEE SCHEDULE
- ALUM. STOREFRONT SYSTEM W/

- 20 CAST STONE SILL
- 21 FIRE PROTECTION STROBE/HORN
- 22 OVERFLOW ROOF DRAIN DISCHARGE
- 23 STEEL BOLLARD PAINT
- 24 CAST STONE CAP25 OVERFLOW NOZZLE, PLUMBING DWG'S
- 26 LIGHT FIXTURE SEE ELEC DWG'S
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- 29 PRECAST PANEL TO MATCH METAL CLADDING IN COLOR, AND JOINT LINE SIZE, SHAPE AND LOCATION.

	RowHouses			Apartments / Retail					
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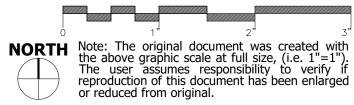
ADDRESS

NORTH RIVER STREET AURORA, IL

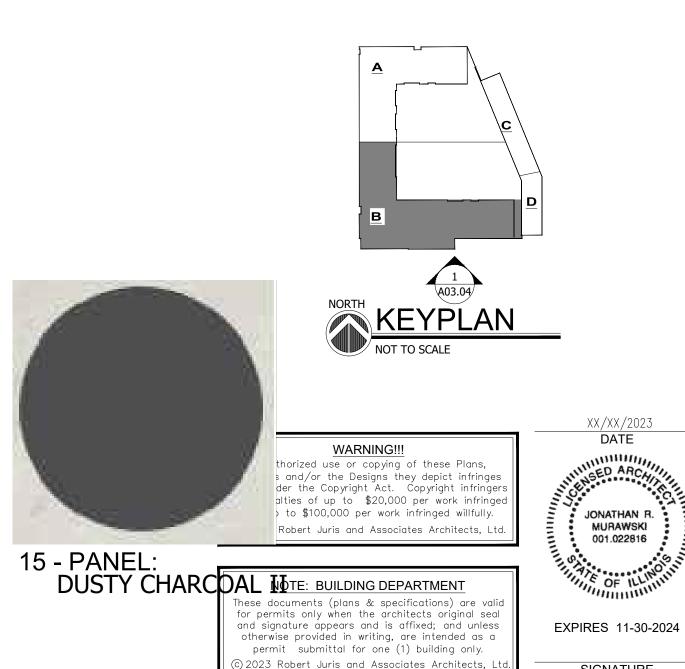
EXTERIOR ELEVATIONS

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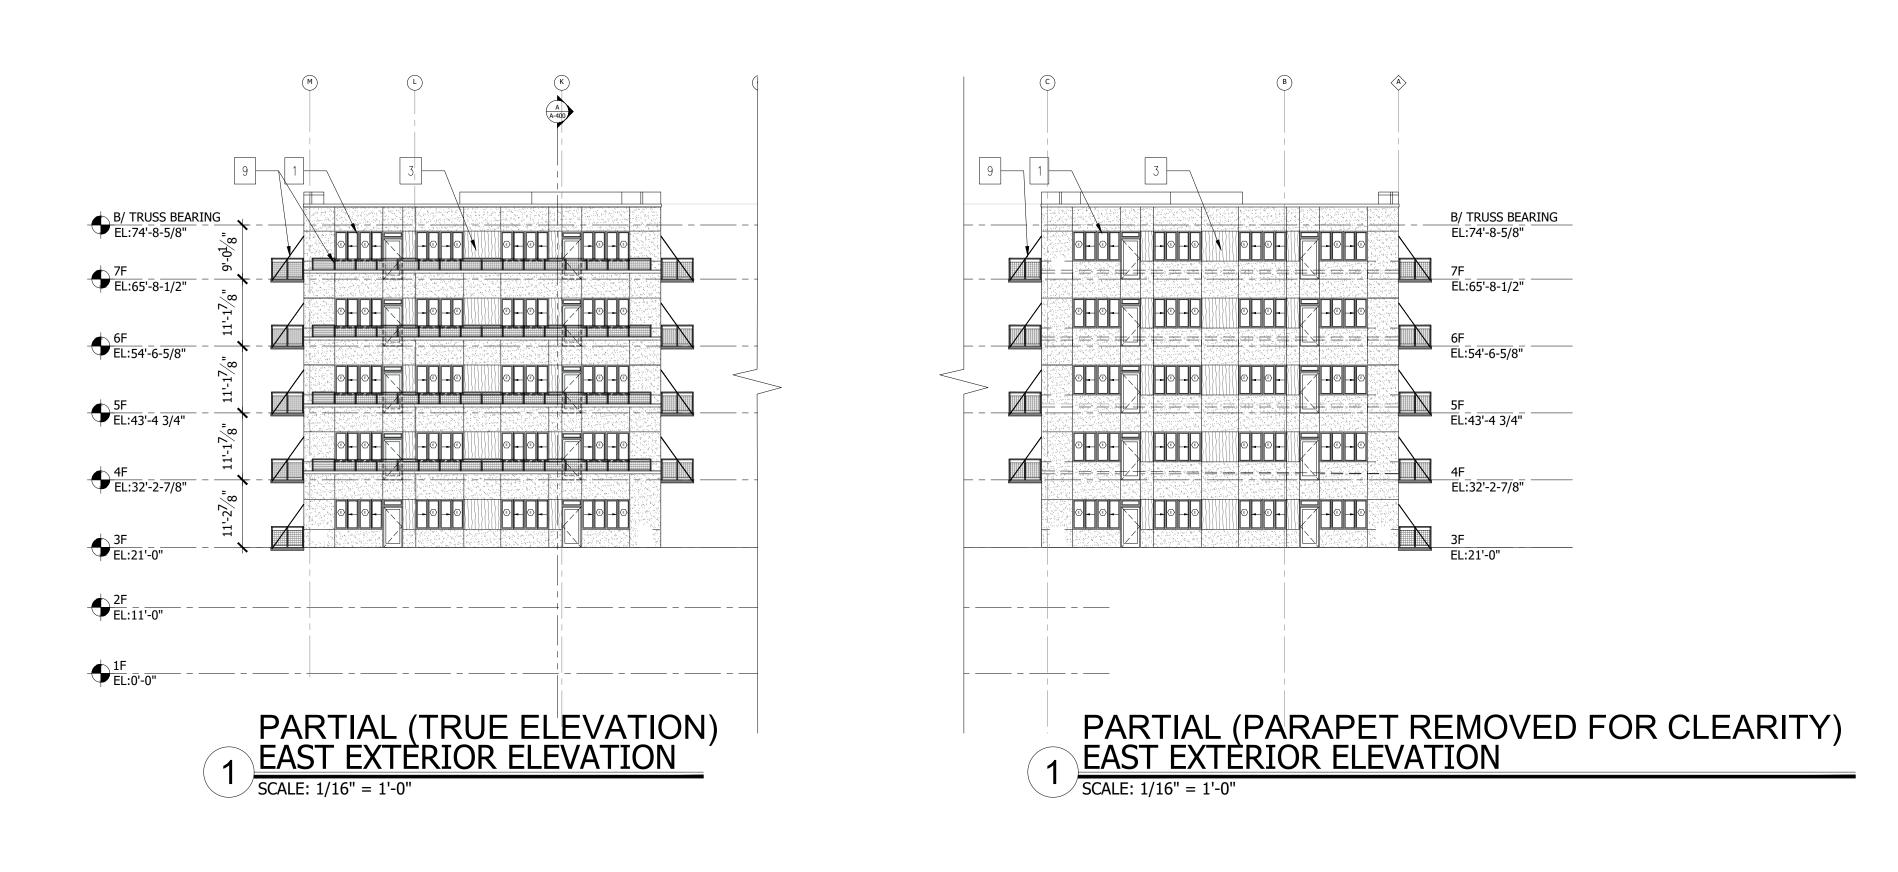
GRAPHIC SCALE:







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1 - HIGH-DENSITY FIBER CEMENT



3 - PANEL: WOOD LOOK

ELEVATIONS

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Elevation Data Table: Elevations				
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a) Building Height in feet (typical)	79.00	feet		
b) Total Building Square Footage (typical)	304,408.00	Square Feet		
c) First Floor Building Square Footage (typical)	71,890.00	Square Feet		
d) Number of building stories (typical)	7.00	Square Feet		
e) Exterior Material List (including colors) for all				
High-density fiber cement - dark gray, High- density fiber cement - light gray, High-density fiber cement - textured gray, Phenolic or ACM Panel - wood bok, Brick - cream, Brick - smoke gray, Metal Panel - dark gray, Pre-Cast Conc 8x16 masonry - cream cobr				

MATERIAL TYPE	
MASONRY (INCLUDING BRICK LOOK PRE-CAST)	23.9%
PRE-CAST (BRICK-LOOK)	5.7%
PRECAST (MTL PANEL LOOK)	0.5%
METAL PANEL	4.4%
PHENOLIC OR ACM PANEL (WOOD-LOOK)	8.3%
HIGH-DENSITY FIBER CEMENT PANEL	29.0%
GLAZING	28.2%
	100.0%

NOTES:

1. ALL ROOF DRAIN TO RUN INTERNALLY, NO EXTERIOR DOWNSPOUTS.

2. ALL SIGNAGE TO MEET THE AURORA SIGN ORDINANCE.



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ZSW Architects

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-	PLANING AND ZONING REVIEW	04/21/2023
-	PLANING AND ZONING REVIEW	03/23/2023
No.	ISSUES & REVISIONS	DATE

CLIENT PACIFICA RIVERVIEW DEVELOPMENT PROJECT

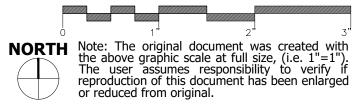
NEW CONSTRUCTION

NORTH RIVER STREET AURORA, IL

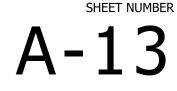
EXTERIOR ELEVATIONS

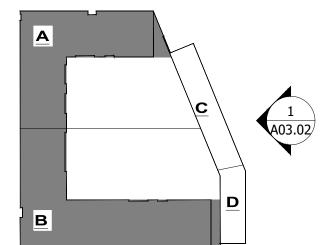
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Project No.: 22068 Drawn By: NS Drawn By: NBC Checked By: JRM



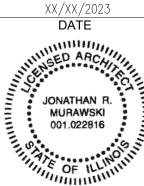






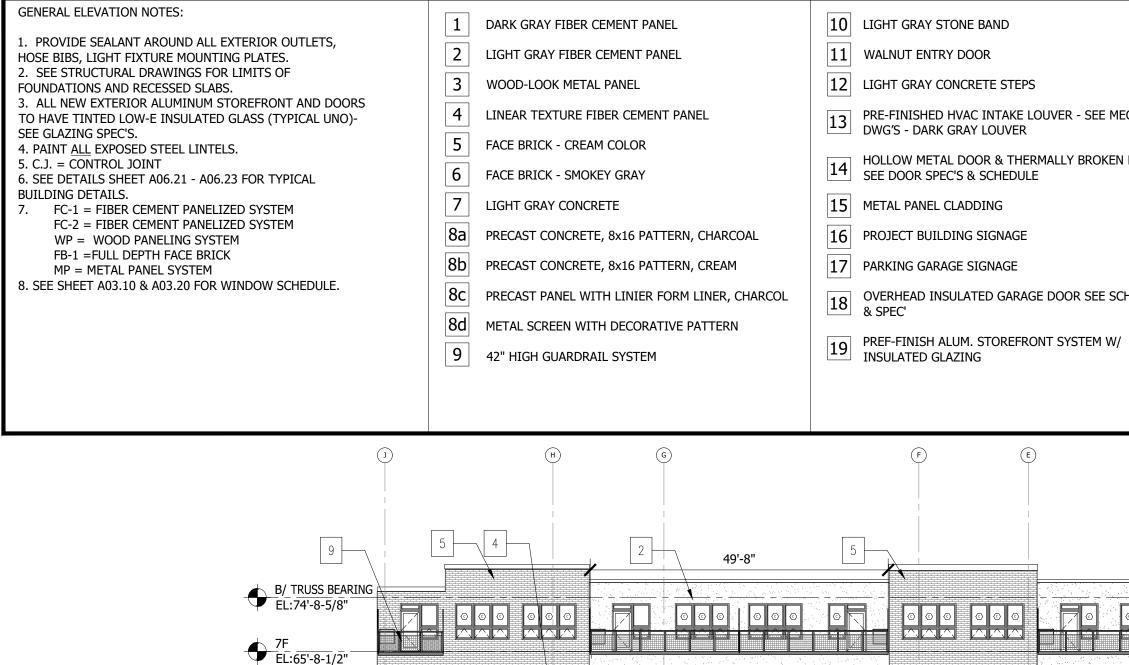
NOTE: BUILDING DEPARTMENT

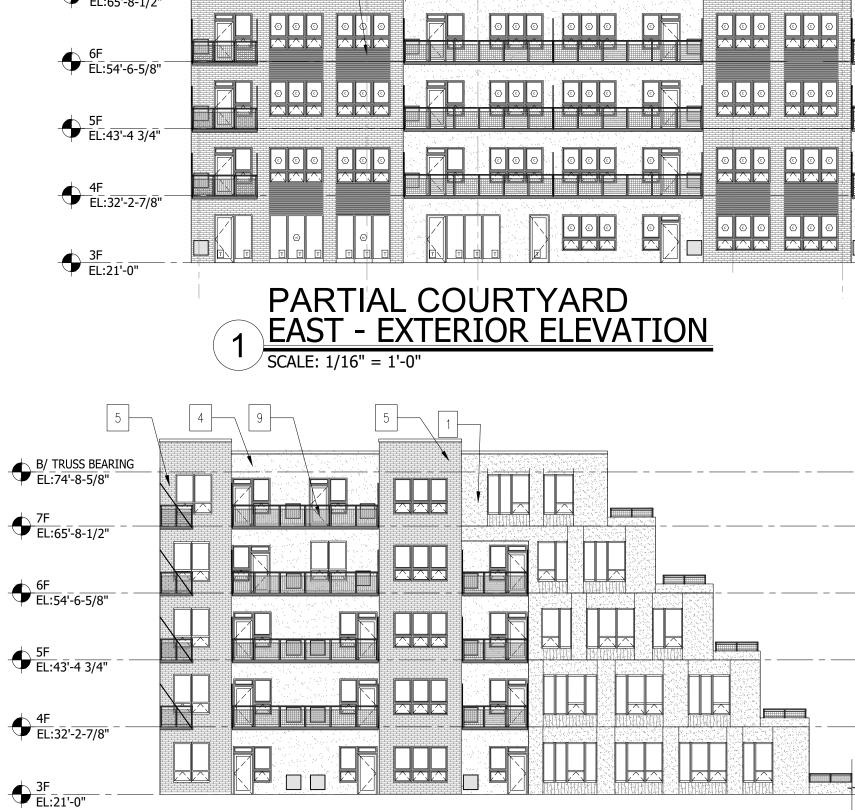
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PARTIAL COURTYARD SOUTH - EXTERIOR ELEVATION SCALE: 1/16" = 1'-0"



1 - HIGH-DENSITY FIBER CEMENT



2 - HIGH-DENSITY FIBER CEMENT



3 - PANEL: WOOD LOOK

ELEVATIONS

ND	20 CAST STONE SILL
	21 FIRE PROTECTION STROBE/HORN
E STEPS	22 OVERFLOW ROOF DRAIN DISCHARGE
ITAKE LOUVER - SEE MECH. DUVER	23 STEEL BOLLARD - PAINT
	24 CAST STONE CAP
& Thermally broken frame - Hedule	25 OVERFLOW NOZZLE, PLUMBING DWG'S
G	26 LIGHT FIXTURE - SEE ELEC DWG'S
GNAGE	27 PRE-FINISH ALUMINUM FLASHING
IAGE	28 SIAMESE CONNECTION W/ ALARM & STROBE
GARAGE DOOR SEE SCHEDULE	29 PRECAST PANEL TO MATCH METAL CLADDING IN COLOR, AND JOINT LINE SIZE, SHAPE AND LOCATION.
OREFRONT SYSTEM W/	

	Ro	owHouse	s	Apartments / Retail					
MATERIAL LIST	East:	North:	South:	North:	South:	West:	East:	(SF) TOTALS:	(%) TOTAL:
HIGH-DENSITY FIBER CEMENT - DARK	1,044	95	197			1,335	4,382	7,053	10.1%
HIGH-DENSITY FIBER CEMENT - LIGHT	8 4 5			1,966	2,392			5,203	7.4%
HIGH-DENSITY FIBER CEMENT - TEXTURED				1,780	2,498	3,763		8,041	11.5%
WOOD LOOK - PHENOLIC OR ACM	573	127		1,591	2,193	97	1,216	5,797	8.3%
BRICK - CREAM				1,276	3,746	7,092		12,114	17.3%
BRICK- SMOKE GREY	1,878	431	493		1,765			4,567	6.5%
PRE-CAST CONC BRICK LOOK				1,511	1,176	676	<mark>64</mark> 7	4,010	5.7%
METAL PANEL - DARK GRAY				632	1,255	1,208		3,095	4.4%
PRE-CAST CONC TO MATCH METAL PANEL				147	125	45		317	0.5%
GLAZING	1,739	77	72	2,906	4,486	8,741	1,714	19,735	28.2%
TOTAL (SF)	6,079	730	762	11,809	19,636	22,957	7,959	69,932	100.0%

E			С
	· · · · · · · · · · · · · · · · · · ·	26'-4"	/



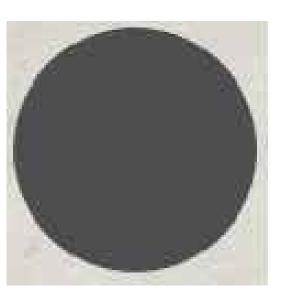




4 - HIGH-DENSITY FIBER CEMENT



5 - BRICK: CREAM COLOR



15 - PANEL: DUSTY CHARCOAL II

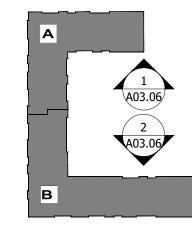
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MATERIAL TYPE	
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PRECAST (MTL PANEL LOOK)	0.5%
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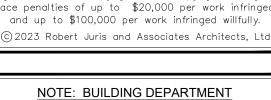






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-	PLANING AND ZONING REVIEW	04/21/2023
-	PLANING AND ZONING REVIEW	03/23/2023
No.	ISSUES & REVISIONS	DATE

PACIFICA RIVERVIEW DEVELOPMENT

NEW CONSTRUCTION

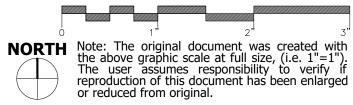
ADDRESS **NORTH RIVER STREET** AURORA, IL

EXTERIOR ELEVATIONS

SHEET NUMBER

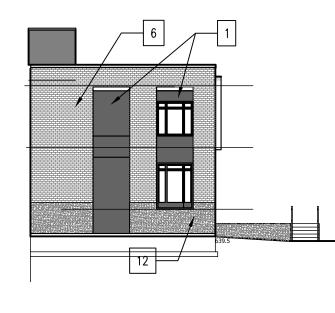
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GRAPHIC SCALE:



Project No.: 22068 Drawn By: NS A-14 Drawn By: NBC Checked By: JRM

GENERAL ELEVATION NOTES:				
GENERAL LEEVATION NOTES.	1	DARK GRAY FIBER CEMENT PANEL	10	LIGHT GRAY STONE B
1. PROVIDE SEALANT AROUND ALL EXTERIOR OUTLETS, HOSE BIBS, LIGHT FIXTURE MOUNTING PLATES.	2	LIGHT GRAY FIBER CEMENT PANEL	11	WALNUT ENTRY DOOI
2. SEE STRUCTURAL DRAWINGS FOR LIMITS OF FOUNDATIONS AND RECESSED SLABS.	3	WOOD-LOOK METAL PANEL	12	LIGHT GRAY CONCRET
 ALL NEW EXTERIOR ALUMINUM STOREFRONT AND DOORS TO HAVE TINTED LOW-E INSULATED GLASS (TYPICAL UNO)- SEE GLAZING SPEC'S. 	4	LINEAR TEXTURE FIBER CEMENT PANEL	13	PRE-FINISHED HVAC I DWG'S - DARK GRAY L
4. PAINT ALL EXPOSED STEEL LINTELS.	5	FACE BRICK - CREAM COLOR		HOLLOW METAL DOOI
5. C.J. = CONTROL JOINT 6. SEE DETAILS SHEET A06.21 - A06.23 FOR TYPICAL	6	FACE BRICK - SMOKEY GRAY	14	SEE DOOR SPEC'S & S
BUILDING DETAILS. 7. FC-1 = FIBER CEMENT PANELIZED SYSTEM	7	LIGHT GRAY CONCRETE	15	METAL PANEL CLADD
FC-2 = FIBER CEMENT PANELIZED SYSTEM WP = WOOD PANELING SYSTEM	8a	PRECAST CONCRETE, 8x16 PATTERN, CHARCOAL	16	PROJECT BUILDING S
FB-1 =FULL DEPTH FACE BRICK MP = METAL PANEL SYSTEM	8b	PRECAST CONCRETE, 8x16 PATTERN, CREAM	17	PARKING GARAGE SIG
8. SEE SHEET A03.10 & A03.20 FOR WINDOW SCHEDULE.	8c	PRECAST PANEL WITH LINIER FORM LINER, CHARCOL	18	
	8d	METAL SCREEN WITH DECORATIVE PATTERN		& SPEC'
	9	42" HIGH GUARDRAIL SYSTEM	19	PREF-FINISH ALUM. S INSULATED GLAZING













2 - HIGH-DENSITY FIBER CEMENT

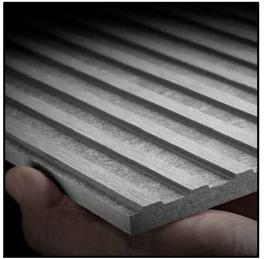


3 - PANEL:

ELEVATIONS

BAND	20 CAST STONE SILL
DR	21 FIRE PROTECTION STROBE/HORN
ETE STEPS	22 OVERFLOW ROOF DRAIN DISCHARGE
INTAKE LOUVER - SEE MECH.	23 STEEL BOLLARD - PAINT
	24 CAST STONE CAP
DR & THERMALLY BROKEN FRAME - SCHEDULE	25 OVERFLOW NOZZLE, PLUMBING DWG'S
DING	26 LIGHT FIXTURE - SEE ELEC DWG'S
SIGNAGE	27 PRE-FINISH ALUMINUM FLASHING
GNAGE	28 SIAMESE CONNECTION W/ ALARM & STROBE
ED GARAGE DOOR SEE SCHEDULE	29 PRECAST PANEL TO MATCH METAL CLADDING IN COLOF AND JOINT LINE SIZE, SHAPE AND LOCATION.
STOREFRONT SYSTEM W/	

	Ro	owHouse	s	Apartments / Retail					
MATERIAL LIST	East:	North:	South:	North:	South:	West:	East:	(SF) TOTALS:	(%) TOTAL:
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HIGH-DENSITY FIBER CEMENT - LIGHT	845			1,966	2,392			5,203	7.4%
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BRICK - CREAM				1,276	3,746	7,092		12,114	17.3%
BRICK- SMOKE GREY	1,878	431	493		1,765			4,567	6.5%
PRE-CAST CONC BRICK LOOK				1, <mark>51</mark> 1	1,176	676	647	4,010	5.7%
METAL PANEL - DARK GRAY				632	1,255	1,208		3,095	4.4%
PRE-CAST CONC TO MATCH METAL PANEL				147	125	45		317	0.5%
GLAZING	1,739	77	72	2,906	4,486	8,741	1,714	19,735	28.2%
TOTAL (SF)	6,079	730	762	11,809	19,636	22,957	7,959	69,932	100.0%



L: 4 - HIGH-DENSITY WOOD LOOK FIBER CEMENT



6 - BRICK SMOKEY GRAY



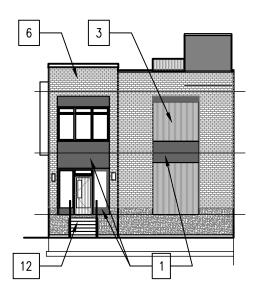
9 - RETAINING WALL W/ GAURDRAIL

Elevation Data Table: Elevations						
Description	<u>Value</u>	<u>Unit</u>				
a) Building Height in feet (typical)	79.00	feet				
b) Total Building Square Footage (typical)	304,408.00	Square Feet				
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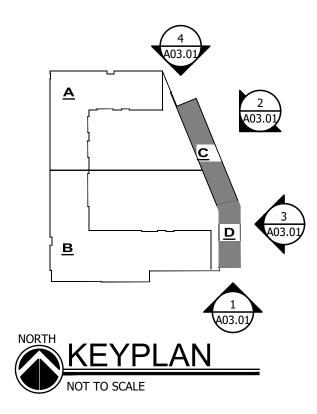
MATERIAL TYPE	
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DOWNSPOUTS. ALL SIGNAGE TO MEET THE AURORA SIGN ORDINANCE.

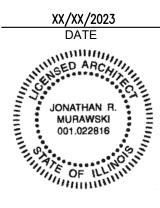






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CLIENT PACIFICA RIVERVIEW DEVELOPMENT

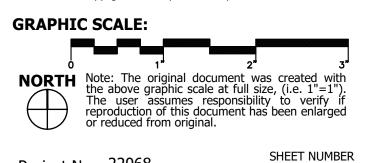
NEW CONSTRUCTION

PROJECT

ADDRESS NORTH RIVER STREET AURORA, IL

EXTERIOR ELEVATIONS

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2 NORTH ELEVATION

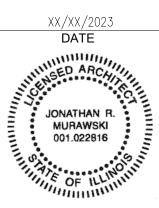
ELEVATIONS

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CLIENT PACIFICA RIVERVIEW DEVELOPMENT PROJECT

NEW CONSTRUCTION

ADDRESS

SHEET NUMBER

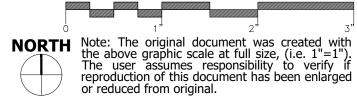
-16

NORTH RIVER STREET AURORA, IL

EXTERIOR ELEVATIONS

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GRAPHIC SCALE:



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EAST ELEVATION





ELEVATIONS



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ADDRESS

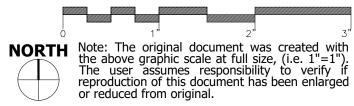
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NORTH RIVER STREET AURORA, IL

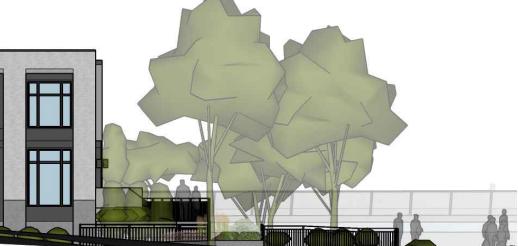
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GRAPHIC SCALE:





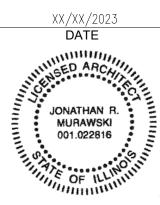




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