

LOCATION MAP

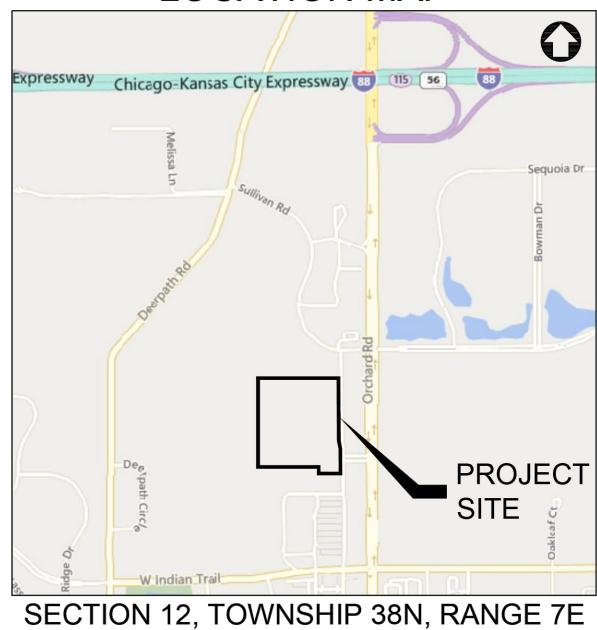

Landscape Plan The Springs at Aurora Subdivision

Landscape Implementation Data Table: Plant List by Category							
				BOTANICAL NAME (Family /			
_	QTY	Percent	<u>SYM</u>	Genus / Species)	COMMON NAME	SIZE	COMMENTS
Canopy Trees	18	8%	AEG	Aesculus glabra	Ohio Buckeye	2.5" cal.	
	6	3%	AFA	Acer x freemanii 'Autumn Blaze'	Autumn Blaze Freeman	2.5" cal.	
	8	3%	AMM	Acer miyabei 'Morton'	State Street Miyabe's m	2.5" cal.	
	8	3%	ARF	Acer rubrum 'Frank Jr.'	Redpointe Red Maple	2.5" cal.	
	16	7%	BPW	Betula populifolia 'Whitespire'	Whitespire Gray Birch	2.5" cal.	
	19	8%	CEO	Celtis occidentalis	Common Hackberry	2.5" cal.	
	14	6%	GBA	Ginkgo biloba 'Autumn Gold'	Autmumn Gold Ginkgo	2.5" cal.	
	16	7%	GBP	Ginkgo biloba 'Princeton Sentry'	Princeton Sentry Maider	2.5" cal.	
	19	8%	GDE	Gymnocladus dioicus 'Espresso'	Espresso Kentucky Coffe	2.5" cal.	
	10	4%	GTS	Gleditsia triacanthos 'Shademaste	Shademaster Honeylocu	2.5" cal.	
	8	3%	LIT	Liriodendron tulipifera	Tulip Tree	2.5" cal.	
	13	6%	NYS	Nyssa sylvatica	Black Tupelo	2.5" cal.	
	11	5%	QRR	Quercus robur Regal Prince	Regal Prince English Oak	2.5" cal.	
	10	4%	QUB	Quercus bicolor	Swamp White Oak	2.5" cal.	
	9	4%	QUR	Quercus rubra	Red Oak	2.5" cal.	
	14	6%	TAM	Tilia americana 'MckSentry'	American Sentry Linden	2.5" cal.	
	13	6%	TCG	Tilia cordata 'Greenspire'	Greenspire Littleleaf Lin		
	13	6%	ULA	Ulmus davidiana var. japonica 'Mo	Accolade Elm	2.5" cal.	
	10	4%	ULH	Ulmus 'Heritage'	Heritage Elm	2.5" cal.	
Total:	235						
Evergreen Trees	13		ACO	Abies concolor	White Fir	6' ht.	
	16			Picea glauca 'Densata'	Black Hills Spruce	6' ht.	
	15			Picea pungens	Green Spruce	6' ht.	
	13			Pinus strobus	Eastern White Pine	6' ht.	
Total:	57						
Understory Trees	12		AMG	Amelanchier x grandiflora.	Shadblow Serviceberry	8' ht.	
•	7		COF	Cornus florida	White Flowering Dogwo		
	3		COM	Cornus mas	Corneliancherry Dogwoo		
	6		MAP	Malus x. 'Prairifire'	Prairifire Flowering Crab		
	10		A CONTRACTOR OF THE CONTRACTOR	Syringa reticulata 'Ivory silk'	Ivory Silk Tree Lilac	8' ht.	
	5	5%	VIP	Viburnum prunifolium	Blackhaw Viburnum	8' ht.	
Total:	43	100%					
Deciduous Shrubs	47	2%	AAB	Aronia arbutifolia 'Brilliantissima'	Brilliant Red Chokeberry	24" ht.	
	92	4%	AMA	Aronia melanocarpa	Black Chokeberry	24" ht.	
	99	4%	BUD	Buddleia 'Pugster Blue'	Pugster Blue Butterfly B	24" ht.	
	88		CAM	Cornus alba 'Elegantissima'	Variegated Dogwood	24" ht.	
	100		CEA	Ceanothus americanus	New Jersey Tea	24" ht.	
	96		CEP	Cephalanthus occidentalis	Buttonbush	24" ht.	
	107		CSF	Cornus stolonifera 'Farrow'	Arctic Fire Redtwig Dogv		
	89		CLA	Clethra alnifolia 'Hummingbird'	Hummingbird Summers		
	69		DKO	Diervilla Kodiak Orange	Orange Kodiak Honeysu		
	55		FOS	Forsythia x 'sunrise'	Sunrise Forsythia	24" ht.	
	136		FVB	Forsythia viridissima 'bronxensis'	•		
	74		HYA	Hydrangea arborescens 'Annabell	4.5	24" ht.	
	57		HYB	Hydrangea macrophylla 'PIIHM-II'			
	64		HYP	Hydrangea paniculata 'Peegee Im			
	34			Hydrangea quercifolia 'Alice'	Alice Oakleaf Hydrangea	The second second	
	72		POB		Diabolo Ninebark	24" ht.	
<u> </u>	166		RAG	Rhus aromatica 'Gro-Low'	Gro-Low Fragrant Suma		
	142			Spirea betulafolia 'tor'	Tor Birchleaf Spirea	18" w.	
	155		SPB	Spiraea x. bumalda 'Anthony Wate			
	126		STC	Stephanandra incisa 'Crispa'	Cutleaf Stephanandra	18" w.	
	130			Syringa patula 'Miss Kim'	·	24" ht.	
	129		VCC	Viburnum carlesii 'Cayuga'	Cayuga Koreanspice Vib		
	73		VDC	Viburnum cariesii Cayuga Viburnum dentatum 'Chicago Lust			
	74						
Total	*		VNB	Viburnum nudum 'Bulk'	Brandywine Smooth Wit	24 Mt.	
Total:	2274		DI IVA/	Diving malaries as Divining BACL	\\\\\\\\\\\\\\\\\\\\\\\\\\\\\\\\\\\\\\	10"	
Evergreen Shrubs	131		BUW	Buxus micro. x. B. sem. 'Wilson's (
	97		JCK	Juniperus chin. Pfitz. 'Kallay's Com			
		18%	JCS	Juniperus chinensis 'Sea Green'	Sea Green Juniper	18" ht.	
	34		TME	Taxus x media 'Everlow'	Everlow Dense Yew	18" w.	

LANDSCAPE DATA TABLE: PLANTING MATERIALS KEY

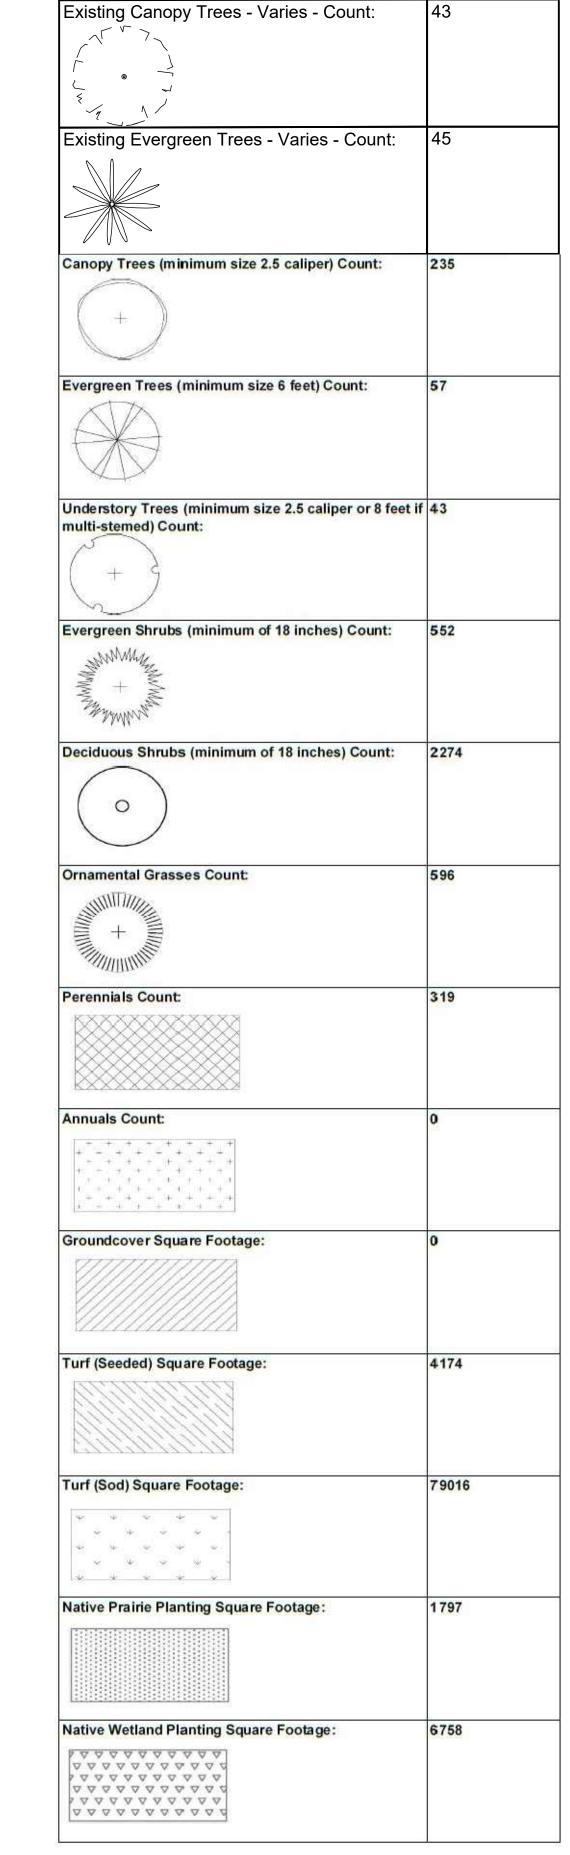

Landscap	oe Data Table	CTEs Provided	k
	CTE Value	Count Provided	Total CTEs
			<u>Provided</u>
Canopy Trees	1	235	235
Evergreen Trees	1/3	57	19
Understory Trees	1/3	43	14
Deciduous Shrubs	1/20	2274	114
Evergreen Shrubs	1/20	552	28
-	Total:	3161	410

1955 N. Wilmot Ave Chicago, IL 60647 ph. 773.697.4388 www.LGWLA.com



PROJECT TEAM

CIVIL ENGINEER:



DEVELOPER / OWNER INFORMATION E-MAIL(If Any): jpatton@cproperties.com

PROJECT NAME

LANDSCAPE PLAN SPRINGS AT AURORA

1380 & 1444 N. Orchard Rd, Aurora, Il 60506

DRAWING ISSUED

06/06/25

 For Approval 2. Per City Comments 07/10/25


SET TYPE

LANDSCAPE PLANS

PROJECT NUMBER 2408046

08-23-2025 DRAWN BY: APPROVED BY:

SHEET TITLE LANDSCAPE TITLE SHEET

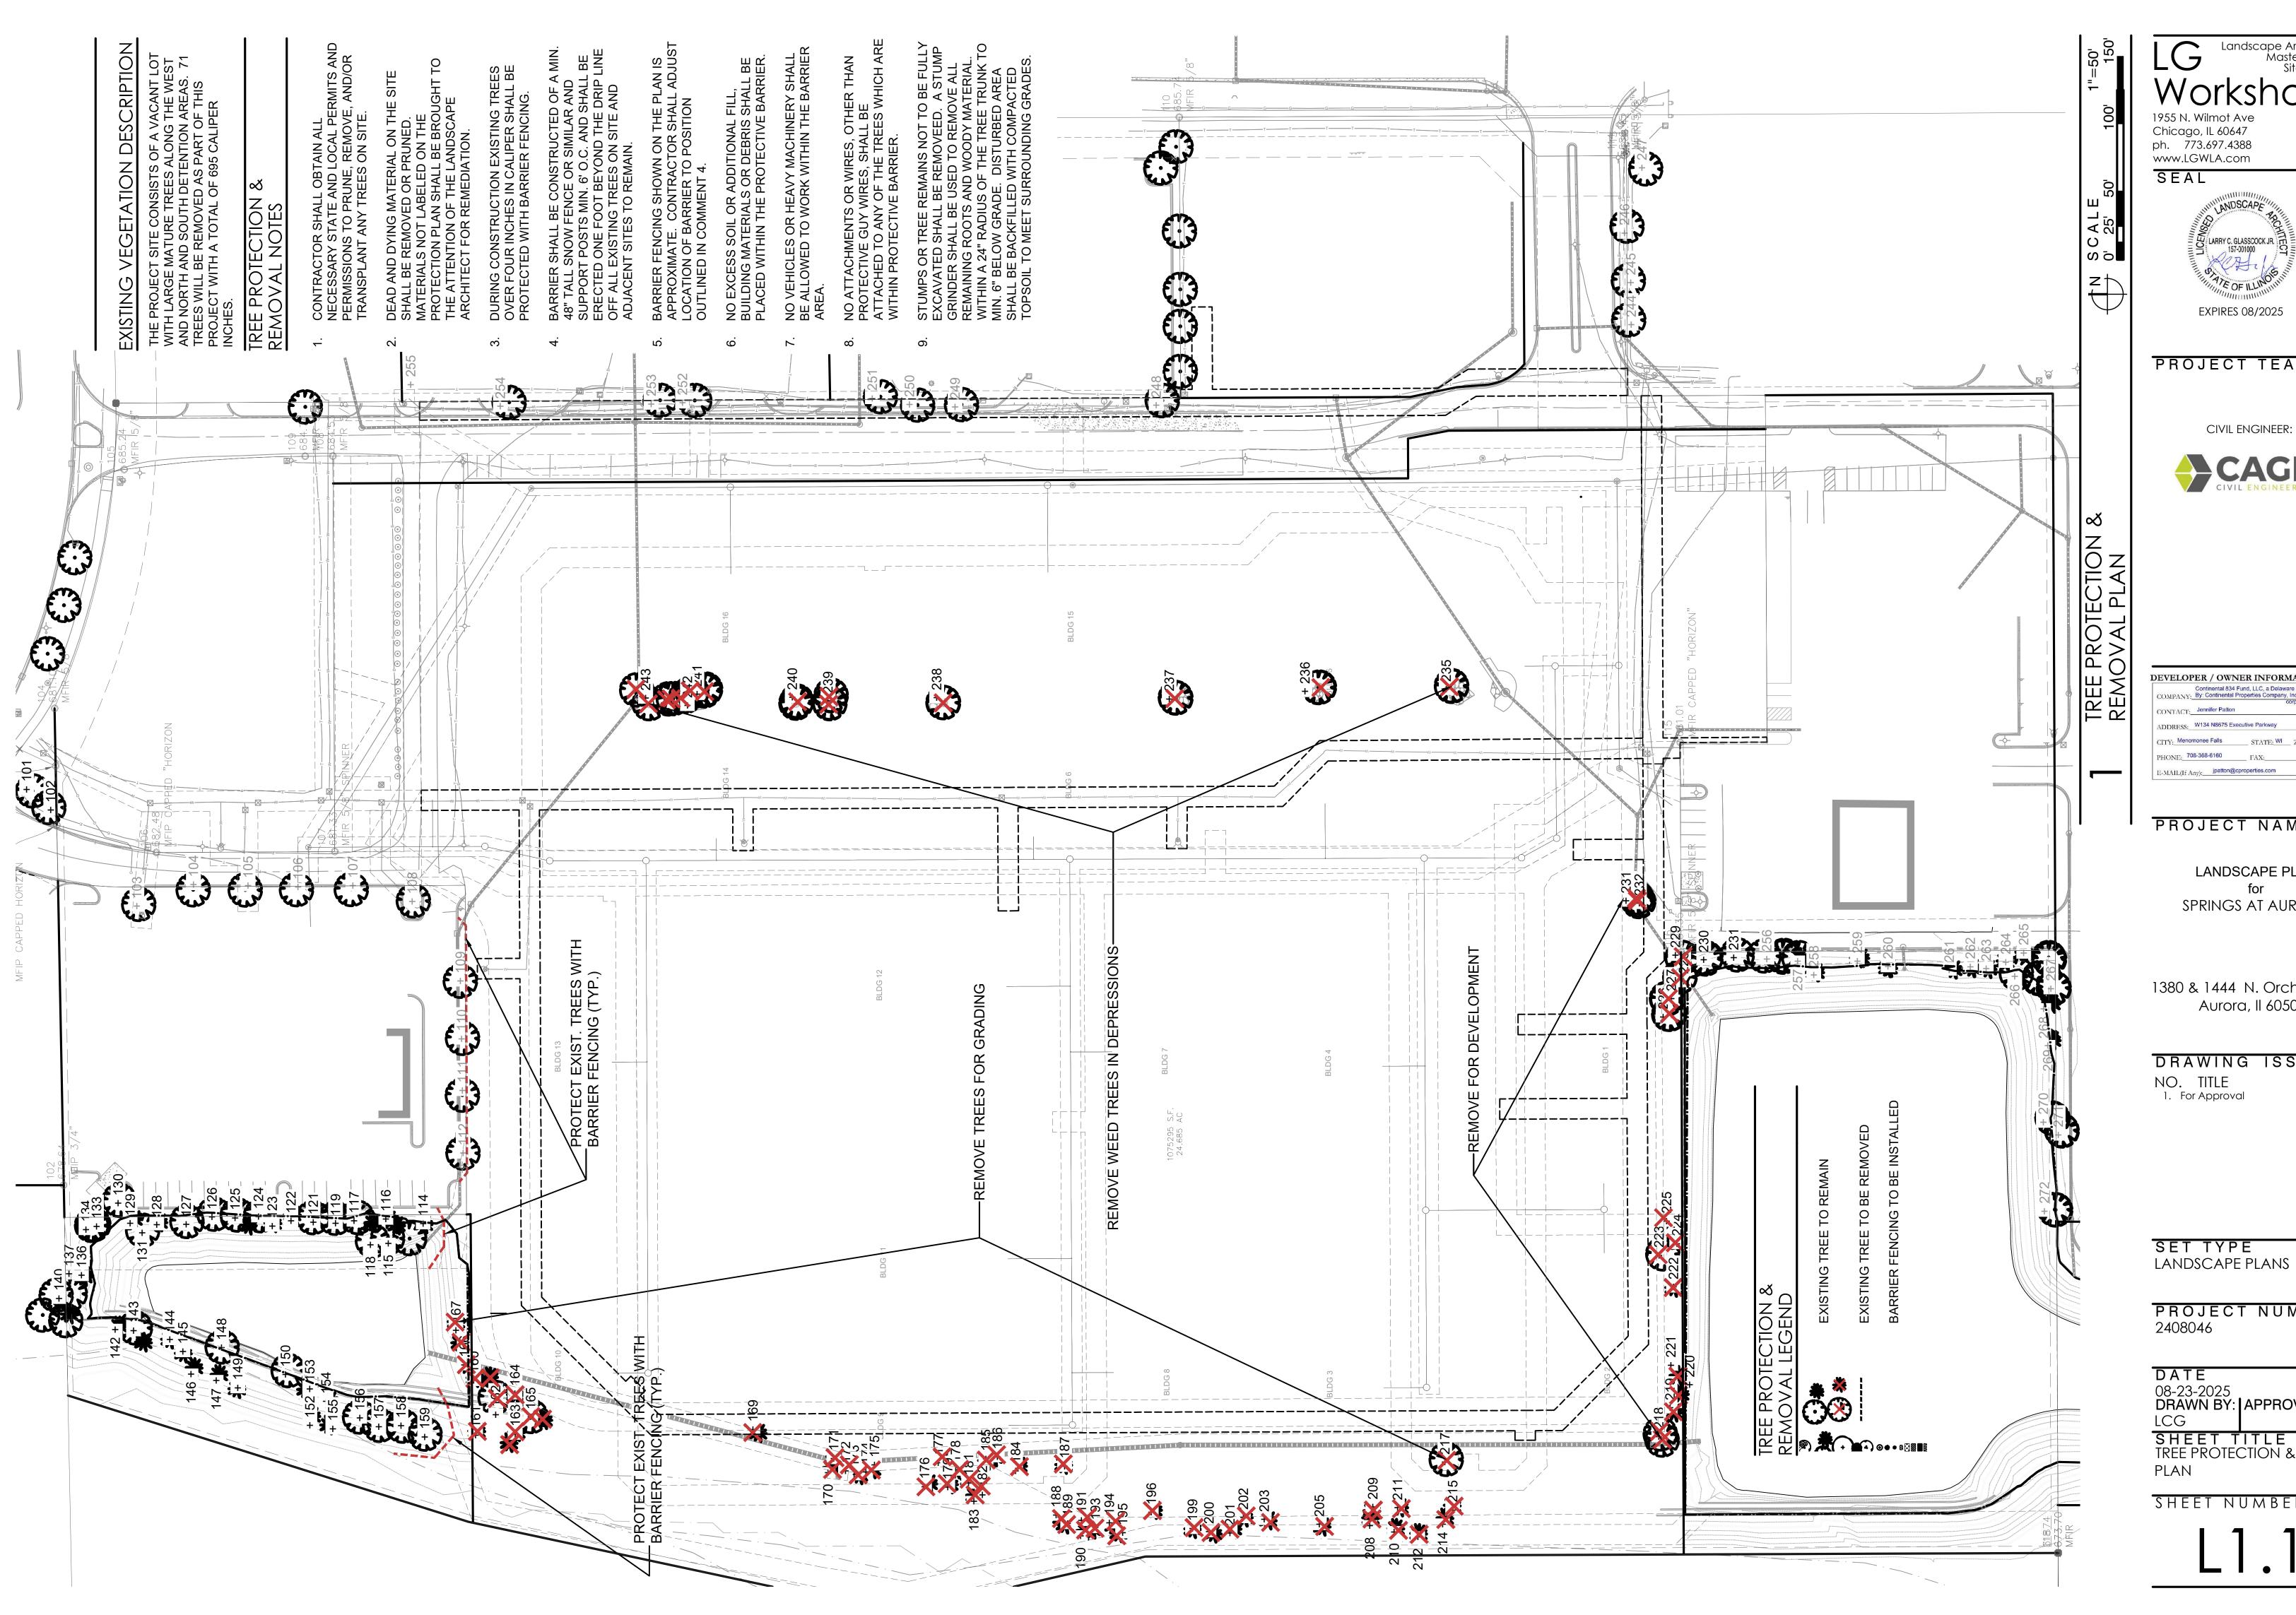

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PROJECT TEAM

CIVIL ENGINEER:



PROJECT NAME


LANDSCAPE PLAN SPRINGS AT AURORA

1380 & 1444 N. Orchard Rd, Aurora, Il 60506

DRAWING ISSUED DATE 06/06/25

PROJECT NUMBER

08-23-2025 DRAWN BY: | APPROVED BY: SHEET TITLE
TREE PROTECTION & REMOVAL

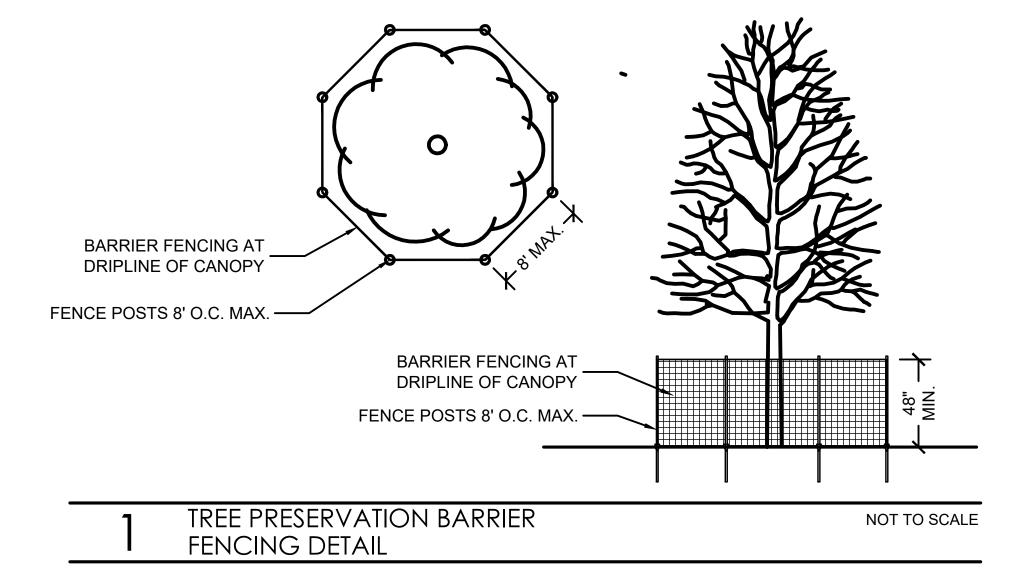

SURVEY OF EXISTING TREES

201 11" Bald Cypress

				Best 5 1-5	
Number	Size	Common Name	Scientific Name	L-5 Condition	Notes
101	15"	Honeylocust	Gleditsia triacanthos v. inermis	5	Off-site, Protect
102	14"	Honeylocust	Gleditsia triacanthos v. inermis	5	Off-site, Protect
103	8"	Honeylocust	Gleditsia triacanthos v. inermis	4	Off-site, Protect
104	9"	Bradford Pear	Pyrus calleryana	4	Off-site, Protect
105	10"	Bradford Pear	Pyrus calleryana	4	Off-site, Protect
106 107	9" 10"	Bradford Pear Bradford Pear	Pyrus calleryana Pyrus calleryana	4	Off-site, Protect Off-site, Protect
107	9"	Honeylocust	Gleditsia Triacanthos v. inermis	4	Off-site, Protect
109	11"	Bradford Pear	Pyrus calleryana	4	Off-site, Protect
110	8"	Bradford Pear	Pyrus calleryana	4	Off-site, Protect
111	7"	Bradford Pear	Pyrus calleryana	4	Off-site, Protect
112	8"	Bradford Pear	Pyrus calleryana	4	Off-site, Protect
113	6/4/4"	White Ash	Fraxinus americana	3	Detention
114	12"	Green Spruce	Picea pungens	4	Detention
115	12" 8"	Green Spruce	Picea pungens	4	Detention
116 117	13"	Green Spruce Honeylocust	Picea pungens Gleditsia triacanthos v. inermis	4	Detention Detention
118	12"	Green Spruce	Picea pungens	3	Detention
119	12"	Green Spruce	Picea pungens	3	Detention
120	6"	Boxelder	Acer negundo	3	Detention
121	8"	Crabapple	Malus ssp.	3	Detention
122	5"	Crabapple	Malus ssp.	3	Detention
123	8"	Crabapple	Malus ssp.	2	Detention
124	13"	Green Spruce	Picea pungens	5	Detention
125	9"	Green Spruce	Picea pungens	4	Detention
126	6/5/4" 12"	Crabapple	Malus ssp.	3	Detention
127 128	12" 8"	Green Spruce Crabapple	Picea pungens Malus ssp.	4	Detention Detention
129	<u> </u>	Crabapple	Malus ssp.	3	Detention
130	12/8"	Honeylocust	Gleditsia triacanthos v. inermis	5	Detention
131	14"	Green Spruce	Picea pungens	4	Detention
132	8/8"	Cottonwood	Populus deltoides	3	Detention
133	14"	Green Spruce	Picea pungens	4	Detention
134	12"	Japanese Zelkova	Zelkova serrata	3	Detention
135	8/8"	Boxelder	Acer negundo	4	Detention
136	10"	Green Spruce	Picea pungens	3	Detention
137	6/6" 8"	Boxelder	Acer negundo	2	Detention
138 139	8" 6"	Boxelder Boxelder	Acer negundo Acer negundo	3 4	Detention Detention
140	6/5/3"	Boxelder	Acer negundo Acer negundo	4	Detention
141	10"	Green Spruce	Picea pungens	4	Detention
142	12"	White Pine	Pinus strobus	4	Detention
143	8/6"	Pear	Pyrus ssp.	4	Detention
144	14"	White Pine	Pinus strobus	4	Detention
145	14"	White Pine	Pinus strobus	5	Detention
146	14"	White Pine	Pinus strobus	4	Detention
147	12"	White Pine	Pinus strobus	4	Detention
148	16" 13"	White Ash White Pine	Fraxinus americana	4	Detention
149 150	12/8"	White Pine	Pinus strobus Pinus strobus	3 4	Detention Detention
151	14"	Siberian Elm	Ulmus pumila	3	Detention
152	12"	Green Spruce	Picea pungens	4	Detention
153	12"	Green Spruce	Picea pungens	4	Detention
154	14"	Green Spruce	Picea pungens	4	Detention
155	12"	Green Spruce	Picea pungens	4	Detention
156	7"	Maidenhair Tree	Ginkgo biloba	5	Detention
157	9"	Maidenhair Tree	Ginkgo biloba	4	Detention
158	8"	Green Spruce	Picea pungens	4	Detention
159	14" 12"	Green Spruce	Picea pungens	4	Detention
160 161	12"	Green Spruce Green Spruce	Picea pungens Picea pungens	4	Detention
162	14"	Green Spruce	Picea pungens	4	Remove for dev.
163	12"	Green Spruce	Picea pungens	4	Remove for dev.
164	12"	Green Spruce	Picea pungens	4	Remove for dev.
165	12"	Green Spruce	Picea pungens	4	Remove for dev.
166	14"	Green Spruce	Picea pungens	4	Detent Remove
167	7/4"	Boxelder	Acer negundo	3	Detent Remove
168	13"	Green Spruce	Picea pungens	4	Remove for dev.
169	8"	Green Spruce	Picea pungens	4	Remove for dev.
170	14" 7"	Green Spruce	Picea pungens	3	Remove for dev.
171 172	7" 12"	Boxelder Green Spruce	Acer negundo Picea pungens	3	Remove for dev. Remove for dev.
173	12"	Austrian Pine	Pinus nigra	5	Remove for dev.
174	12"	Siberian Elm	Ulmus pumila	3	Remove for dev.
175	8/8"	White Pine	Pinus strobus	4	Remove for dev.
176	8"	White Pine	Pinus strobus	4	Remove for dev.
177	7"	White Pine	Pinus strobus	4	Remove for dev.
178	10"	White Pine	Pinus strobus	4	Remove for dev.
179	12"	White Pine	Pinus strobus	4	Remove for dev.
180	8"	Boxelder	Acer negundo	2	Remove for dev.
181	14"	White Pine	Pinus strobus	4	Remove for dev.
182 183	14" 14"	White Pine White Pine	Pinus strobus Pinus strobus	4	Remove for dev.
184	8"	White Pine White Pine	Pinus strobus Pinus strobus	2	Remove for dev.
185	14"	White Pine White Pine	Pinus strobus Pinus strobus	4	Remove for dev.
186	14"	White Pine	Pinus strobus	4	Remove for dev.
187	12"	White Pine	Pinus strobus	4	Remove for dev.
188	10"	White Pine	Pinus strobus		Remove for dev.
189	10"	White Pine	Pinus strobus	4	Remove for dev.
190	8/8/8"	Boxelder	Acer negundo		Remove for dev.
191	7"	White Pine	Pinus strobus	3	Remove for dev.
192	8"	Boxelder	Acer negundo	3	Remove for dev.
193	9"	Boxelder	Acer negundo	3	Remove for dev.
194	14"	White Pine	Pinus strobus	3	Remove for dev.
195	14"	White Pine	Pinus strobus	4	Remove for dev.
196	7"	Boxelder	Acer negundo	3	Remove for dev.
197		-			
198	14"	White Pine	Dinus strahus	4	Pomove for L
199 200	9"	Bald Cypress	Pinus strobus Taxodium distichum	2	Remove for dev.
201	9 11"	Bald Cypress	Taxodium distichum	2	Remove for dev.
		I Daid Cypicss	, and arail and the rail		

Taxodium distichum

2 Remove for dev.

202	16"	White Pine	Pinus strobus	4	Remove for dev.
203	6/4/3"	River Birch	Betula nigra	5	Remove for dev.
204	***************************************				
205	18"	White Pine	Pinus strobus	4	Remove for dev.
206					
207					
208	14"	White Pine	Pinus strobus	3	Remove for dev.
209	12"	White Pine	Pinus strobus	4	Remove for dev.
210	8/6/6"	Green Spruce	Picea pungens	4	Remove for dev.
211	14"	Green Spruce	Picea pungens	4	Remove for dev.
212	12"	Green Spruce	Picea pungens	3	Remove for dev.
212	12	Green spruce	Picea puligelis	3	Remove for dev.
	8"	C C	D:	1	D fl
214		Green Spruce	Picea pungens	4	Remove for dev.
215	12"	Green Spruce	Picea pungens	4	Remove for dev.
216					
217	7"	Siberian Elm	Ulmus pumila	3	Remove for dev.
218	6/6/6"	Boxelder	Acer negundo	2	Detent Remove
219	6/6/6"	Boxelder	Acer negundo	3	Detent Remove
220	14"	White Pine	Pinus strobus	4	Detent Remove
221	10"	White Pine	Pinus strobus	4	Detent Remove
222	8/8"	White Pine	Pinus strobus	4	Detent Remove
223	7"	Green Spruce	Picea pungens	3	Detent Remove
224	10"	White Ash	Fraxinus americana	3	Detent Remove
225	8"	Green Spruce	Picea pungens	4	Detent Remove
226	5/6"	White Pine	Pinus strobus	4	Detent Remove
227	11"	Cottonwood	Populus deltoides	3	Detent Remove
228	7"	Crabapple	Malus ssp.	4	Detent Remove
229	6/6/4"	Crabapple	Malus ssp.	3	Detent. Remove
230	8"	Crabapple	Malus ssp.	3	Detent Remove
231	10"	Honeylocust	Gleditsia triacanthos v. inermis	5	Detent. Remove
232	8/4/4"	Cottonwood	Populus deltoides	3	
233	0/4/4	Cottonwood	ropulus deltoides		
234	C /E /AII	DL-I		1	l D
235	6/5/4"	Boxelder	Acer negundo	3	depress. Remove
236	6/5/4"	Pear	Pyrus ssp.	4	depress. Remove
237	6/5/5"	Boxelder	Acer negundo	3	depress. Remove
238	6"	Cottonwood	Populus deltoides	3	depress. Remove
239	6/4"	Cottonwood	Populus deltoides	3	depress. Remove
240	6/4"	Cottonwood	Populus deltoides	3	depress. Remove
241	6"	Cottonwood	Populus deltoides	3	depress. Remove
242	6"	Cottonwood	Populus deltoides	3	depress. Remove
243	6"	Cottonwood	Populus deltoides	3	depress. Remove
244	7"	Freeman Maple	Acer x freemanii	5	Off-site, Protect
245	4"	Freeman Maple	Acer x freemanii	5	Off-site, Protect
246	12"	Freeman Maple	Acer x freemanii	5	Off-site, Protect
247	8"	Crabapple	Malus ssp.	5	Off-site, Protect
248	8"	White Oak	Quercus Alba	5	Off-site, Protect
249	9"	Littleleaf Linden	Tilia cordata	5	Off-site, Protect
250	10"	Littleleaf Linden	Tilia cordata	5	Off-site, Protect
251	10"	Littleleaf Linden	Tilia cordata	5	Off-site, Protect
252	10 	Red Maple	Acer rubrum	4	Off-site, Protect
253	10"	Freeman Maple	Acer x freemanii	5	Off-site, Protect
254	10"	Freeman Maple	Acer x freemanii	5	Off-site, Protect
255	4"	Red Maple	Acer Rubrum	4	Off-site, Protect
256	4 5"			4	Detention
		Crabapple	Malus ssp.		
257	8"	White Pine	Pinus strobus	3	Detention
258	10"	White Pine	Pinus strobus	4	Detention
259	8"	White Pine	Pinus strobus	3	Detention
260	8"	White Pine	Pinus strobus	4	Detention
261	9"	White Pine	Pinus strobus	4	Detention
262	10"	White Pine	Pinus strobus	4	Detention
263	10"	White Pine	Pinus strobus	4	Detention
264	8"	White Pine	Pinus strobus	4	Detention
	12"	Boxelder	Acer negundo	3	Detention
265	7"	Boxelder	Acer negundo	3	Detention
265 266	6"	Crabapple	Malus ssp.	3	Detention
$\overline{}$	6		Pinus strobus	4	Detention
266 267		IWhite Pine	1	, ,	
266 267 268	10"	White Pine	Pinus strobus	2	Detention
266 267 268 269	10" 12"	White Pine	Pinus strobus	3	Detention
266 267 268 269 270	10" 12" 6"	White Pine Boxelder	Acer negundo	3	Detention
266 267 268 269 270 271	10" 12" 6" 5/5/4"	White Pine Boxelder River Birch	Acer negundo Betula nigra	3	Detention Detention
266 267 268 269 270	10" 12" 6"	White Pine Boxelder River Birch Pear	Acer negundo	3	Detention





PROJECT TEAM

CIVIL ENGINEER:



DEVELOPER / OWNER INFORMATION ADDRESS: W134 N8675 Executive Parkway PHONE: 708-368-6160 FAX: E-MAIL(If Any): jpatton@cproperties.com

PROJECT NAME

LANDSCAPE PLAN SPRINGS AT AURORA

1380 & 1444 N. Orchard Rd, Aurora, Il 60506

DRAWING ISSUED NO. TITLE

1. For Approval DATE 06/06/25


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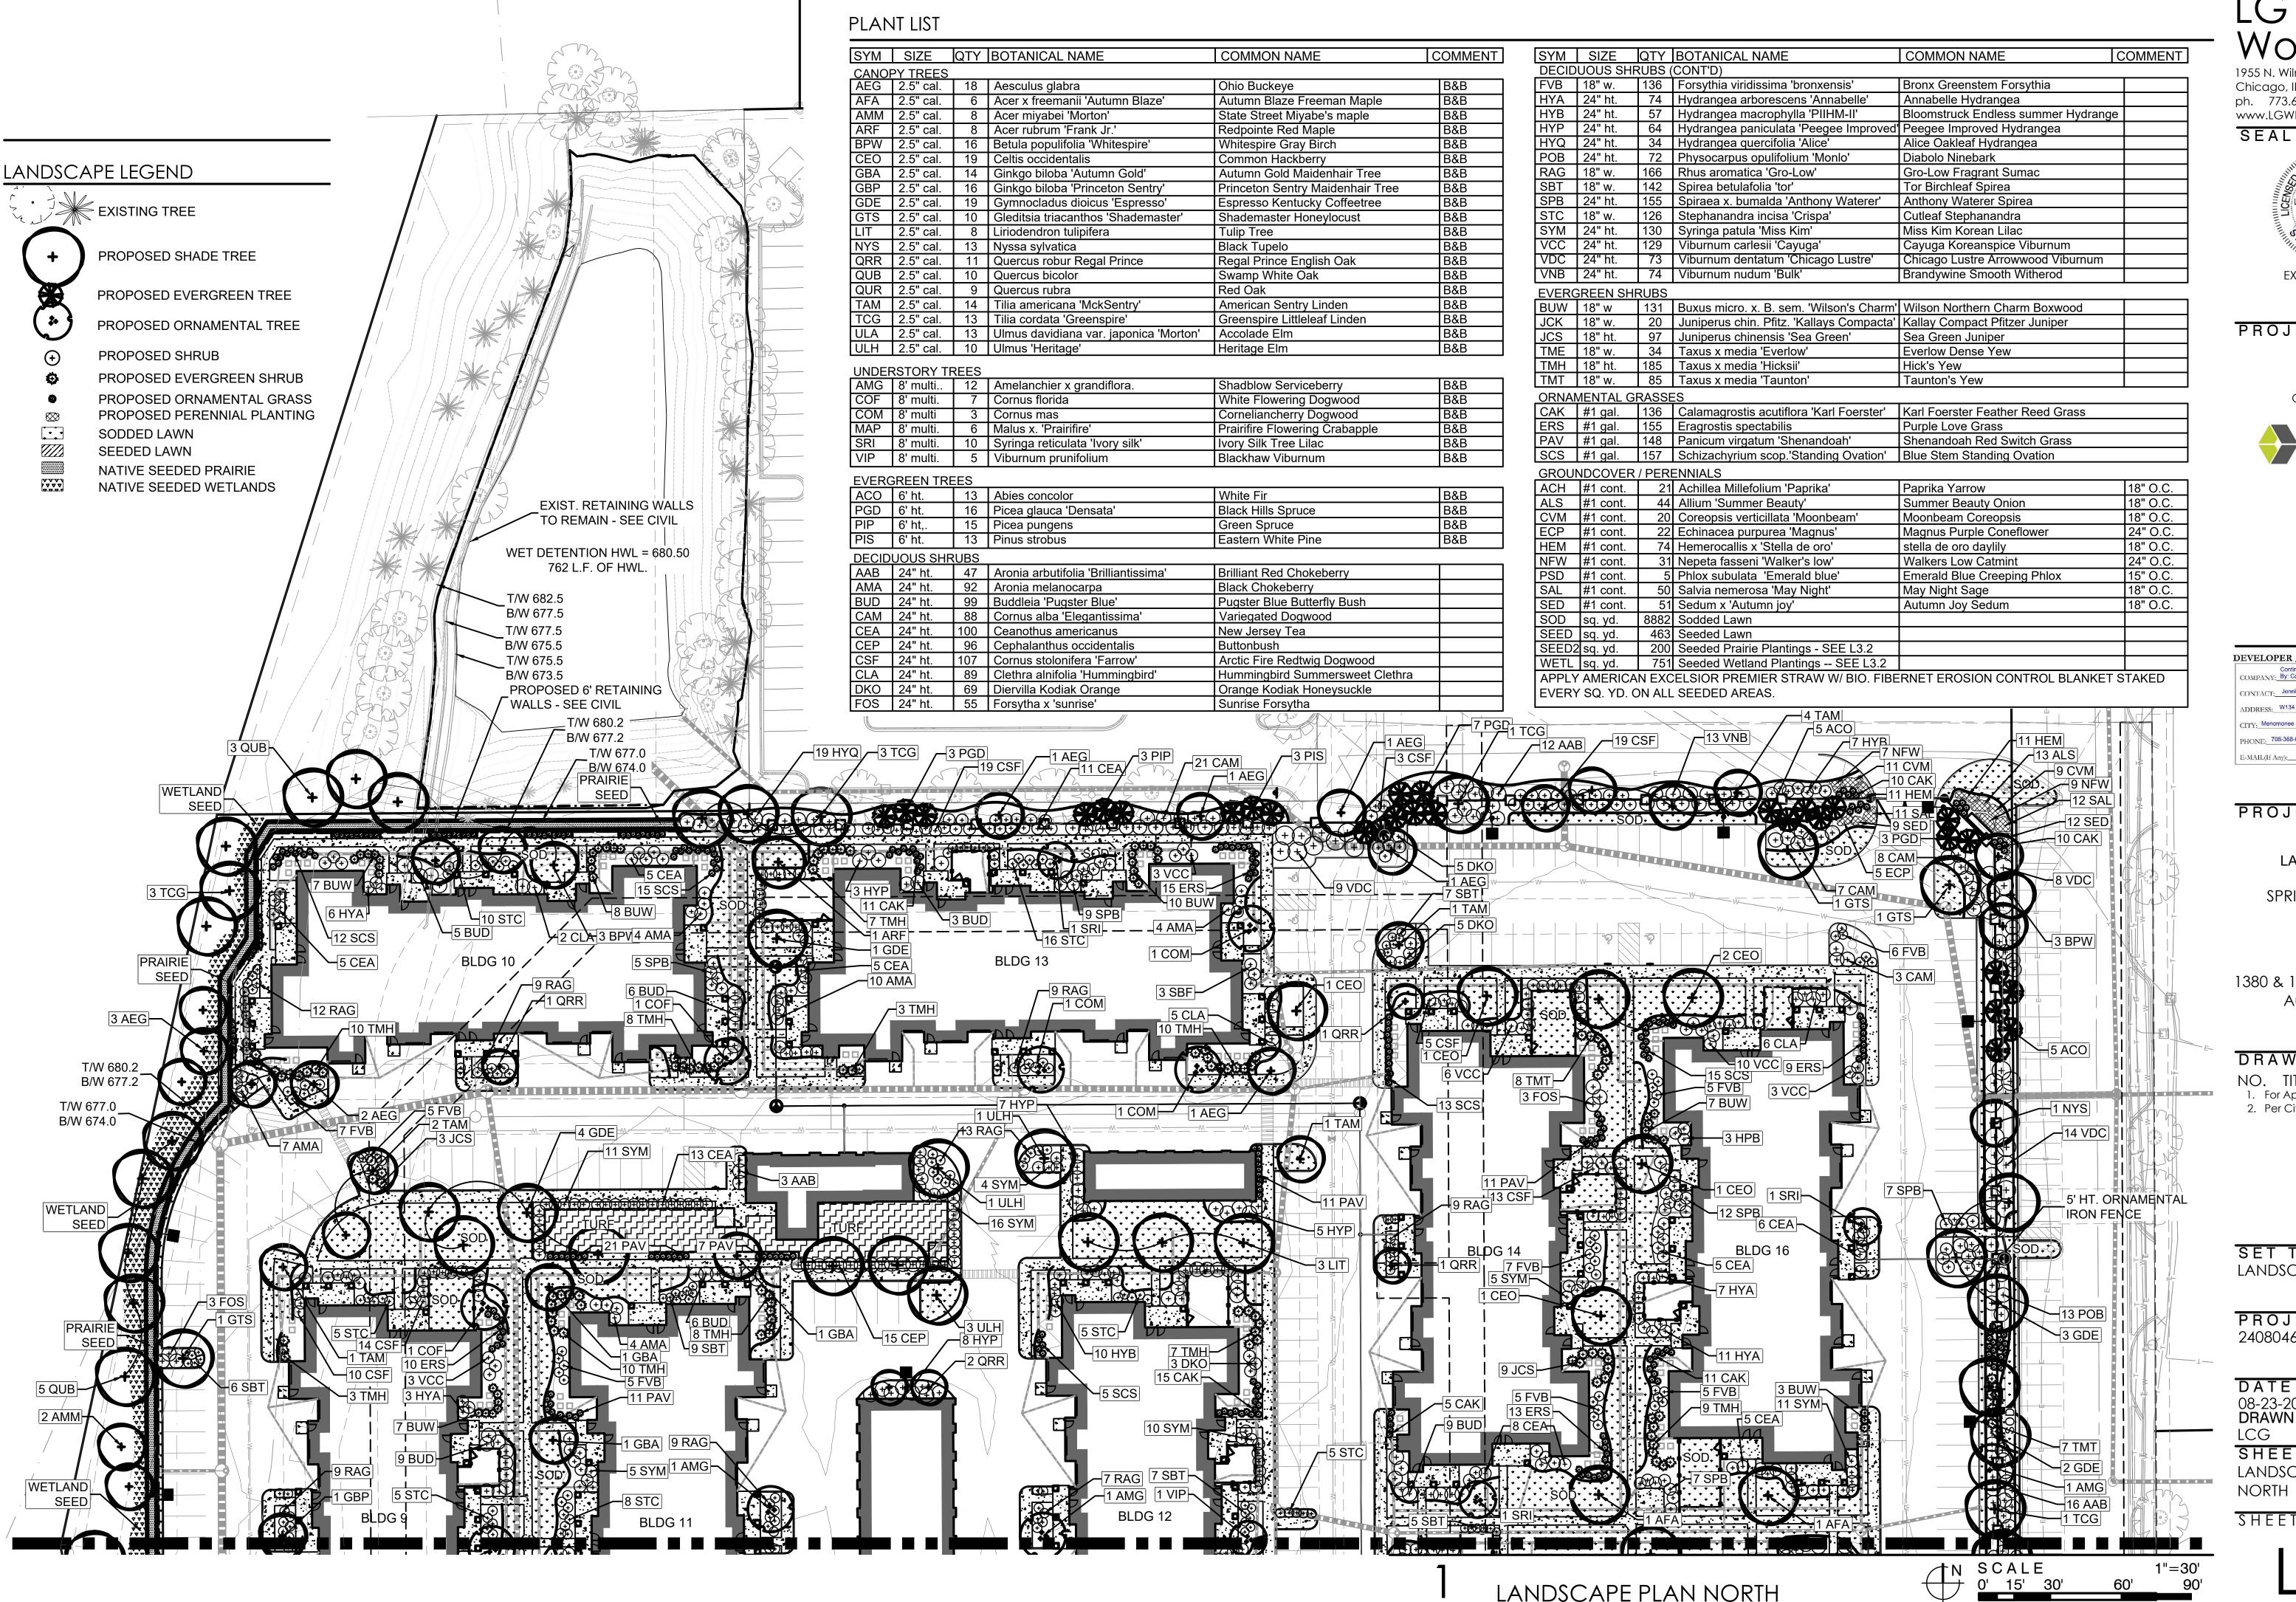
LANDSCAPE PLANS

PROJECT NUMBER 2408046

DATE
08-23-2025
DRAWN BY: APPROVED BY:
LCG LCG

SHEET TITLE TREE SURVEY DATA / BARRIER FENCING DETAIL



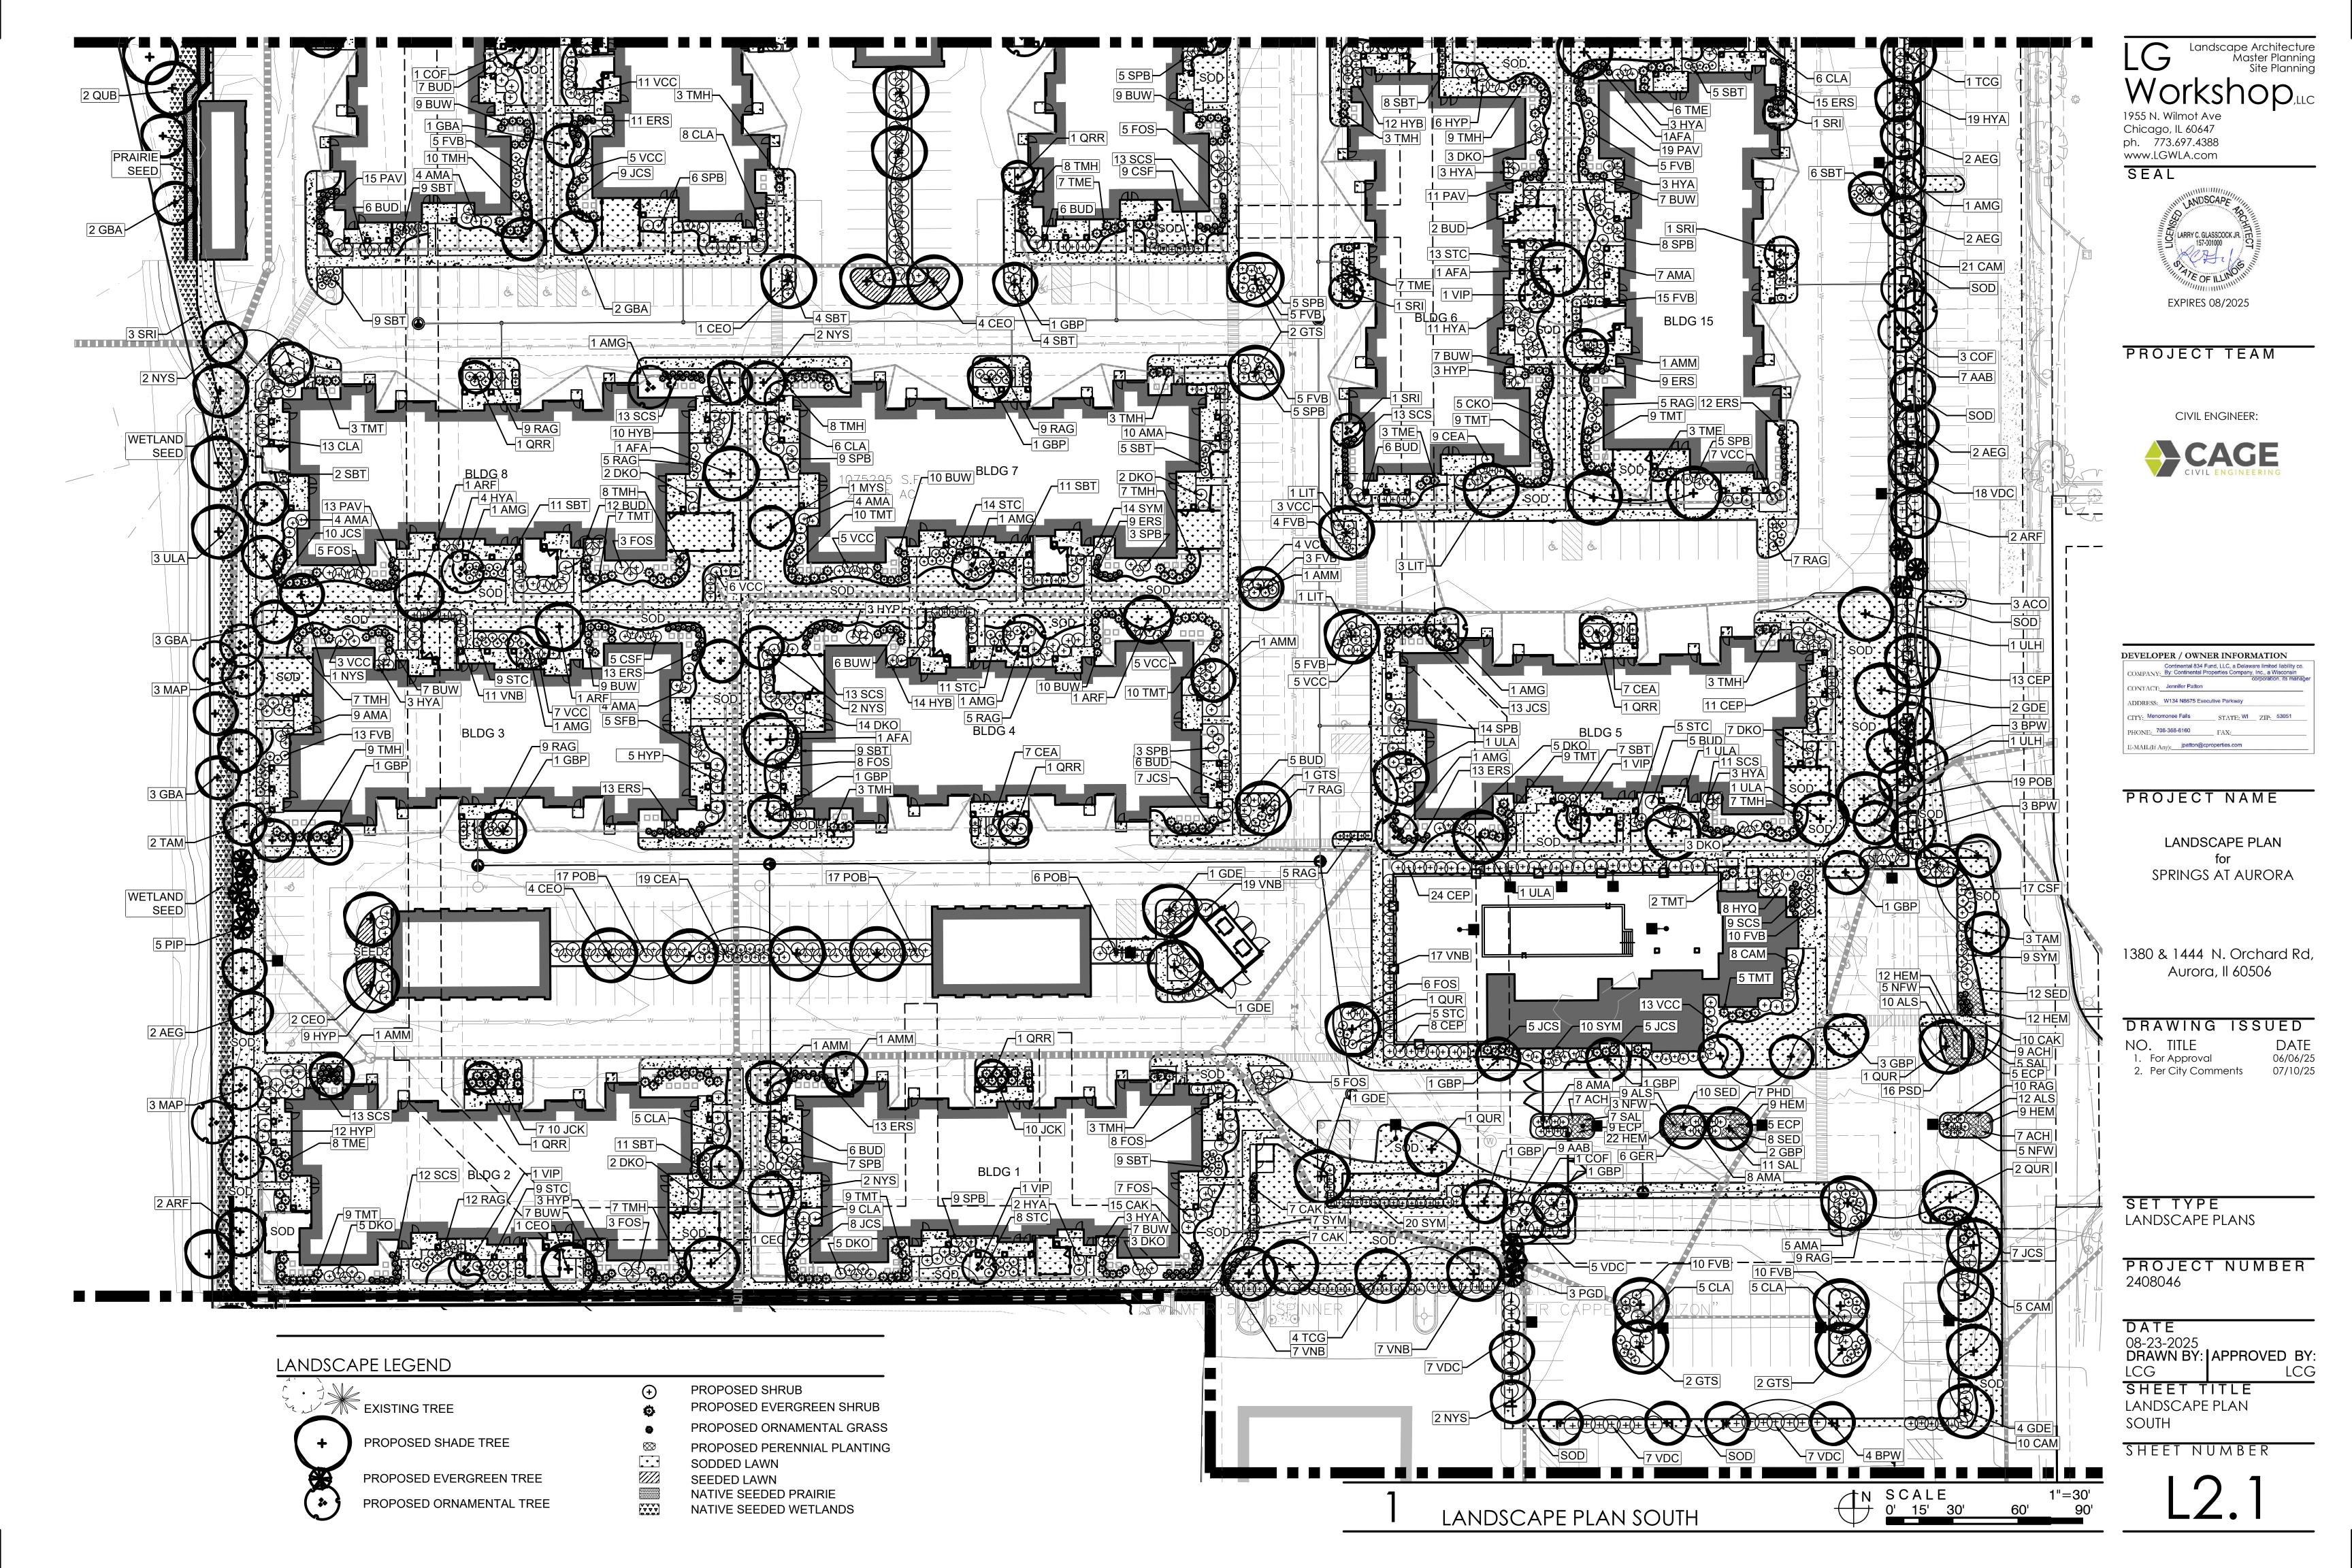

1955 N. Wilmot Ave

Chicago, IL 60647 ph. 773.697.4388 www.LGWLA.com



PROJECT TEAM

CIVIL ENGINEER:



DEVELOPER / OWNER INFORMATION Continental 834 Fund, LLC, a Delaware limited liability co.

MPANY: By: Continental Properties Company, Inc., a Wisconsin corporation, its manage DDRESS: W134 N8675 Executive Parkway STATE: WI ZIP: 53051 PHONE: 708-368-6160 E-MAIL(If Any): jpatton@cproperties.com

PROJECT NAME

LANDSCAPE PLAN SPRINGS AT AURORA

1380 & 1444 N. Orchard Rd, Aurora, Il 60506

DRAWING ISSUED

06/06/25


. For Approval 2. Per City Comments

SET TYPE LANDSCAPE PLANS

PROJECT NUMBER 2408046

DATE 08-23-2025 DRAWN BY: | APPROVED BY:

SHEET TITLE LANDSCAPE PLAN

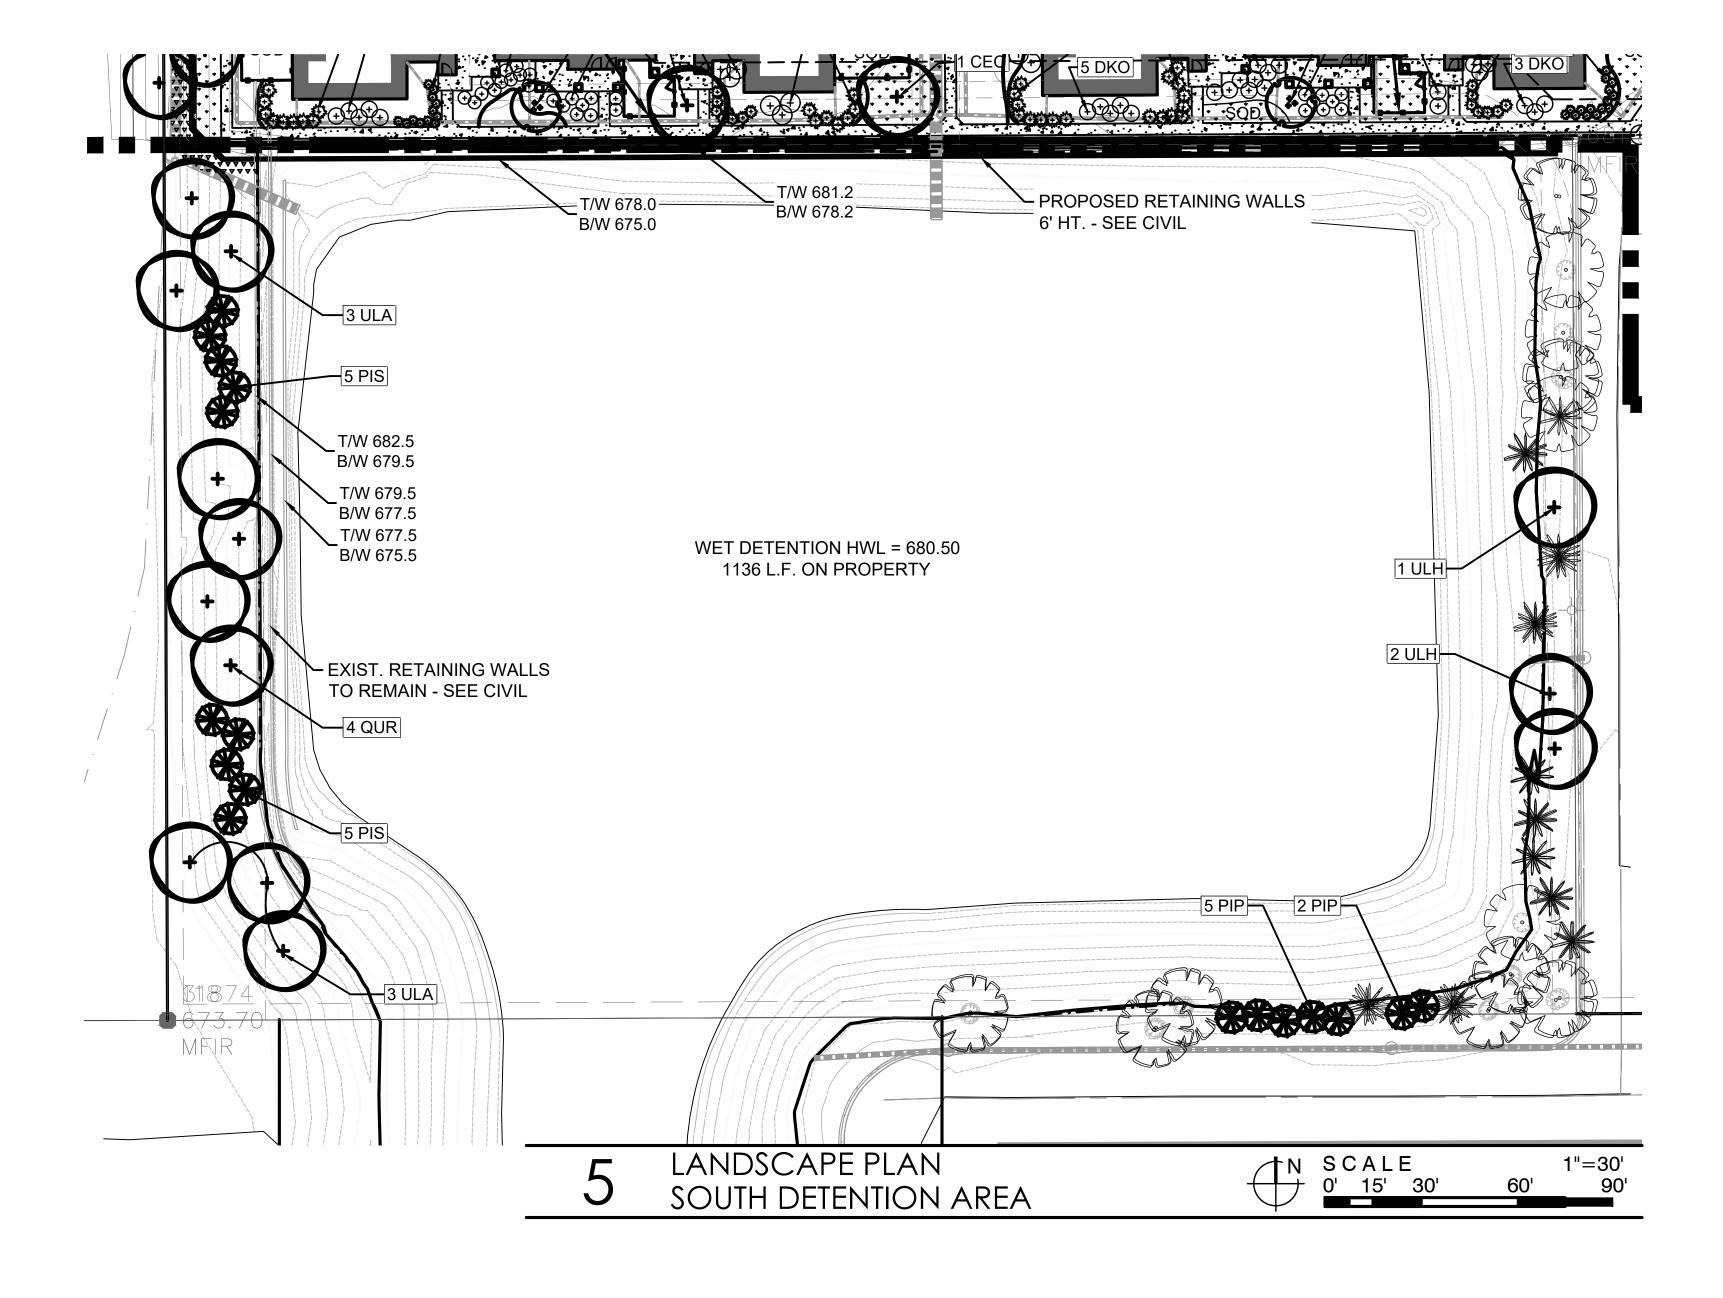


LANDSCAPE NOTES

- CONTRACTOR SHALL OBTAIN ALL NECESSARY LOCAL PERMITS AND PERMISSIONS TO INSTALL THE PROPOSED IMPROVEMENTS
- 2. ALL LANDSCAPE MATERIALS SHALL BE INSTALLED IN ACCORDANCE WITH THE CITY OF AURORA LANDSCAPING CODES AND ZONING ORDINANCES.
- 3. PRIOR TO COMMENCING ANY WORK, CONTRACTOR SHALL HAVE DIGGERS HOTLINE LOCATE AND MARK ALL UNDERGROUND UTILITY FACILITIES AND LINES.
- 4. ALL PLANT MATERIALS (EXCEPT FOR GROUNDCOVER, ANNUALS, AND PERENNIALS) SHALL BE BALLED AND BURLAPPED STOCK AND MEET CURRENT STANDARDS OF THE AMERICAN ASSOCIATION OF NURSERYMEN'S STANDARD FOR NURSERY STOCK (ANSI 260.1-1986) OR EQUAL. PLANT MATERIALS MUST BE SUPPLIED WITHIN A 150 MILE RADIUS OF PROJECT SITE. CONTRACTOR MAY SUBSTITUTE CONTAINER STOCK FOR SHRUBS IF SIZES ARE EQUAL TO SPECIFIED B&B STOCK, WITH THE APPROVAL OF THE LANDSCAPE ARCHITECT.
- 5. IF SPECIFIED PLANTS ARE NOT AVAILABLE AT THE TIME OF ORDERING, PLANTS WITH SIMILAR WHOLESALE VALUE AND LANDSCAPE CHARACTERISTICS MAY BE SUBSTITUTED UPON THE APPROVAL OF THE LANDSCAPE ARCHITECT AND VILLAGE STAFF.
- 6. CLEAN TOPSOIL SHALL BE UTILIZED IN ALL PLANT BED AREAS.
- 7. A GRANULAR PRE-EMERGENT HERBICIDE SHALL BE PROVIDED ACROSS THE SURFACE OF ALL PLANTING BEDS AND/OR TREE PIT AREAS IN ACCORDANCE WITH MANUFACTURER'S WRITTEN INSTRUCTIONS
- 8. SOIL IN GROUNDCOVER BEDS SHALL BE AMENDED USING 2 INCHES OF MUSHROOM COMPOST INCORPORATED INTO THE TOP 4 INCHES OF SOIL.
- 9. DISTURBED AREAS TO RECEIVE REMEDIATION SHALL BE TILLED TO 6" DEPTH AND FINE GRADED TO PROVIDE SMOOTH BASE SURFACE. IF EXISTING SOIL IS A MAJORITY OF CLAY OR UNSUITABLE, 2" OF FINE GRADED TOPSOIL SHALL BE ADDED PRIOR TO TILLING. EXISTING SOD AREAS SHALL HAVE TURF REMOVED WITH AUTOMATED SODCUTTER OR HAND SPACE TO REMOVE ALL BLADES AND ROOTS. 1" OF FIND GRADED TOPSOIL SHALL BE TILLED AND GRADED.
- 10. TREE AND SHRUB BACKFILL MIXTURE SHALL BE 2 PARTS EXIST. NATIVE TOPSOIL AND 1 PART SPHAGNUM PEAT MOSS W/ DECOMPOSED MANURE.

- 12. ALL SHRUB BEDS AND INDIVIDUAL TREE PLANTINGS, UNLESS OTHERWISE NOTED, SHALL RECEIVE A 4" BLACK PLASTIC EDGING AND 2" DEPTH WASHED LIGHT GRAY/BROWN STONE MULCH (3/8"-3/4" SIZE). COSTS FOR MULCH SHALL BE CONSIDERED INCIDENTAL AND SHALL BE INCLUDED IN THE COST OF PLANTINGS.
- 13. NURSERY TAGS (SPECIES, SIZE) FOR ALL SHADE TREES SHALL REMAIN ATTACHED TO TREES UNTIL FINAL APPROVAL FROM MUNICIPALITY.
- 14. THE LANDSCAPE CONTRACTOR SHALL PROVIDE THE OWNER A BONDED WRITTEN ONE-YEAR WARRANTY AGREEMENT (BEGINNING ON THE OWNER'S POSSESSION DATE). THIS AGREEMENT SHALL COVER MAINTENANCE, REPAIR, AND REPLACEMENT OF ALL DEAD OR DAMAGED LANDSCAPING TO PRESERVE THE SAME QUANTITY AND QUALITY AS INITIALLY APPROVED.
- 15. CONTRACTOR SHALL PROVIDE A SEPARATE ESTIMATE FOR AN AUTOMATIC UNDERGROUND IRRIGATION SYSTEM FOR COMPLETE EFFECTIVE COVERAGE OF ALL LAWN AREAS AND SHRUB BEDS. CONTRACTOR SHALL SUBMIT SHOP DRAWINGS FOR APPROVAL AND APPLY FOR ALL NECESSARY PERMITS PRIOR TO COMMENCING WORK. IRRIGATION PLANS SHALL INCLUDE HUNTER PRO-C CONTROLLER W/WIRELESS SOLAR SYNC STATION AND HUNTER SPRAYHEADS AND NOZZLES. IRRIGATION WORK SHALL BE WARRANTY ALL LABOR AND MATERIALS FOR 1 FULL YEAR AFTER INSTALLATION AND TESTING.
- 16. SEEDED LAWN AREAS SHALL BE BID WITH A BID ALTERNATE FOR HYDROSEEDED LAWN. PRIOR TO SEEDING, 2" OF FINE TOPSOIL SHALL BE TILLED INTO EXIST SOIL MIXTURE. A MIX CONSISTING OF ROUGHLY 30 % BLUEGRASS / 30% FINE FESCUES / 40% RYE GRASSES (AND TACKIFIER FOR HYDROSEEDING) SHALL BE APPLIED AT MANUFACTURERS SPECIFIED RATES FOR NEW LAWNS BETWEEN 5 AND 10 LBS PER 1,0000 SF.
- 17. TREES AND SHRUBS SHALL NOT BE LOCATED CLOSER THAN TEN (10) FEET TO FIRE HYDRANTS, TRANSFORMERS OR OTHER ABOVE GROUND UTILITIES. ANY DISCREPANCY ON THE PLAN RELATED TO THESE PROXIMATE UTILITIES SHALL BE BROUGHT TO THE ATTENTION OF THE LANDSCAPE ARCHITECT FOR RESOLUTION.
- 18. STAKE ANY TREES PLANTED ON SLOPES OF 3:1 OR GREATER, IN AREAS OF HIGH WINDS.
- 19. A 48" DIAMETER MULCH RING WITH A SHOVEL | CUT EDGE SHALL BE SHOWN AROUND ALL TREES PLANTED IN LAWN AREAS.

11. BLACK PLASTIC EDGING SHALL BE USED AT ALL BED EDGES

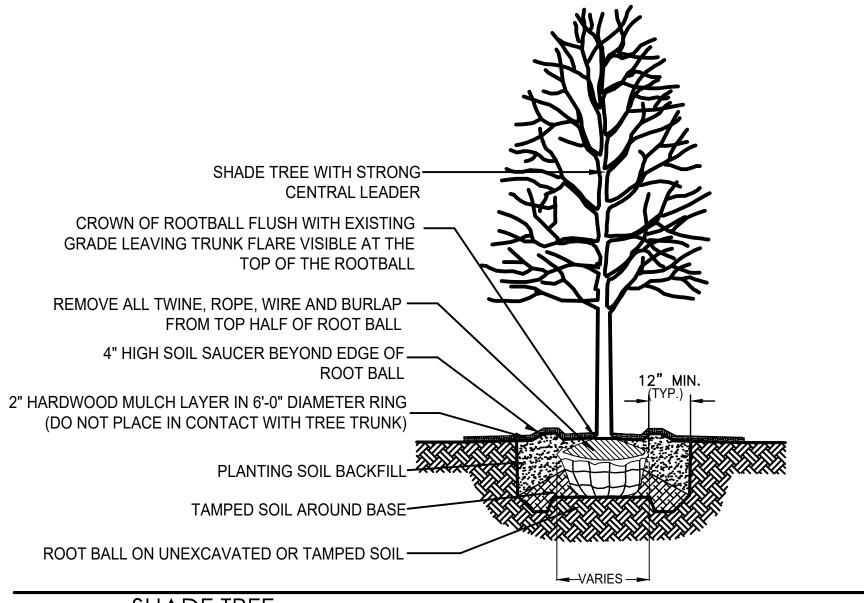

SHADE TREE PLANTING DETAIL NOT TO SCALE

NOT TO SCALE

NOT TO SCALE



DEVELOPER / OWNER INFORMATION

HONE: 708-368-6160

E-MAIL(If Any): jpatton@cproperties.com

PROJECT NAME

LANDSCAPE PLAN

SPRINGS AT AURORA

1380 & 1444 N. Orchard Rd,

Aurora, Il 60506

DRAWING ISSUED

DATE

06/06/25

07/10/25

CIVIL ENGINEER:

LARRY C. GLASSCOCK JR.

EXPIRES 08/2025

PROJECT TEAM


Landscape Architecture

1955 N. Wilmot Ave Chicago, IL 60647

ph. 773.697.4388

www.LGWLA.com

SEAL

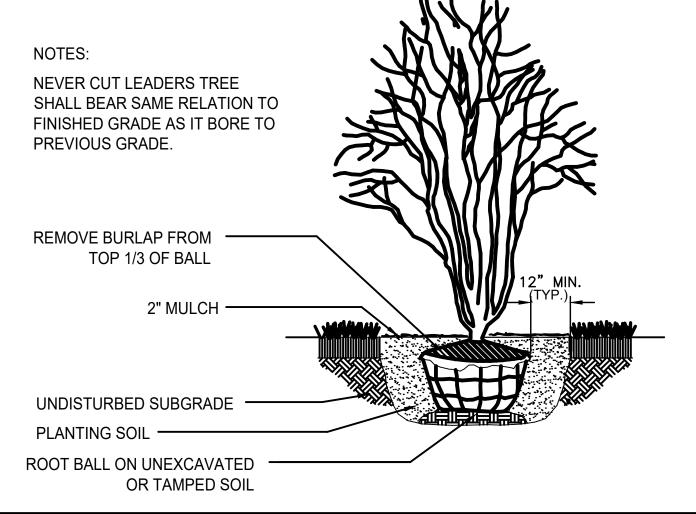

ORNAMENTAL TREE PLANTING DETAIL

CROWN OF ROOTBALL FLUSH ___ WITH EXISTING GRADE REMOVE BURLAP FROM TOP 1/2 OF BALL OR ENTIRE CONTAINER 2" MULCH — PLANTING SOIL BACKFILL -**EXISTING SUBGRADE**

SHRUB PLANTING DETAIL

SET TYPE

DATE

LCG

NO. TITLE

1. For Approval

2. Per City Comments


LANDSCAPE PLANS

PROJECT NUMBER 2408046

08-23-2025 DRAWN BY: APPROVED BY:

LANDSCAPE PLAN @ SOUTH


DETENT. - DETAILS & NOTES

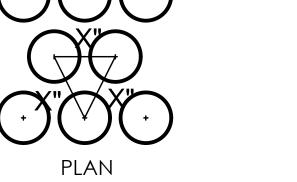

SHEET NUMBER

SHEET TITLE

NOT TO SCALE

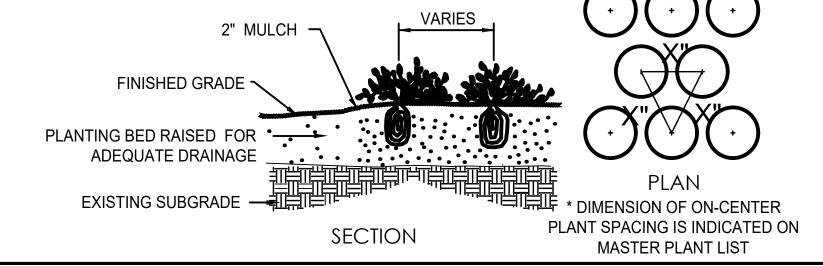

PERENNIAL / ANNUAL PLANTING DETAIL

SEED MIX - LOW PRAIRIE

COMPONENTS

Forbs (Wildflowers) Allium cernuum - Nodding Pink Onion Aster laevis - Smooth Aster Astragalus canadensis - Canada Milk Vetch Baptisia bracteata - Cream False Indigo Coreopsis lanceolata - Lanceleaf Coreopsis Dalea candida - White Prairie Clover Dalea purpurea - Purple Prairie Clover Dodecatheon meadia - Shootingstar Echinacea purpurea - Purple Coneflower Liatris pycnostachya - Prairie Blazing Star Parthenium integrifolium - Wild Quinine Penstemon digitalis - Smooth Penstemon Rudbeckia hirta - Black Eyed Susan Solidago ohioensis - Ohio Goldenrod Solidago rigida - Stiff Goldenrod Tradescantia ohiensis - Ohio Spiderwort

Zizia aurea - Golden Alexanders

Detention Basin -Low-Growing Prairie for Clay Soils Available Through: Prairie Nursery, Inc. P.O. Box 306, Westfield, WI 53964. 1-800-476-9453. www.PrairieNurserv.com - 10 Lbs per Acre

Grasses

Bouteloua curtipendula - Sideoats Grama Carex bicknellii - Copper Shouldered Oval Schizachyrium scoparium - Little Bluestem Sporobolus heterolepis - Prairie Dropseed

Carex vulpinoidea - Fox Sedge

SEED MIX - WETLAND

COMPONENTS

Forbs (Wildflowers) Allium cernuum - Nodding Pink Onion Arnoglossum atriplicifolium - Pale Indian Plantain Asclepias incarnata - Red Milkweed Aster novae-angliae - New England Aster Baptisia alba - White False Indigo Eupatorium maculatum - Joe Pye Weed Eupatorium perfoliatum - Boneset Helenium autumnale - Dogtooth Daisy Heliopsis helianthoides - Ox Eye Sunflower Iris shrevei - Wild Iris Iris versicolor - Blue Flag Iris


Liatris pycnostachya - Prairie Blazing Star

Liatris spicata - Dense Blazing Star

Detention Basin - Bioswale Seed Mix Available Through: Prairie Nursery, Inc. P.O. Box 306, Westfield, WI 53964. 1-800-476-9453. www.PrairieNurserv.com - 10 Lbs per Acre

Lobelia siphilitica - Great Blue Lobelia Monarda fistulosa - Bergamot Ratibida pinnata - Yellow Coneflower Rudbeckia hirta - Black Eyed Susan Rudbeckia subtomentosa - Sweet Black Eyed Rudbeckia triloba - Brown Eyed Susan Senna hebecarpa - Wild Senna Silphium integrifolium - Rosinweed Silphium perfoliatum - Cupplant Silphium terebinthinaceum - Prairie Dock Solidago ohioensis - Ohio Goldenrod Solidago rigida - Stiff Goldenrod Verbena hastata - Blue Vervain Vernonia fasciculata - Ironweed Veronicastrum virginicum - Culver's Root Zizia aurea - Golden Alexanders

Grasses, Sedges & Rushes Andropogon gerardii - Big Bluestem Carex comosa - Bottlebrush Sedge Carex hystericina - Porcupine Sedge Carex stipata - Awl Fruited Sedge Carex vulpinoidea - Fox Sedge Elymus canadensis - Canada Wild Rye Elymus virginicus - Virginia Wild Rye Panicum virgatum - Switchgrass Scirpus atrovirens - Dark Green Bulrush Sorghastrum nutans - Indiangrass Spartina pectinata - Prairie Cordgrass Lolium multiflorum - Annual Rye Nurse Crop

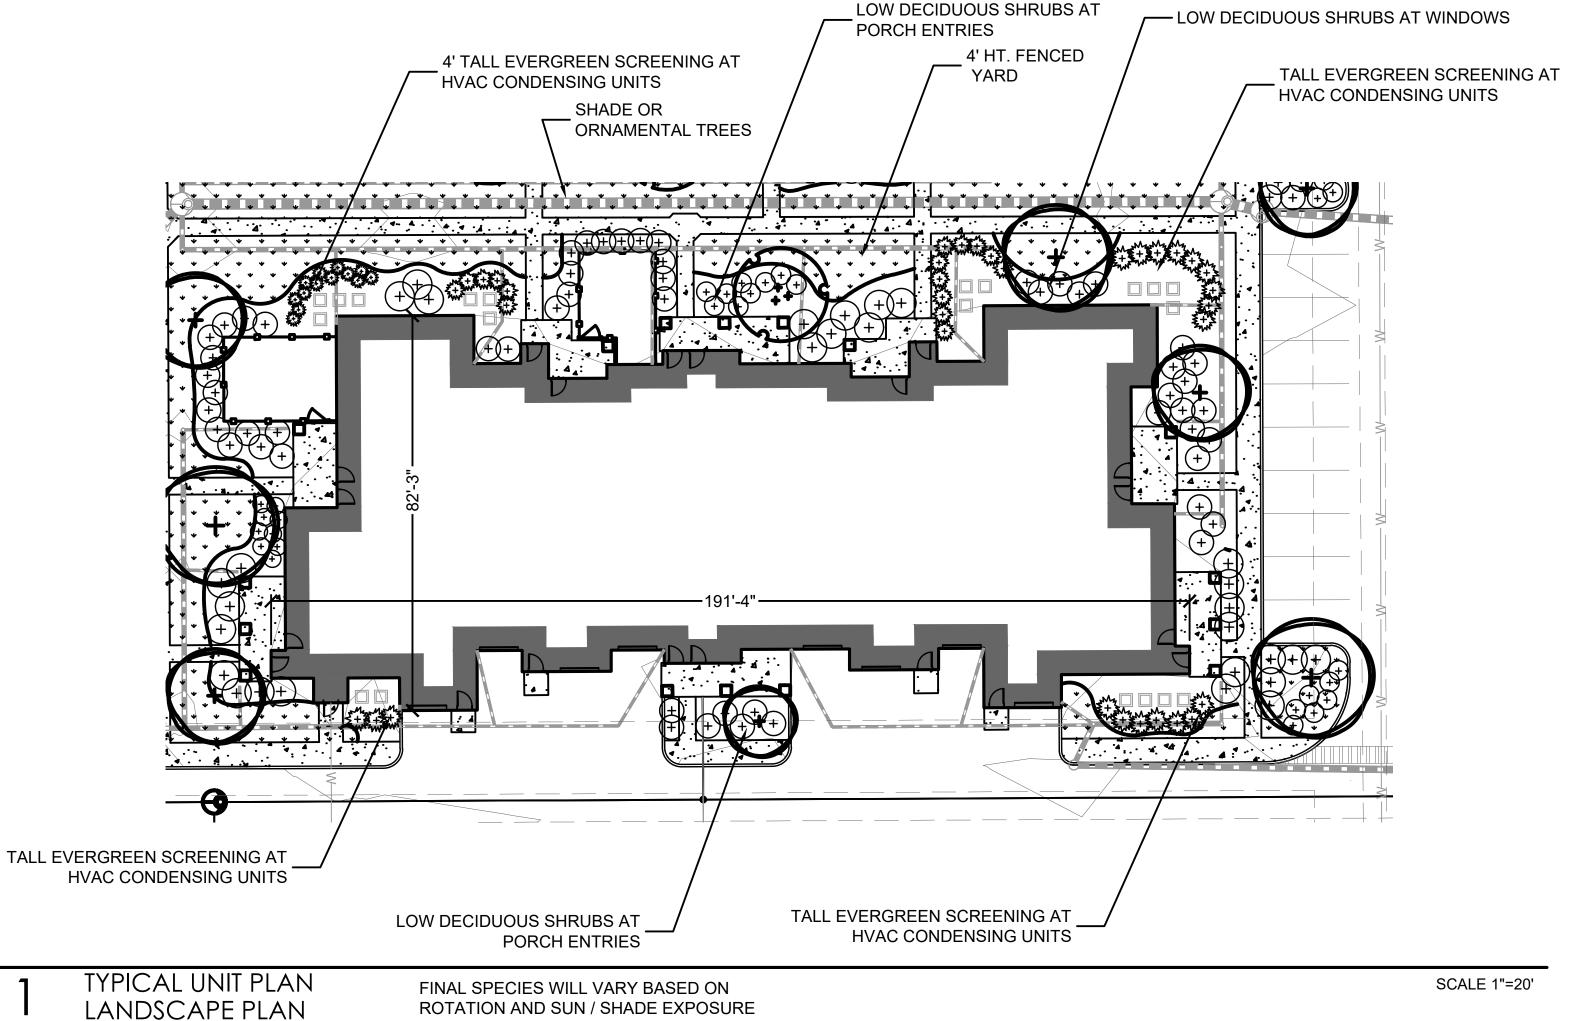





PROJECT TEAM

CIVIL ENGINEER:



DEVELOPER / OWNER INFORMATION Continental 834 Fund, LLC, a Delaware limited liability co.
MPANY: By: Continental Properties Company, Inc., a Wisconsin corporation, its manager \DDRESS: W134 N8675 Executive Parkway STATE: WI ZIP: 53051 IONE:_708-368-6160 E-MAIL(If Any): jpatton@cproperties.com

PROJECT NAME

LANDSCAPE PLAN

SPRINGS AT AURORA

-MATERIAL VARIES. MULCH / LANDSCAPING, ETC. -FOLD TURF SYSTEM OVER 1" X 6" BENDER BOARD SLOPE -INFILLED SYNTHETIC TURF SYSTEM - EZTEE HYBRID FREE DRAINING FINISHING 1380 & 1444 N. Orchard Rd, STONE, LASER GRADE THOROUGHLY COMPACT MATERIAL AT EDGE FREE DRAINING BASE

STONE

GEOTEXTILE FABRIC COMPACTED-SUBGRADE

SYNTHETIC TURF @ NORTH

PET PLAYGROUND

BENDER BOARD DETAIL

DRAIN

AMERICAN GREEN 6960 Competition Dr, Bettendorf, IA 52807 TOLL FREE: (877) 408-3636

www.American-Green.com

SCALE: NTS

Aurora, Il 60506

DRAWING ISSUED DATE NO. TITLE 1. For Approval 06/06/25 2. Per City Comments 07/10/25


SET TYPE LANDSCAPE PLANS

PROJECT NUMBER 2408046

DATE 08-23-2025 DRAWN BY: APPROVED BY: SHEET TITLE TYPICAL UNIT PLAN / SEED

SHEET NUMBER

MIXES

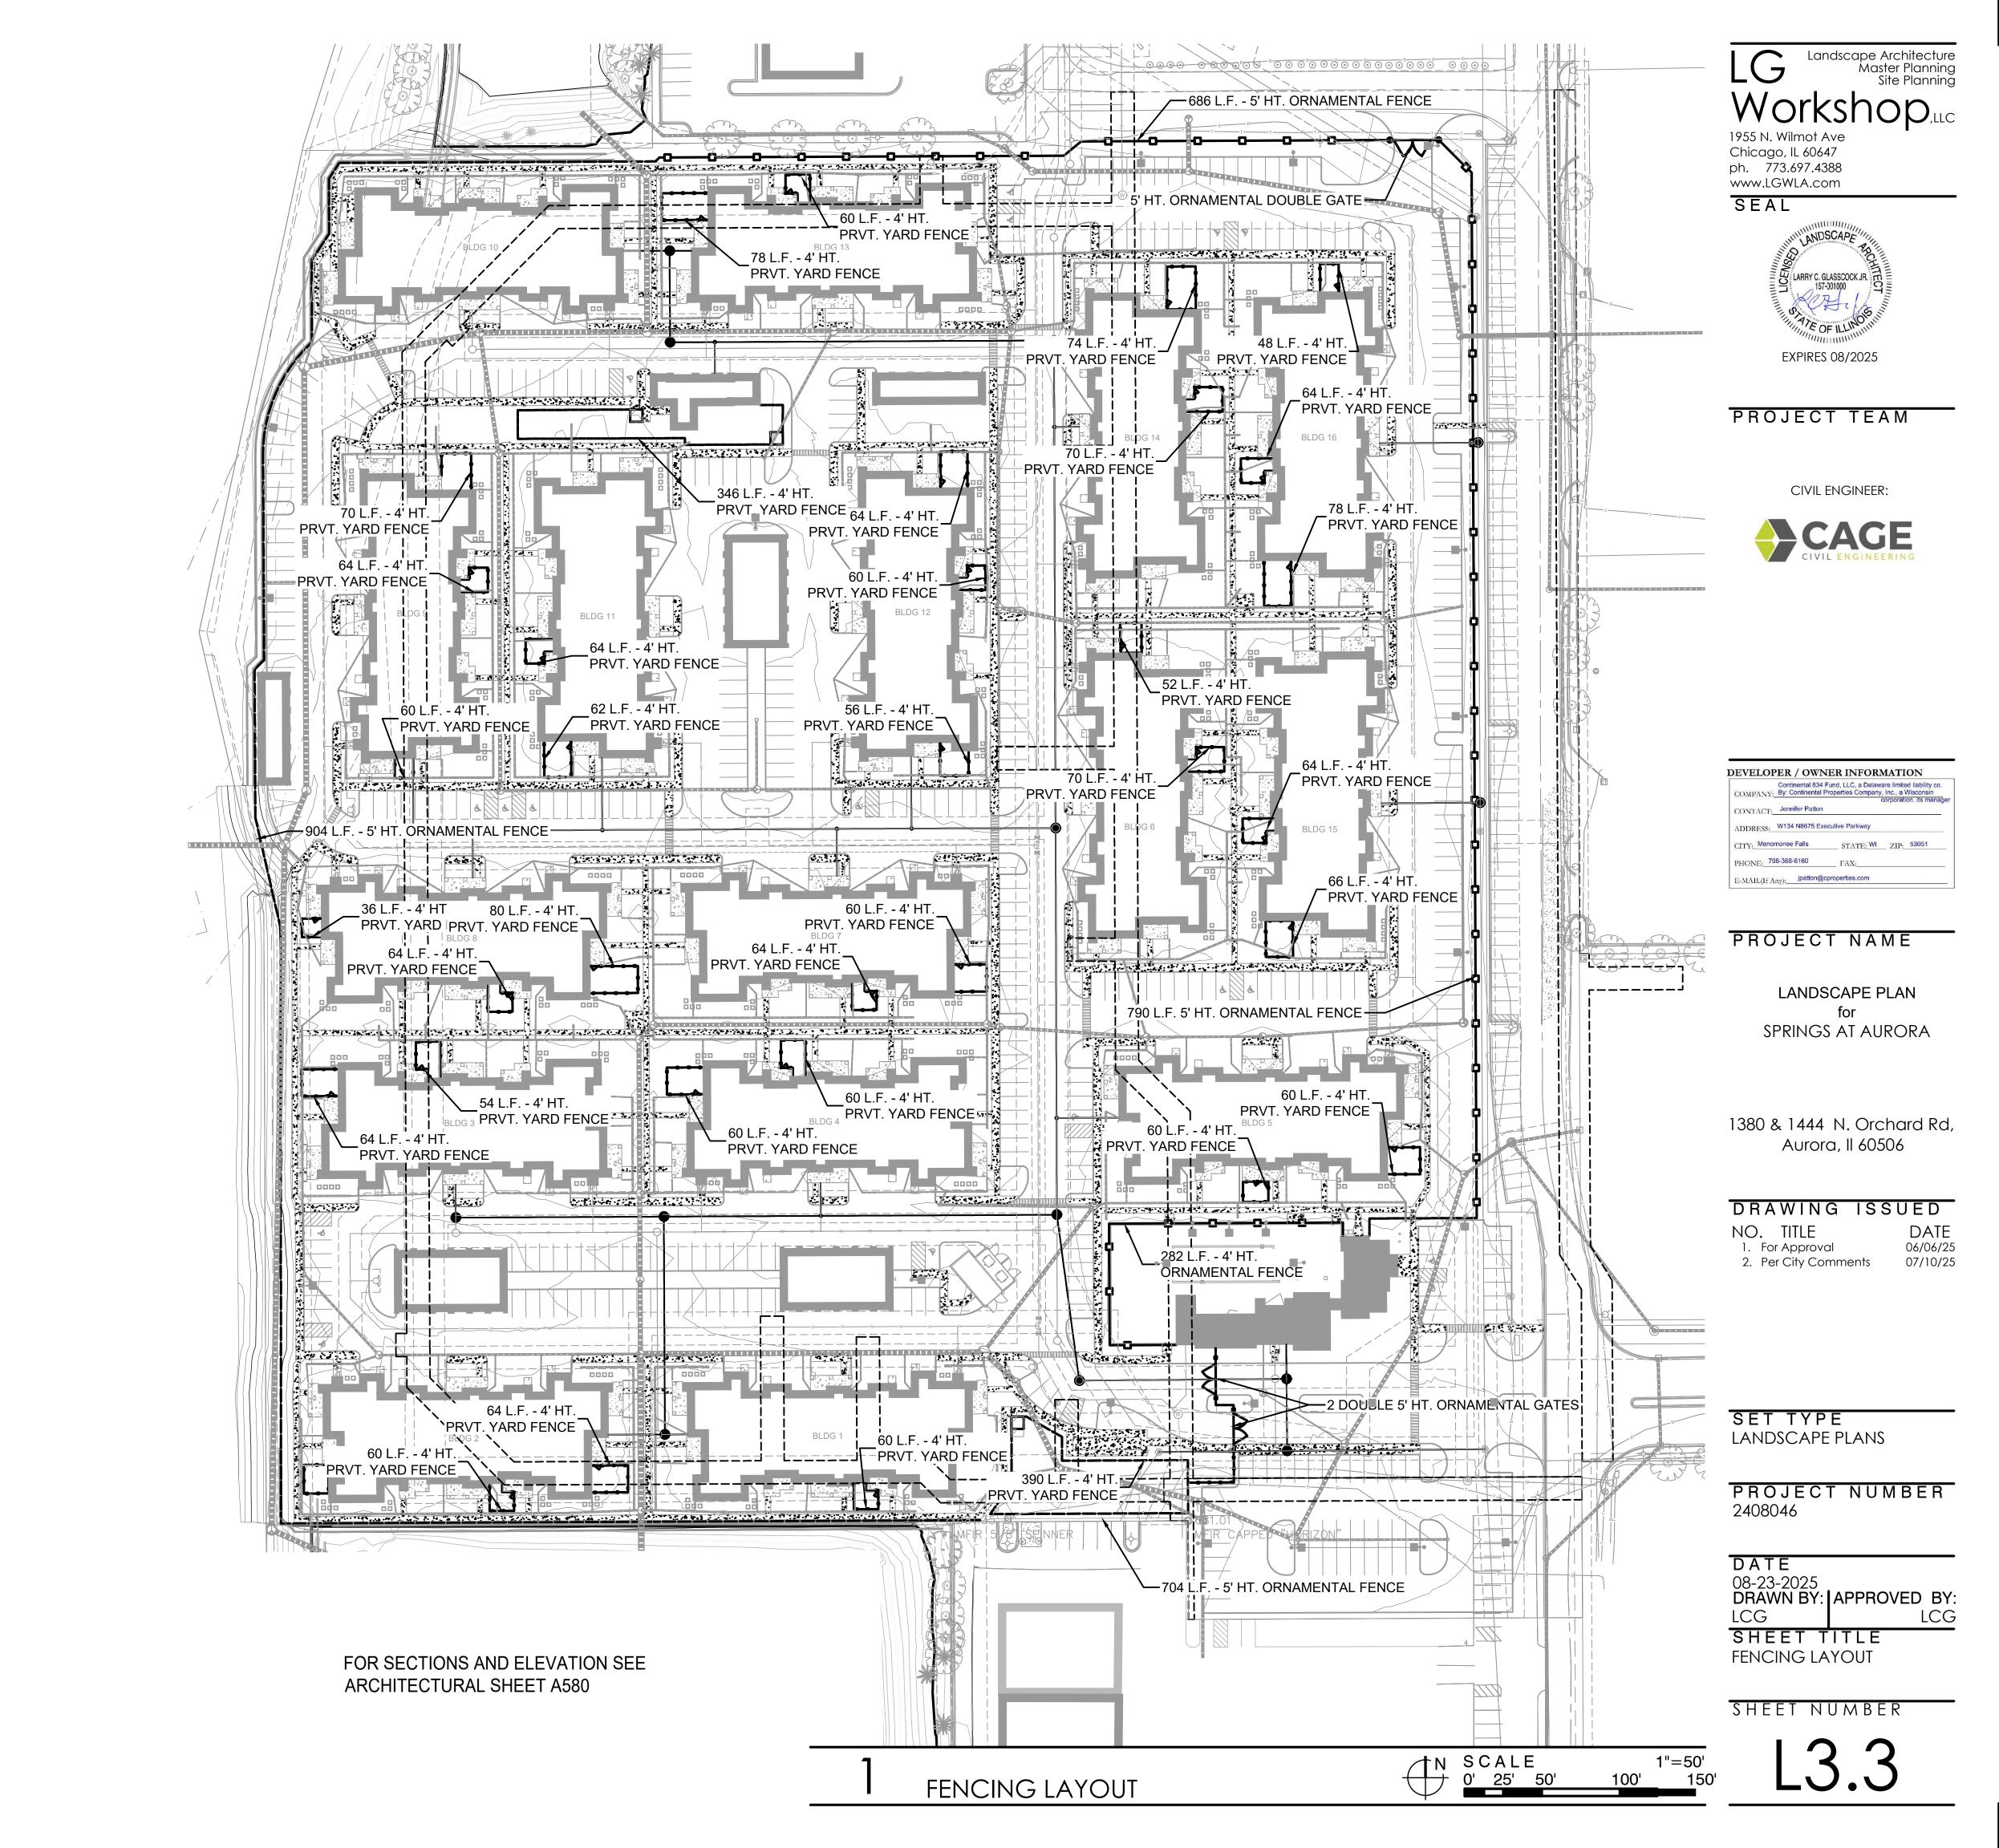

THE CONTRACTOR SHALL INCLUDE AS PART OF THE LANDSCAPE BID, MAINTENANCE FOR A PERIOD OF 6 WEEKS AFTER FINAL ACCEPTANCE OF THE LANDSCAPING INSTALLATION. THE CONTRACTOR MUST BE ABLE TO PROVIDE CONTINUED MAINTENANCE IF REQUESTED BY THE OWNER OR PROVIDE THE NAME OF A REPUTABLE LANDSCAPE CONTRACTOR WHO CAN PROVIDE MAINTENANCE. THE CONTRACTOR SHALL INCLUDE INITIAL 6 WEEK WATERING PROGRAM AFTER INSTALLATION TO SUPPLEMENT RAINFALL. TEMPORARY IRRIGATION OR WATERING ON-SITE. WATER PROVIDED.

STANDARDS

- 1. ALL LANDSCAPE MAINTENANCE SERVICES SHALL BE PERFORMED BY TRAINED PERSONNEL USING CURRENT. ACCEPTABLE HORTICULTURAL PRACTICES
- ALL WORK SHALL BE PERFORMED IN A MANNER THAT MAINTAINS THE ORIGINAL
- INTENT OF THE LANDSCAPE DESIGN 3. ALL CHEMICAL APPLICATIONS SHALL BE PERFORMED IN ACCORDANCE WITH CURRENT COUNTY, STATE AND FEDERAL LAWS. USING EPA REGISTERED MATERIALS AND METHODS OF APPLICATION. THESE APPLICATIONS SHALL BE PERFORMED UNDER THE SUPERVISION OF A LICENSED CERTIFIED APPLICATOR.

APPROVALS

- ANY WORK PERFORMED IN ADDITION TO THAT WHICH IS OUTLINED IN THE CONTRACT SHALL ONLY BE DONE UPON WRITTEN APPROVAL BY THE OWNER'S REPRESENTATIVE. **SOIL TESTING**
- 1. THE MAINTENANCE CONTRACTOR SHALL PERFORM SOIL TESTS AS NEEDED TO IDENTIFY ANY IMBALANCES OR DEFICIENCIES CAUSING PLANT MATERIAL DECLINE. THE OWNER SHALL BE NOTIFIED OF THE RECOMMENDATION FOR APPROVAL, AND THE NECESSARY CORRECTIONS MADE AT AN ADDITIONAL COST TO THE OWNER.

ACCEPTABLE SOIL TEST RESULTS:

WITH LEVELS NOT TO EXCEED:

	LANDSCAPE TREES & SHRUBS	TURF
PH RANGE	5.0-7.0	6.0-7.0
ORGANIC MATTER	>1.5%	>2.5%
MAGNESIUM (MG)	100+LBS./ACRE	100+LBS./ACRE
PHOSPHORUS (P2O5)	150+LBS./ACRE	150+LBS./ACRE
POTASSIUM (K2O)	120+LBS./ACRE	120+LBS./ACRE
SOLUBLE SALTS	NOT TO EXCEED 900PPM/1.9 MMHOS/CM	NOT TO EXCEED
750PPM/0.75 MMHOS/0	CM	
	IN SOIL: NOT TO EXCEED 1400 PPM/2.5	IN SOIL: NOT TO

EXCEED 2000 PPM/2.0

MMHOS/CM IN HIGH ORGANIC MIX ORGANIC MIX

FOR UNUSUAL SOIL CONDITIONS, THE FOLLOWING OPTIONAL TESTS ARE RECOMMENDED

BORON 3 POUNDS PER ACRE **MANGANESE** 50 POUNDS PER ACRE 450 POUNDS PER ACRE POTASSIUM (K2O) SODIUM 20 POUNDS PER ACRE

WORKMANSHIP

- DURING LANDSCAPE MAINTENANCE OPERATIONS. ALL AREAS SHALL BE KEPT NEAT AND CLEAN. PRECAUTIONS SHALL BE TAKEN TO AVOID DAMAGE TO EXISTING STRUCTURES. ALL WORK SHALL BE PERFORMED IN A SAFE MANNER TO THE OPERATORS, THE OCCUPANTS AND ANY PEDESTRIANS.
- 2. UPON COMPLETION OF MAINTENANCE OPERATIONS, ALL DEBRIS AND WASTE MATERIAL SHALL BE CLEANED UP AND REMOVED FROM THE SITE, UNLESS PROVISIONS HAVE BEEN GRANTED BY THE OWNER TO USE ON-SITE TRASH RECEPTACLES. ANY DAMAGE TO THE LANDSCAPE, STRUCTURES, OR IRRIGATION SYSTEMS CAUSED BY THE MAINTENANCE CONTRACTOR. SHALL BE REPAIRED BY THE MAINTENANCE CONTRACTOR WITHOUT CHARGE TO THE OWNER.

GENERAL CLEAN UP PRIOR TO MOWING, ALL TRASH, STICKS, AND OTHER UNWANTED DEBRIS SHALL BE REMOVED FROM LAWNS, PLANT BEDS, AND PAVED AREAS.

TURF GRASSES, INCLUDING BLUE GRASS, TALL FESCUE, PERENNIAL RYEGRASS, ETC., SHALL BE MAINTAINED AT A HEIGHT OF 2" TO 3" IN SPRING AND FALL, FROM JUNE THROUGH SEPTEMBER. MOWING HEIGHT SHALL BE MAINTAINED AT NO LESS THAN 3".

THE MOWING OPERATION INCLUDES TRIMMING AROUND ALL OBSTACLES, RAKING EXCESSIVE GRASS CLIPPINGS AND REMOVING DEBRIS FROM WALKS, CURBS, AND PARKING AREAS. CAUTION: MECHANICAL WEEDERS SHOULD NOT BE USED AROUND TREES BECAUSE OF POTENTIAL DAMAGE TO THE BARK.

EDGING OF ALL SIDEWALKS, CURBS AND OTHER PAVED AREAS SHALL BE PERFORMED ONCE EVERY OTHER MOWING. DEBRIS FROM THE EDGING OPERATIONS SHALL BE REMOVED AND THE AREAS SWEPT CLEAN. CAUTION SHALL BE USED TO AVOID FLYING DEBRIS.

FERTILIZING

SEASONALLY STEPPED FERTILIZER SHALL BE APPLIED IN AREAS BASED ON THE EXISTING SPECIES. TURF

LAWN WEED CONTROL: HERBICIDES

SELECTION AND PROPER USE OF HERBICIDES SHALL BE THE LANDSCAPE CONTRACTOR'S RESPONSIBILITY. ALL CHEMICAL APPLICATIONS SHALL BE PERFORMED UNDER THE SUPERVISION OF A LICENSED CERTIFIED APPLICATOR. READ THE LABEL PRIOR TO APPLYING ANY CHEMICAL.

INSECT & DISEASE CONTROL FOR TURF

THE CONTRACTOR SHALL BE RESPONSIBLE FOR MONITORING THE SITE CONDITIONS ON EACH VISIT TO DETERMINE IF ANY INSECT PEST OR DISEASE PROBLEMS EXIST. THE CONTRACTOR SHALL IDENTIFY THE INSECT PEST OR DISEASE, AS WELL AS THE HOST PLANT AND THEN CONSULT THE MOST CURRENT EDITION OF THE COOPERATIVE EXTENSION SERVICE'S "COMMERCIAL INSECTICIDE RECOMMENDATION FOR TURF" FOR CONTROL. THE LICENSED APPLICATOR SHALL BE FAMILIAR WITH THE LABEL PROVIDED FOR THE SELECTED PRODUCT PRIOR TO APPLICATION.

INSPECTION AND TREATMENT TO CONTROL INSECT PESTS SHALL BE INCLUDED IN THE CONTRACT PRICE

PRUNING

ALL ORNAMENTAL TREES, SHRUBS AND GROUND COVER SHALL BE PRUNED WHEN APPROPRIATE TO REMOVE DEAD OR DAMAGED BRANCHES, DEVELOP THE NATURAL SHAPES. DO NOT SHEAR TREES OR SHRUBS. IF PREVIOUS MAINTENANCE PRACTICE HAS BEEN TO SHEAR AND BALL. THEN A NATURAL SHAPE WILL BE RESTORED GRADUALLY.

PRUNING GUIDELINES

- 1. PRUNE PLANTS THAT FLOWER BEFORE THE END OF JUNE (SPRING BLOOMING) IMMEDIATELY AFTER FLOWERING FLOWER BUDS DEVELOP DURING THE PREVIOUS GROWING SEASON. FALL, WINTER OR SPRING PRUNING WOULD REDUCE THE SPRING FLOWERING DISPLAY.
- 2. PRUNE PLANTS THAT FLOWER IN JULY SEPTEMBER (SUMMER OR AUTUMN BLOOMING) IN WINTER OR SPRING BEFORE NEW GROWTH BEGINS, SINCE THESE PLANTS DEVELOP FLOWERS ON NEW GROWTH
- 3. DELAY PRUNING PLANTS GROWN FOR ORNAMENTAL FRUITS, SUCH AS COTONEASTERS AND VIBURNUMS
- 4. HOLLIES AND OTHER EVERGREENS MAY BE PRUNED DURING WINTER IN ORDER TO USE THEIR BRANCHES FOR SEASONAL DECORATION. HOWEVER, SEVERE PRUNING OF EVERGREENS SHOULD BE DONE IN EARLY SPRING ONLY.
- 5. BROADLEAF EVERGREEN SHRUBS SHALL BE HAND-PRUNED TO MAINTAIN THEIR NATURAL APPEARANCE AFTER THE NEW GROWTH HARDENS OFF.
- 6. HEDGES OR SHRUBS THAT REQUIRE SHEARING TO MAINTAIN A FORMAL APPEARANCE SHALL BE PRUNED AS REQUIRED. DEAD WOOD SHALL BE REMOVED FROM SHEARED PLANTS BEFORE THE FIRST SHEARING OF THE
- 7. CONIFERS SHALL BE PRUNED, IF REQUIRED, ACCORDING TO THEIR GENUS.
- A. YEWS, JUNIPERS, HEMLOCKS AND ARBORVITAE MAY BE PRUNED AFTER NEW GROWTH HAS HARDENED OFF IN LATE SUMMER. IF SEVERE PRUNING IS NECESSARY, IT MUST BE DONE IN EARLY SPRING. B. FIRS AND SPRUCES MAY BE LIGHTLY PRUNED IN LATE SUMMER. FALL. OR WINTER AFTER COMPLETING GROWTH.
- LEAVE SIDE BUDS. NEVER CUT CENTRAL LEADER
- C. PINES MAY BE LIGHTLY PRUNED IN EARLY JUNE BY REDUCING CANDLES RENEWAL PRUNING: REMOVE OLDEST BRANCHES OF SHRUB AT GROUND. LEAVING THE YOUNGER. MORE
- VIGOROUS BRANCHES. ALSO REMOVE WEAK STEMS. ON OVERGROWN PLANTS. THIS METHOD MAY BE BEST DONE OVER A THREE-YEAR PERIOD. RENEWAL PRUNING MAY BE USED ON FORSYTHIA, HYDRANGEA, SPIRAEA, ETC.

PLANTS OVERHANGING PASSAGEWAYS AND PARKING AREAS AND DAMAGED PLANTS SHALL BE PRUNED AS NEEDED.

SHADE TREES THAT CANNOT BE ADEQUATELY PRUNED FROM THE GROUND SHALL NOT BE INCLUDED IN THE MAINTENANCE CONTRACT. A CERTIFIED ARBORIST UNDER A SEPARATE CONTRACT SHALL PERFORM THIS TYPE OF WORK.

SPRING CLEANUP

1.4.

TILLED.

1. BROADCASTING

ACTIONS.

1.4.

IN HEIGHT.

GRANTED.

2. FOLLOW THE APPROPRIATE TIMING:

METHOD FOR SEEDING AND EROSION CONTROL

SEED MORE THAN 1/4-INCH DEEP.

PLANT MATERIAL MANAGEMENT - NATIVE SEEDING - 3-YEAR PERIOD

JANUARY - PREFERABLY BEFORE APRIL 15.

NATIVE AREAS NEED BETWEEN 3 TO 5 YEARS TO ESTABLISH.

KEEP GROWTH DOWN. DO NOT ALLOW SEED HEADS TO FORM

SOME PERENNIAL SEEDS MAY NOT GERMINATE UNTIL THE FOLLOWING YEAR.

SECOND SEASON: MOW 3-4 TIMES TO MAINTAIN 8-10 INCHES IN HEIGHT.

MARCH 1 - MAY 1

2. EROSION CONTROL METHOD

GERMINATED.

NATIVE PLANT & SEED INSTALLATION

PLANT MATERIAL INSTALLATION - NATIVE SEEDING

DISTURBING ANY GROUND:

CHECK FOR ANY BURIED UTILITIES

MANAGEMENT AND MONITORING PLAN

MANAGEMENT AND MONITORING OF ALL NATIVE AREAS FOR A PERIOD OF 3 YEARS.

CLEAR AREA OF DEBRIS THAT WOULD INTERFERE WITH PLANTING

USING A NO-TILL SEED DRILL, TILLING CAN USUALLY BE OMITTED.

MOW ANY EXCESS EXISTING VEGETATION GROWTH

DE-COMPACT ANY AREAS OF SPECIAL CONCERN

MMHOS/CM IN HIGH

PLANT BEDS SHALL RECEIVE A GENERAL CLEANUP BEFORE FERTILIZING AND MULCHING. CLEANUP INCLUDES REMOVING WINTER CLEAN-UP DEBRIS AND TRASH FROM BEDS AND CUTTING BACK HERBACEOUS PERENNIALS LEFT STANDING THROUGH WINTER, E.G. THE PROJECT SHALL RECEIVE A GENERAL CLEAN-UP ONCE DURING EACH OF THE WINTER MONTHS, I.E., JANUARY, ORNAMENTAL GRASSES, SEDUM AUTUMN JOY **FERTILIZING**

- 1. FOR TREES, THE RATE OF FERTILIZATION DEPENDS ON THE TREE SPECIES, TREE VIGOR, AREA AVAILABLE FOR FERTILIZATION, AND GROWTH STAGE OF THE TREE. MATURE SPECIMENS BENEFIT FROM FERTILIZATION EVERY 3 TO • 4 YEARS: YOUNGER TREES SHALL BE FERTILIZED MORE OFTEN DURING RAPID GROWTH STAGES
- 2. THE CURRENT RECOMMENDATION IS BASED ON THE RATE OF 1000 SQUARE FEET OF AREA UNDER THE TREE TO BE FERTILIZED. FOR DECIDUOUS TREES, 2 TO 6 POUNDS OF NITROGEN PER 1000 SQUARE FEET; FOR NARROW-LEAF EVERGREENS, 1 TO 4 POUNDS OF NITROGEN PER 1000 SQUARE FEET; FOR BROADLEAF EVERGREENS, 1 TO 3 POUNDS OF NITROGEN PER 1000 SQUARE FEET

NATIVE PLANTING AND SEEDING INSTALLATION, MANAGEMENT AND MONITORING TO BE CONDUCTED BY A QUALIFIED

EXPERIENCED CONTRACTOR SPECIALIZING IN RESTORING AND MANAGING NATURAL LANDSCAPES IN THE MIDWEST.

THE SELECTED CONTRACTOR IS TO BE HELD ACCOUNTABLE FOR THE APPROPRIATE INSTALLATION METHODS AND

1. PREPARE AREA FOR SEEDING - PREPARE THE SOIL AND CREATE OPTIMAL PLANT CONDITIONS, BEFORE

APPLY BROAD-SPECTRUM OR TARGETED HERBICIDE, DEPENDING ON SPECIES PRESENT

LIGHTLY DE-COMPACT TILLED OR LOOSE SOIL WITH A ROLLER, CULTIPACKER, OR SIMILAR EQUIPMENT. IF

IF GROUND IS WET, TILLING SHOULD NOT OCCUR UNTIL THE SOIL DRIES ENOUGH TO BREAK APART WHEN

2.1. THE OPTIMAL TIME TO INSTALL SEED IS FROM THE SEPTEMBER 1 - NOVEMBER 15. SECONDARY SEASON

1.1. USING A HAND-CRANK OR TOW-BEHIND BROADCASTER, START WITH HALF OF THE SEED AND TRY TO COVER

2.1. O INSTALL BIODEGRADABLE EROSION CONTROL BLANKET (NAG S75BN OR EQUAL) UNTIL SEED HAS

1. TO HELP ENSURE SUCCESS, PROJECTS NEED A MAINTENANCE AND MONITORING PLAN THAT IS FLEXIBLE AND

SUPPORTS SITE DEVELOPMENT GOALS. WHILE NATIVE PLANTS TEND TO GERMINATE AND DEVELOP AT A SLOWER

PERIOD GREATLY IMPROVES PROJECT SUCCESS. REGULAR MAINTENANCE AND MONITORING CONTROLS INVASIVE

SPECIES, ENSURES OPTIMAL MOISTURE LEVELS ARE PRESENT, AND IDENTIFIES OTHER NECESSARY MANAGEMENT

LET SEED GERMINATE AND GROW FOR ONE FULL SEASON. DO NOT APPLY HERBICIDES FOR WEED CONTROL

MOW FIRST TIME WHEN ESTABLISHED IN FIRST SEASON TO 12"-18" HIGH, TO SCATTER SEED HEADS. IF

WITHIN THE FIRST GROWING SEASON. IF LARGE WEEDS ARE UNSIGHTLY, CLIP OFF; DO NOT PULL WEEDS TO

CLUMPING OCCURS LIGHTLY RAKE TO DISBURSE SEED. MOW 2-3 ADDITIONAL TIMES TO MAINTAIN 6-9 INCHES

IF FALL PLANTING IS NOT POSSIBLE, SPRING SEEDING CAN BE DONE (WEATHER PERMITTING) AS EARLY AS

4 (FOUR) ANNUAL WEED CONTROL EVENTS (SELECTIVE HERBICIDE AND MECHANICAL) TO BE PERFORMED

THROUGHOUT ALL NATIVE PLAN COMMUNITIES STARTING ONCE THE SEED IS SOWN UNTIL SIGN-OFF IS

RATE THAN ORNAMENTAL PERENNIALS OR TURF GRASS, REGULAR MAINTENANCE DURING THE ESTABLISHMENT

THE ENTIRE AREA WITH THAT AMOUNT OF SEED. TAKE THE REMAINING HALF OF THE SEED, GO TO THE

OPPOSITE END OF THE SITE AND COVER IT AGAIN. AFTER BROADCASTING IS COMPLETE, IT IS IMPORTANT TO

USE A CULTIPACKER OR ROLLER OVER THE AREA TO MAKE GOOD SEED-TO-SOIL CONTACT. DO NOT COVER

- 3. SHRUBS AND GROUNDCOVER SHALL BE TOP-DRESSED WITH COMPOST 1" DEEP OR FERTILIZED ONCE IN MARCH WITH 10-6-4 ANALYSIS FERTILIZER AT THE RATE OF 3 POUNDS PER 100 SQUARE FEET OF BED AREA
- 4. ERICACEOUS MATERIAL SHALL BE FERTILIZED WITH AN ERICACEOUS FERTILIZER AT THE MANUFACTURER'S RECOMMENDATION RATE. IF PLANTS ARE GROWING POORLY. A SOIL SAMPLE SHOULD BE TAKEN.

MULCHING

ANNUALLY, ALL TREE AND SHRUB BEDS WILL BE PREPARED AND MULCHED, TO A MINIMUM DEPTH OF 3" WITH QUALITY MULCH TO MATCH EXISTING. BED PREPARATION SHALL INCLUDE REMOVING ALL WEEDS, CLEANING UP SAID BED, EDGING AND CULTIVATING DECAYED MULCH INTO THE SOIL. DEBRIS FROM EDGING IS TO BE REMOVED FROM BEDS WHERE APPLICABLE. IF DEEMED NECESSARY, A PRE-EMERGENT HERBICIDE MAY BE APPLIED TO THE SOIL TO INHIBIT THE GROWTH OF FUTURE WEEDS.

WEEDING ALL BEDS SHALL BE WEEDED ON A CONTINUOUS BASIS THROUGHOUT THE GROWING SEASON TO MAINTAIN A NEAT APPEARANCE AT ALL TIMES

PRE-EMERGENT (SOIL-APPLIED) AND POST-EMERGENT (FOLIAR-APPLIED) HERBICIDES SHALL BE USED WHERE AND WHEN APPLICABLE AND IN ACCORDANCE WITH THE PRODUCT'S LABEL

INSECT & DISEASE CONTROL: TREES, SHRUBS & GROUNDCOVER

- 1. THE MAINTENANCE CONTRACTOR SHALL BE RESPONSIBLE FOR MONITORING THE LANDSCAPE SITE ON A REGULAR BASIS. THE MONITORING FREQUENCY SHALL BE MONTHLY EXCEPT FOR GROWING SEASON, WHICH WILL BE EVERY OTHER WEEK. TRAINED PERSONNEL SHALL MONITOR FOR PLANT DAMAGING INSECT ACTIVITY, PLANT PATHOGENIC DISEASES AND POTENTIAL CULTURAL PROBLEMS IN THE LANDSCAPE. THE PEST OR CULTURAL PROBLEM WILL BE IDENTIFIED UNDER THE SUPERVISION OF THE CONTRACTOR
- 2. FOR PLANT DAMAGING INSECTS AND MITES IDENTIFIED IN THE LANDSCAPE, THE CONTRACTOR SHALL CONSULT AND FOLLOW THE RECOMMENDATIONS OF THE MOST CURRENT EDITION OF THE STATE COOPERATIVE SERVICE PUBLICATION ON INSECT CONTROL ON LANDSCAPE PLANT MATERIAL
- 3. PLANT PATHOGENIC DISEASE PROBLEMS IDENTIFIED BY THE CONTRACTOR THAT CAN BE RESOLVED BY PRUNING OR PHYSICAL REMOVAL OF DAMAGED PLANT PARTS WILL BE PERFORMED AS PART OF THE CONTRACT. FOR AN ADDITIONAL CHARGE, PLANT PATHOGENIC DISEASES THAT CAN BE RESOLVED
- 4. THROUGH PROPERLY TIMED APPLICATIONS OF FUNGICIDES SHALL BE MADE WHEN THE OWNER AUTHORIZES IT. IF THE CONTRACTOR NOTES AN ESPECIALLY INSECT-OR DISEASE-PRONE PLANT SPECIES IN THE LANDSCAPE, HE/SHE WILL SUGGEST REPLACEMENT WITH A MORE PEST-RESISTANT CULTIVAR OR SPECIES THAT IS CONSISTENT WITH THE INTENT OF THE LANDSCAPE DESIGN.

TRASH REMOVAL THE MAINTENANCE CONTRACTOR SHALL REMOVE TRASH FROM ALL SHRUB AND GROUNDCOVER BEDS WITH EACH VISIT LEAF REMOVAL

ALL FALLEN LEAVES SHALL BE REMOVED FROM THE SITE IN NOVEMBER AND ONCE IN DECEMBER. IF REQUESTED BY THE OWNER, THE MAINTENANCE CONTRACTOR, AT AN ADDITIONAL COST TO THE OWNER SHALL PERFORM SUPPLEMENTAL LEAF REMOVALS.

FEBRUARY, AND MARCH

CLEAN-UP INCLUDES:

- **CLEANING CURBS AND PARKING AREAS**
- REMOVING ALL TRASH AND UNWANTED DEBRIS
- INSPECTION OF GROUNDS

TURNING MULCH WHERE NECESSARY

PROJECT NAME

LANDSCAPE PLAN

SPRINGS AT AURORA

VELOPER / OWNER INFORMATION

Landscape Architecture

1955 N. Wilmot Ave

Chicago, IL 60647

ph. 773.697.4388

www.LGWLA.com

MANDSCAPE

LARRY C. GLASSCOCK JR. 5

EXPIRES 08/2025

PROJECT TEAM

CIVIL ENGINEER

SEAL

Master Plannina

Site Plannina

1380 & 1444 N. Orchard Rd. Aurora, II 60506

DRAWING ISSUED

DATE NO. TITLE 1. For Approval 06/06/25

VEGETATION (AS MEASURED BY AERIAL COVERAGE/OCULAR ESTIMATION), UNLESS SPECIFIED ON APPROVED SET TYPE

PROJECT NUMBER

2408046

LANDSCAPE PLANS

DATE 08-23-2025 DRAWN BY: APPROVED BY: LCG SHEET TITLE

LANDSCAPE MAINTENANCE

SHEET NUMBER

MINIMUM PERFORMANCE STANDARDS AND MONITORING ACTIVITIES 1. NATIVE PLANT MATERIALS

- 1.1. PERFORMANCE STANDARDS ARE ESTABLISHED FOR ALL PROPOSED PROJECTS INVOLVING NATURALIZED AREAS SO THAT THE RELATIVE SUCCESS OF CREATION AND ENHANCEMENT EFFORTS MAY BE EVALUATED. IF THE PERFORMANCE STANDARDS ARE NOT ACHIEVED BY THE END OF THE THREE-YEAR MANAGEMENT AND MONITORING PROGRAM, ACCEPTANCE MEETINGS SHALL BE HELD TO DETERMINE THE FUTURE COURSE OF ACTION. IT IS LIKELY THAT IN SUCH A CASE THAT THE MAINTENANCE AND MONITORING PERIOD WILL BE **EXTENDED** NOTIFICATION - THE DEVELOPER SHALL NOTIFY MUNICIPALITY UPON COMPLETION OF PLANTINGS. 1.2.
- THE OWNER'S ENVIRONMENTAL SPECIALIST SHALL INSPECT THE PLANTINGS UPON COMPLETION OF ALL MAINTENANCE PROCEDURES AND NOTIFY VILLAGE OF THE REMEDIAL ACTIONS TAKEN
- 1.3. NATIVE AREAS ARE TO BE MONITORED FOR A MINIMUM OF 3 (THREE) YEARS FROM DATE OF INSTALLATION. MONITOR ALL NATIVE AREAS 2 (TWO) TIMES ANNUALLY AT A TIME OF YEAR WHEN PLANTS ARE EVIDENT AND IDENTIFIABLE VISITS SHOULD OCCUR AT SPACED INTERVALS THROUGHOUT THE GROWING SEASON.
- CONDUCT MONITORING VISITS UTILIZING SYSTEMATIC FIELD TECHNIQUES. TRAVERSE ENTIRE NATIVE AREA. DOCUMENT FLORA AND NOTE TOP 3 DOMINANT SPECIES.
- 1.4. WITHIN 3 MONTHS OF SEED INSTALLATION, AT LEAST 90% OF THE SEEDED AREAS ("SEED", "SLOPE", AND "BASIN" SEED MIX), AS MEASURED BY AERIAL COVERAGE, SHALL BE VEGETATED. A MINIMUM 70% VEGETATIVE COVERAGE SHALL BE MAINTAINED THROUGHOUT, AND AT THE END OF, THE THREE-YEAR PERIOD FOR THESE AREAS. THIS STANDARD DOES NOT APPLY TO THE EMERGENT ZONES. THE NATURALIZED AREAS SHALL NOT CONTAIN ANY RILLS GREATER THAN 4 INCHES WIDE AND 4 INCHES DEEP
- THROUGHOUT AT THE END OF THE THREE-YEAR PERIOD. AT THE END OF THE SECOND GROWING SEASON, 30% SEED MIX PRESENCE FOR THE "PRAIRIE SEED", AND
- "WETLAND" SEED MIXES SHALL BE ACHIEVED. AT THE END OF THE THIRD GROWING SEASON, 50% SEED MIX PRESENCE FOR THE LISTED SEED MIXES SHALL BE ACHIEVED. SEED MIX PRESENCE SHALL BE EVALUATED SEPARATELY FOR THESE THREE MIXES. 1.7. NO AREA OVER THE ENTIRE NATIVE PLANTED SITE GREATER THAN 1 SQUARE METER WILL BE DEVOID OF
- PLANS. THE NATIVE PLANTED AREAS WILL MEET THE FOLLOWING ANNUAL STANDARDS FOR THE PRESENCE OF
- NATIVE, NON-INVASIVE PERENNIAL SPECIES (AS MEASURED BY AERIAL COVERAGE/OCULAR ESTIMATION): YEAR 1 - 15%, YEAR 2 - 50%, YEAR 3 - 75%. THIS STANDARD TO BE MEASURED SEPARATELY FOR EACH SEED MIX ZONE.
- 1.8. AT THE END OF THE THIRD GROWING SEASON, NONE OF THE THREE MOST DOMINANT SPECIES WITHIN THE PLANTED AREAS WILL BE INVASIVE OR NON-NATIVE SPECIES AS INSPECTED ANNUALLY. THE PROJECT MANAGER WILL DETERMINE THE APPROPRIATE TARGET INVASIVE OR NON-NATIVE SPECIES. THEY WILL TYPICALLY INCLUDE, BUT ARE NOT LIMITED TO, THE FOLLOWING: RAGWEED (AMBROSIA SPP.), CATTAIL (TYPHA SPP.), REED CANARY GRASS (PHALARIS ARUNDINACEA), PURPLE LOOSESTRIFE (LYTHRUM SALICARIA), COMMON REED (PHRAGMITES AUSTRALIS), CANADIAN THISTLE (CIRSIUM ARVENSE), SANDBAR WILLOW (SALIX INTERIOR), KENTUCKY BLUE GRASS (POA PRATENSIS), YELLOW SWEET-CLOVER (MELILOTUS OFFICINALIS), TEASEL (DIPSACUS SPP.), JAPANESE-KNOTWEED (REYNOUTRIA JAPONICA), AND ASIAN BITTERSWEET (CELASTRUS ORBICULATUS), BUCKTHORN (RHAMNUS SPP.).
- SEED: AT THE END OF THE THIRD GROWING SEASON, 50% VEGETATIVE COVERAGE SHALL BE ACHIEVED (AS MEASURED BY AERIAL COVERAGE/OCULAR ESTIMATION).
- RELATIVE COVERAGE (DETERMINED BY OCULAR ESTIMATION) OF INVASIVE SPECIES (I.E., COMMON REED, REED CANARY GRASS, PURPLE LOOSESTRIFE, ETC.) IN AGGREGATE SHALL BE LESS THAN 5% THROUGHOUT. AND AT THE END OF. THE THREE-YEAR PERIOD.
- 1.10.1. THIS STANDARD SHALL BE EVALUATED SEPARATELY FOR EACH SEED AND PLANT MIX ZONE. 1.11. NATIVE MEAN C VALUE > 3.0 AND NATIVE FQI VALUE > 20.0 FOR ALL NATIVE PLANT COMMUNITIES.
- 1.11.1. THIS STANDARD SHALL BE EVALUATED SEPARATELY FOR EACH SEED AND PLANT MIX ZONE 1.12. SOIL EROSION AND SEDIMENT CONTROL MEASURES SHALL BE REGULARLY MAINTAINED. ANY EROSION OBSERVED ON-SITE SHALL BE REPAIRED TO THE DESIGNED CONDITION WITHIN 30 DAYS OF OBSERVATION.