Final Landscape Plan

HEYDAY AURORA

Aurora, Illinois

May 23, 2025

CONSULTANTS:



LANDSCAPE ARCHITECT:

GARY R. WEBER ASSOCIATES, INC 402 W. LIBERTY DRIVE WHEATON, ILLINOIS 60187




CIVIL ENGINEER:

RWG ENGINEERING, LLC 975 E. 22ND ST., SUITE 400 WHEATON, IL 60189

ARCHITECT:

VOCON 3142 PROSPECT AVENUE E CLEVELAND, OH 44115

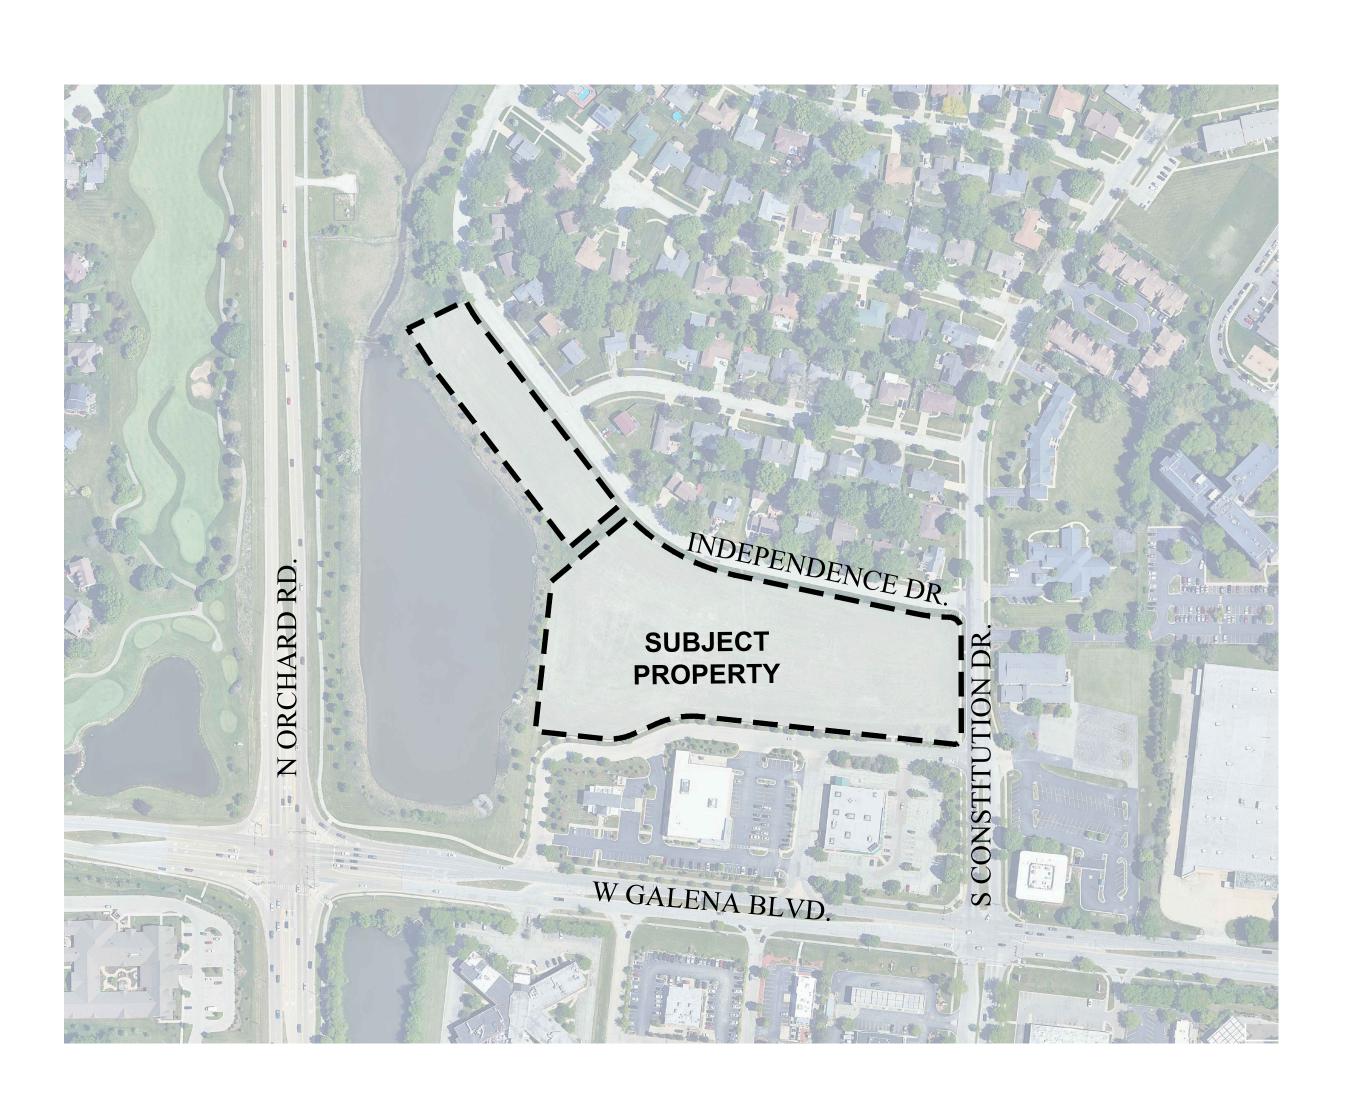


LOCATION MAP SCALE: 1"=200'

HEYDAY

INDEX OF SHEETS

SHEET NO.	DESCRIPTION
0	COVER SHEET
1	OVERALL LANDSCAPE PLAN
2	LANDSCAPE PLAN
3	LANDSCAPE PLAN
4	LANDSCAPE DETAILS
5	TYPICAL FOUNDATION LANDSCAPE PLANS
6	TYPICAL FOUNDATION LANDSCAPE PLANS
7	MONUMENT PLAN
8	SOD & SEED EXHIBIT
9	LANDSCAPE SPECIFICATIONS

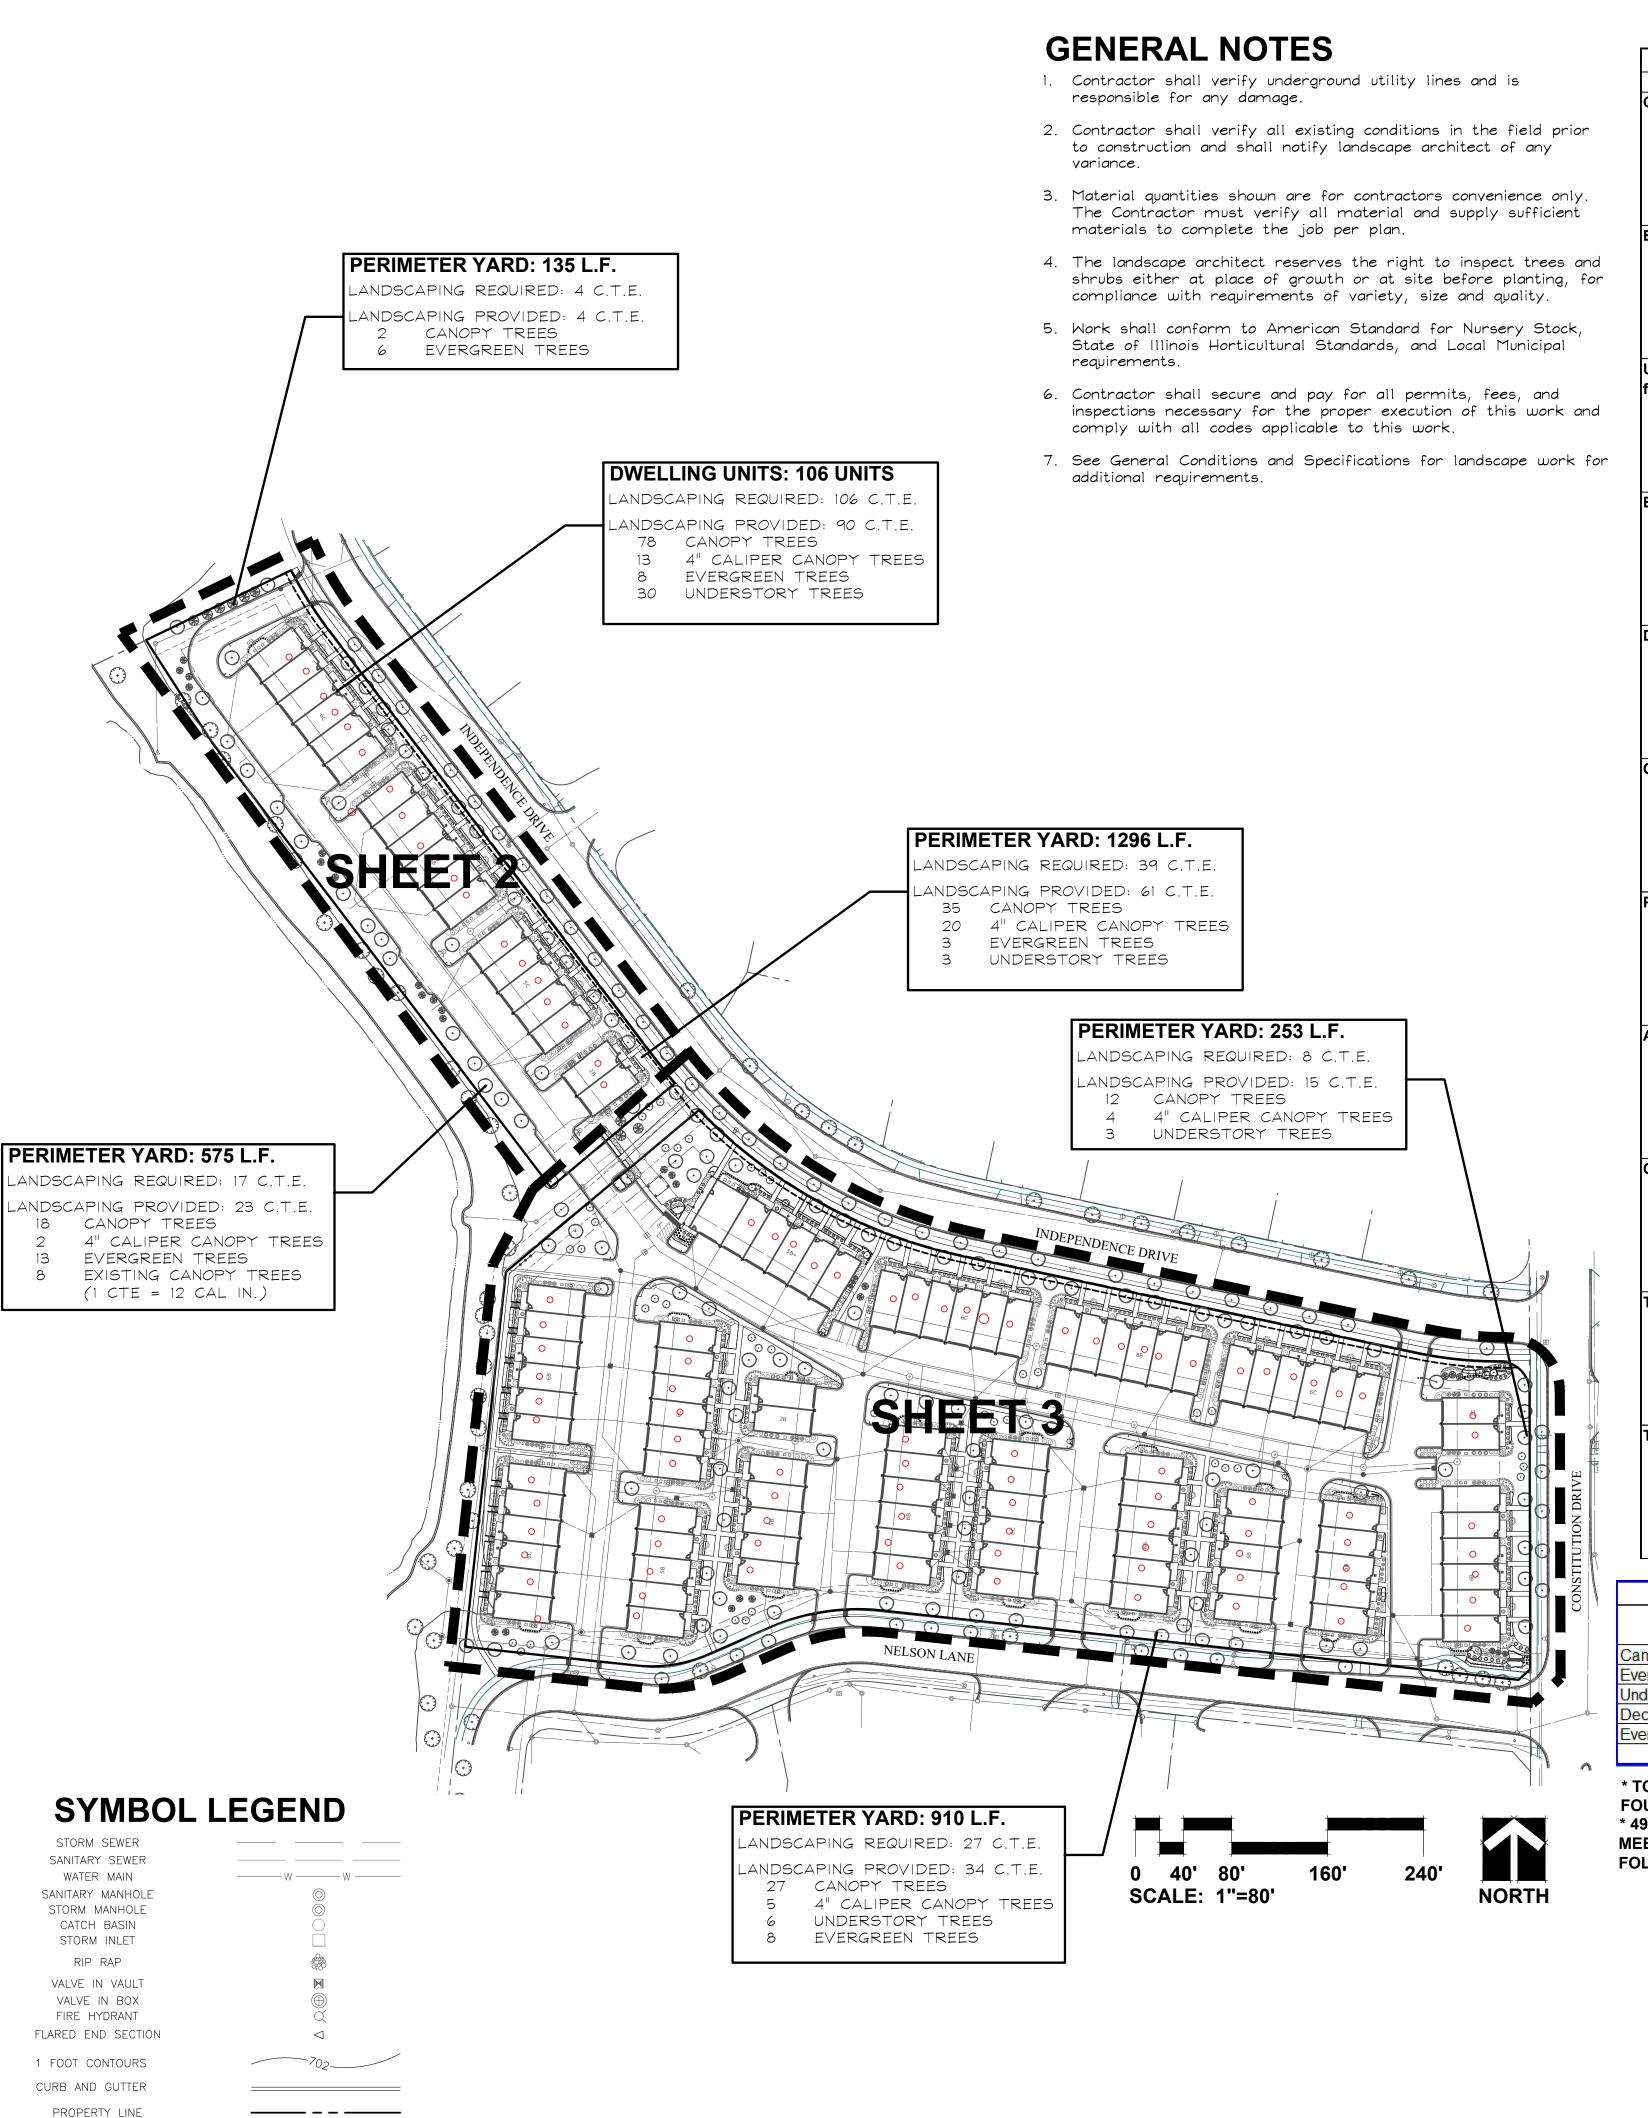

EASEMENT LINE

SETBACK LINE

Note: Symbols are blackline for proposed graysc	ale for exist
Canopy Trees (minimum size 2.5 caliper) Count:	173
Evergreen Trees (minimum size 6 feet) Count:	36
Understory Trees (minimum size 2.5 caliper or 8	114
feet if multi-stemed) Count:	
+)	
Evergreen Shrubs (minimum of 18 inches) Count:	561
	331
MANNA + MANNA	
Manual M	
Deciduous Shrubs (minimum of 18 inches) Count:	722
Ornamental Grasses Count:	687
Perennials Count:	1883
Annuals Count:	0
+ + + + + + + +	
+ + + + + + + + + + + + + + + + + + + +	
+ + + + + + + + + + + + + + + + + + + +	
[+ + + + + + + +]	
Groundcover Square Footage:	0
Turf (Seeded) Square Footage:	80,005
Turf (Sod) Square Footage:	19,719
Ψ Ψ Ψ Ψ Ψ Ψ	
\ \ \ \ \ \ \ \ \ \ \ \ \ \ \ \ \ \ \	
\(\frac{1}{\psi} \psi \psi \qq \qq \qq \qu	
<u> </u>	

\ '									
Landscape Data Table: CTEs Provided									
,		CTE Value	Count Provided	Total CTEs					
				Provided					
	Canopy Trees		173	173					
	Evergreen Trees		36	12					
	Understory Trees	1/3	114	38					
_	Deciduous Shrubs	1/20	722	36					
	Evergreen Shrubs	1/20	561	28					
		Total:	1606	287					

* TOTALS FOR LANDSCAPE DATA TABLES INCLUDES **FOUNDATION PLANTINGS**

* 49 OF CANOPY TREES ABOVE INCLUDE 4" CALIPER PER OU MEETING THIS EQUATES TO AN ADDITIONAL 29.4 CTES. THIS FOLLOWS THE GIVEN EQUATION: (x*1.5)/2.5

Canara	QTY	<u>Percent</u>	<u>SYM</u>	BOTANICAL NAME (Family / Genus / Species)	COMMON NAME	<u>SIZE</u>	<u>COMMEN</u>
Canopy Trees	8	6%	AA	Acer x freemanii 'Jeffer's Red'	AUTUMN BLAZE MAPLE	4" Cal.	
	5	4%	AF	(Sapindaceae / Acer / Acer × freemanii) Acer x freemanii 'Marmo'	MARMO FREEMAN MAPLE	2.5" Cal.	
				(Sapindaceae / Acer / Acer × freemanii) Acer miyabei 'Morton'			
	6	5%	AM	(Sapindaceae / Acer / Acer miyabei) Acer x saccharum 'Green Mountain'	STATE STREET MAPLE GREEN MOUNTAIN SUGAR	2.5" Cal.	
	8	6%	AS	(Sapindaceae / Acer / Acer saccharum)	MAPLE	2.5" Cal.	
	6	5%	СО	Celtis occidentalis (Cannabaceae / Celtis / Celtis occidentalis)	COMMON HACKBERRY	2.5" Cal.	
	8	6%	CE	Celtis occidentalis 'Windy City' (Cannabaceae / Celtis / Celtis occidentalis)	WINDY CITY HACKBERRY	4" Cal.	
	7	6%	GT	Gleditsia triacanthos v. inermis 'Skyline' (Fabaceae / Gleditsia / Gleditsia triacanthos v. inermis)	SKYLINE HONEYLOCUST	4" Cal.	
	7	6%	GD	Gymnocladus dioicus 'Espresso-JFS'	ESPRESSO KENTUCKY	2.5" Cal.	
	7	6%	LT	(Fabaceae / Gymnocladus / Gymnocladus dioicus) Liriodendron tulipifera	COFFEETREE TULIPTREE	2.5" Cal.	
				(Magnoliaceae / Liriodendron / Liriodendron tulipifera) Platanus x acerifolia 'Morton Circle'	EXCLAMATION! LONDON		
	10	8%	PA	(Platanaceae / Platanus / Platanus × acerifolia) Quercus bicolor	PLANETREE	4" Cal.	
	8	6%	QB	(Fagaceae / Quercus / Quercus bicolor)	SWAMP WHITE OAK	2.5" Cal.	
	6	5%	QR	Quercus rubra (Fagaceae / Quercus / Quercus rubra)	RED OAK	2.5" Cal.	
	7	6%	TA	Tilia americana 'Redmond' (Malvaceae / Tilia / Tilia americana)	REDMOND AMERICAN LINDEN	2.5" Cal.	
	9	7%	TC	Tilia cordata 'Greenspire'	GREENSPIRE LITTLELEAF	2.5" Cal.	
	8	6%	TT	(Malvaceae / Tilia / Tilia cordata) Tilia tomentosa 'Sterling'	LINDEN STERLING SILVER LINDEN	4" Cal.	
				(Malvaceae / Tilia / Tilia tomentosa) Ulmus carpinifolia 'New Horizon'	NEW HORIZON		
	8	6%	UR	(Ulmaceae / Ulmus / Ulmus carpinifolia) Ulmus 'Morton'	SMOOTHLEAF ELM	4" Cal.	
	8	6%	UM	(Ulmaceae / Ulmus / Ulmus davidiana var. japonica)	ACCOLADE ELM	2.5" Cal.	
Total:		100%	00	Gingko biloba 'Princeton Sentry'		0.511.0.1	
Trees	8	15%	GB	(Ginkgoaceae / Ginkgo / Ginkgo biloba Gymnocladus dioicus 'Morton'	COLUMNAR GINKGO TREE SKINNY LATTE KENTUCKY	2.5" Cal.	
	10	26%	GM	Fabaceae / Gymnocladus / Gtmnocladus diouicus	COFFEE TREE	2.5" Cal.	
	10	15%	СВ	Caprinus betulus 'Fastigiata' (Betulaceae / Carpinus / Carpinus betulus)	PYRAMIDAL EUROPEAN HORNBEAM	2.5" Cal.	
	10	26%	LS	Liquidambar styraciflua 'Slende Silhoute' (Hamamelidaceae / Liquidambar / Liquidambar styraciflua	SLENDER SILHOUETTE SWEETGUM	2.5" Cal.	
	9	18%	QC	Quercus 'Crimschmidt	CRIMSON SPIRE OAK	2.5" Cal.	
Total:	47	100%		(Fagaceae / Quercus / Quercus Crimschmidt)			
Evergreen Trees	8	22%	AC	Abies concolor (Pinaceae / Abies / Abies concolor)	WHITE FIR	6' Ht.	
	10	27%	PG	Picea glauca 'Densata'	BLACK HILLS SPRUCE	6' Ht.	
	9	29%	PP	(Pinaceae / Picea / Picea glauca) Picea pungens	GREEN COLORADO	6' Ht.	
				(Pinaceae / Picea / Picea pungens) Pinus strobus	SPRUCE		
Total:	9 : 36	22% 100%	PS	(Pinaceae / Pinus / Pinus strobus)	WHITE PINE	6' Ht.	
Understory	10	22%	AG	Amelanchier x grandiflora	APPLE SERVICEBERRY	8' Ht.	Multi-sten
Trees				(Rosaceae / Amelanchier / Amelanchier x grandiflora) Cercis canadensis			
	7	16%	CC	(Fabaceae / Cercis / Cercis canadensis) Cornus mas	EASTERN REDBUD CORNELIANCHERRY	8' Ht.	Multi-sten
	6	13%	СМ	(Cornaceae / Cornus / Cornus mas)	DOGWOOD	8' Ht.	Multi-sten
	6	13%	СТ	Crataegus crusgalli var. inermis (Rosaceae / Crataegus / Crataegus crusgalli)	THORNLESS COCKSPUR HAWTHORN	2" Cal.	Single Ste
	8	18%	MA	Malus 'Purple Prince' (Rosaceae / Malus / Malus x)	PURPLE PRINCE CRABAPPLE	8' Ht.	Multi-sten
	8	18%	SP	Syringa pekinensis 'Morton'	CHINA SNOW PEKING	8' Ht.	Multi-sten
Total:	45	100%		(Oleaceae / Syringa / Syringa pekinensis)	LILAC		
Deciduous Shrubs	6	4%	AR	Aronia melanocarpa 'Morton' (Rosaceae / Aronia / Aronia melanocarpa)	IROQUOIS BEAUTY CHOKEBERRY	24" Ht.	3' O.C.
	17	12%	CF	Cornus sericea 'Farrow'	ARTIC FIRE REDTWIG	24" Ht.	3' O.C.
	9	7%	НА	(Cornaceae / Cornus / Cornus sericea) Hydrangea quercifolia 'Alice'	DOGWOOD OAKLEAF HYDRANGEA	36" Ht.	4' O.C.
			HP	(Hydrangeaceae / Hydrangea / Hydrangea quercifolia) Hydrangea paniculata 'SMHPLQF'	LITTLE QUICK FIRE		3' O.C.
	5	4%		(Hydrangeaceae / Hydrangea / Hydrangea paniculata) Physocarpus opulifolius 'Donna May'	HYDRANGEA	24" Ht.	
	15	11%	PD	(Rosaceae / Physocarpus / Physocarpus opulifolius)	LITTLE DEVIL NINEBARK	24" Ht.	3' O.C.
	52	38%	RA	Rhus aromatica 'Gro-low' (Anacardiaceae / Rhus / Rhus aromatica)	GRO-LOW SUMAC	24" Wide	4' O.C.
	13	9%	RB	Ribes alpinum 'Green Mound' (Grossulariaceae / Ribes / Ribes alpinum)	GREEN MOUND ALPINE CURRANT	24" Ht.	3' O.C.
	17	12%	SM	Syringa meyeri 'Palabin'	DWARF KOREAN LILAC	24" Ht.	4' O.C.
	3	2%	VJ	(Oleaceae / Syringa / Syringa meyeri) Viburnum x juddii	JUDD VIBURNUM	36" Ht.	4' O.C.
		100%		(Adoxaceae / Viburnum / Viburnum x juddii)	2222.00.01000	-5 110	
Total:			JK	Juniperus chinensis 'Kallay's Compact' (Cupressaceae / Juniperus / Juniperus chinensis)	KALLAY'S COMPACT PFITZER JUNIPER	30" Wd.	4' O.C.
Evergreen	19	34%		Juniperus conferta 'Blue Pacific'		30" Wd.	5' O.C.
			.IC		BLUE PACIFIC II INIPER	, vvu.	5 5.0.
Evergreen	11	19%	JC	(Cupressaceae / Juniperus / Juniperus conferta) Juniperus chinensis 'Sea Green'	BLUE PACIFIC JUNIPER	3011/1/1-1	E! () ()
Evergreen	11	19% 20%	JS	Juniperus chinensis 'Sea Green' (Cupressaceae / Juniperus / Juniperus chinensis)	SEA GREEN JUNIPER	30" Wd.	5' O.C.
Evergreen	11	19%		Juniperus chinensis 'Sea Green' (Cupressaceae / Juniperus / Juniperus chinensis) Taxus x media 'Densiformis' (Taxaceae / Taxus / Taxus x media)	SEA GREEN JUNIPER DENSE YEW	30" Wd.	5' O.C. 4' O.C.
Evergreen Shrubs	11 12 10 6	19% 20% 17% 10%	JS	Juniperus chinensis 'Sea Green' (Cupressaceae / Juniperus / Juniperus chinensis) Taxus x media 'Densiformis'	SEA GREEN JUNIPER		
Evergreen Shrubs Total:	11 12 10 6 : 58	19% 20% 17% 10%	JS TM TO	Juniperus chinensis 'Sea Green' (Cupressaceae / Juniperus / Juniperus chinensis) Taxus x media 'Densiformis' (Taxaceae / Taxus / Taxus x media) Thuja occidentalis 'Smaragd' (Cupressaceae / Thuja / Thuja occidentalis)	SEA GREEN JUNIPER DENSE YEW EMERALD GREEN AMERICAN ARBORVITAE	30" Wd. 6' Ht.	4' O.C.
Evergreen Shrubs	11 12 10 6	19% 20% 17% 10%	JS TM	Juniperus chinensis 'Sea Green' (Cupressaceae / Juniperus / Juniperus chinensis) Taxus x media 'Densiformis' (Taxaceae / Taxus / Taxus x media) Thuja occidentalis 'Smaragd' (Cupressaceae / Thuja / Thuja occidentalis) Calamagrostis x acutiflora 'Karl Foerster' (Poaceae / Calamagrostis / Calamagrostis x acutiflora)	SEA GREEN JUNIPER DENSE YEW EMERALD GREEN	30" Wd. 6' Ht. Mature Height = 4'-6'	4' O.C. 30" O.C.
Evergreen Shrubs Total: Ornamental	11 12 10 6 : 58	19% 20% 17% 10%	JS TM TO	Juniperus chinensis 'Sea Green' (Cupressaceae / Juniperus / Juniperus chinensis) Taxus x media 'Densiformis' (Taxaceae / Taxus / Taxus x media) Thuja occidentalis 'Smaragd' (Cupressaceae / Thuja / Thuja occidentalis) Calamagrostis x acutiflora 'Karl Foerster'	SEA GREEN JUNIPER DENSE YEW EMERALD GREEN AMERICAN ARBORVITAE	30" Wd. 6' Ht. Mature Height	4' O.C.
Evergreen Shrubs Total: Ornamental	11 12 10 6 : 58 33	19% 20% 17% 10% 100% 13%	JS TM TO CK	Juniperus chinensis 'Sea Green' (Cupressaceae / Juniperus / Juniperus chinensis) Taxus x media 'Densiformis' (Taxaceae / Taxus / Taxus x media) Thuja occidentalis 'Smaragd' (Cupressaceae / Thuja / Thuja occidentalis) Calamagrostis x acutiflora 'Karl Foerster' (Poaceae / Calamagrostis / Calamagrostis x acutiflora) Panicum virgatum 'Heavy Metal' (Poaceae / Panicum / Panicum virgatum) Pennisetum alopecuroides 'Hameln'	SEA GREEN JUNIPER DENSE YEW EMERALD GREEN AMERICAN ARBORVITAE FEATHER REED GRASS	30" Wd. 6' Ht. Mature Height = 4'-6' Mature Height = 4'-6' Mature Height	4' O.C. 30" O.C.
Evergreen Shrubs Total: Ornamental	11 12 10 6 : 58 33 64 71	19% 20% 17% 10% 100% 13% 25% 28%	JS TM TO CK PV PE	Juniperus chinensis 'Sea Green' (Cupressaceae / Juniperus / Juniperus chinensis) Taxus x media 'Densiformis' (Taxaceae / Taxus / Taxus x media) Thuja occidentalis 'Smaragd' (Cupressaceae / Thuja / Thuja occidentalis) Calamagrostis x acutiflora 'Karl Foerster' (Poaceae / Calamagrostis / Calamagrostis x acutiflora) Panicum virgatum 'Heavy Metal' (Poaceae / Panicum / Panicum virgatum) Pennisetum alopecuroides 'Hameln' (Poaceae / Pennisetum / Pennisetum alopecuroides)	SEA GREEN JUNIPER DENSE YEW EMERALD GREEN AMERICAN ARBORVITAE FEATHER REED GRASS BLUE SWITCHGRASS DWARF FOUNTAIN GRASS	30" Wd. 6' Ht. Mature Height = 4'-6' Mature Height = 4'-6' Mature Height = 24-36"	4' O.C. 30" O.C. 24" O.C. 24" O.C.
Evergreen Shrubs Total: Ornamental	11 12 10 6 : 58 33 64	19% 20% 17% 10% 100% 13% 25%	JS TM TO CK PV	Juniperus chinensis 'Sea Green' (Cupressaceae / Juniperus / Juniperus chinensis) Taxus x media 'Densiformis' (Taxaceae / Taxus / Taxus x media) Thuja occidentalis 'Smaragd' (Cupressaceae / Thuja / Thuja occidentalis) Calamagrostis x acutiflora 'Karl Foerster' (Poaceae / Calamagrostis / Calamagrostis x acutiflora) Panicum virgatum 'Heavy Metal' (Poaceae / Panicum / Panicum virgatum) Pennisetum alopecuroides 'Hameln' (Poaceae / Pennisetum / Pennisetum alopecuroides) Schizachyrium scoparium 'Twilight Zone' (Poaceae / Schizachyrium / Schizachyrium scoparium)	SEA GREEN JUNIPER DENSE YEW EMERALD GREEN AMERICAN ARBORVITAE FEATHER REED GRASS BLUE SWITCHGRASS	30" Wd. 6' Ht. Mature Height = 4'-6' Mature Height = 4'-6' Mature Height = 24-36" Mature Height = 3-4'	4' O.C. 30" O.C. 24" O.C. 24" O.C.
Total: Ornamental Grasses	11 12 10 6 58 33 64 71 33 52	19% 20% 17% 10% 100% 13% 25% 28%	JS TM TO CK PV PE	Juniperus chinensis 'Sea Green' (Cupressaceae / Juniperus / Juniperus chinensis) Taxus x media 'Densiformis' (Taxaceae / Taxus / Taxus x media) Thuja occidentalis 'Smaragd' (Cupressaceae / Thuja / Thuja occidentalis) Calamagrostis x acutiflora 'Karl Foerster' (Poaceae / Calamagrostis / Calamagrostis x acutiflora) Panicum virgatum 'Heavy Metal' (Poaceae / Panicum / Panicum virgatum) Pennisetum alopecuroides 'Hameln' (Poaceae / Pennisetum / Pennisetum alopecuroides) Schizachyrium scoparium 'Twilight Zone'	SEA GREEN JUNIPER DENSE YEW EMERALD GREEN AMERICAN ARBORVITAE FEATHER REED GRASS BLUE SWITCHGRASS DWARF FOUNTAIN GRASS TWILIGHT LITTLE	30" Wd. 6' Ht. Mature Height = 4'-6' Mature Height = 4'-6' Mature Height = 24-36" Mature Height	4' O.C. 30" O.C. 24" O.C. 24" O.C.
Total: Ornamental Grasses Total:	11 12 10 6 58 33 64 71 33 52 253	19% 20% 17% 10% 100% 13% 25% 28% 13% 21% 100%	JS TM TO CK PV PE SS SH	Juniperus chinensis 'Sea Green' (Cupressaceae / Juniperus / Juniperus chinensis) Taxus x media 'Densiformis' (Taxaceae / Taxus / Taxus x media) Thuja occidentalis 'Smaragd' (Cupressaceae / Thuja / Thuja occidentalis) Calamagrostis x acutiflora 'Karl Foerster' (Poaceae / Calamagrostis / Calamagrostis x acutiflora) Panicum virgatum 'Heavy Metal' (Poaceae / Panicum / Panicum virgatum) Pennisetum alopecuroides 'Hameln' (Poaceae / Pennisetum / Pennisetum alopecuroides) Schizachyrium scoparium 'Twilight Zone' (Poaceae / Schizachyrium / Schizachyrium scoparium) Sporobolus heterolepis (Poaceae / Sporobolus / Sporobolus heterolepis)	SEA GREEN JUNIPER DENSE YEW EMERALD GREEN AMERICAN ARBORVITAE FEATHER REED GRASS BLUE SWITCHGRASS DWARF FOUNTAIN GRASS TWILIGHT LITTLE BLUESTEM PRAIRIE DROPSEED	30" Wd. 6' Ht. Mature Height = 4'-6' Mature Height = 4'-6' Mature Height = 24-36" Mature Height = 3-4' Mature Height	4' O.C. 30" O.C. 24" O.C. 24" O.C. 24" O.C.
Total: Ornamental Grasses	11 12 10 6 58 33 64 71 33 52	19% 20% 17% 10% 100% 13% 25% 28% 13% 21%	JS TM TO CK PV PE SS	Juniperus chinensis 'Sea Green' (Cupressaceae / Juniperus / Juniperus chinensis) Taxus x media 'Densiformis' (Taxaceae / Taxus / Taxus x media) Thuja occidentalis 'Smaragd' (Cupressaceae / Thuja / Thuja occidentalis) Calamagrostis x acutiflora 'Karl Foerster' (Poaceae / Calamagrostis / Calamagrostis x acutiflora) Panicum virgatum 'Heavy Metal' (Poaceae / Panicum / Panicum virgatum) Pennisetum alopecuroides 'Hameln' (Poaceae / Pennisetum / Pennisetum alopecuroides) Schizachyrium scoparium 'Twilight Zone' (Poaceae / Schizachyrium / Schizachyrium scoparium) Sporobolus heterolepis (Poaceae / Sporobolus / Sporobolus heterolepis) Allium 'Summer Beauty' (Amaryllidaceae / Allium / Allium x)	SEA GREEN JUNIPER DENSE YEW EMERALD GREEN AMERICAN ARBORVITAE FEATHER REED GRASS BLUE SWITCHGRASS DWARF FOUNTAIN GRASS TWILIGHT LITTLE BLUESTEM	30" Wd. 6' Ht. Mature Height = 4'-6' Mature Height = 4'-6' Mature Height = 24-36" Mature Height = 3-4' Mature Height	4' O.C. 30" O.C. 24" O.C. 24" O.C.
Total: Ornamental Grasses Total:	11 12 10 6 58 33 64 71 33 52 253	19% 20% 17% 10% 100% 13% 25% 28% 13% 21% 100%	JS TM TO CK PV PE SS SH	Juniperus chinensis 'Sea Green' (Cupressaceae / Juniperus / Juniperus chinensis) Taxus x media 'Densiformis' (Taxaceae / Taxus / Taxus x media) Thuja occidentalis 'Smaragd' (Cupressaceae / Thuja / Thuja occidentalis) Calamagrostis x acutiflora 'Karl Foerster' (Poaceae / Calamagrostis / Calamagrostis x acutiflora) Panicum virgatum 'Heavy Metal' (Poaceae / Panicum / Panicum virgatum) Pennisetum alopecuroides 'Hameln' (Poaceae / Pennisetum / Pennisetum alopecuroides) Schizachyrium scoparium 'Twilight Zone' (Poaceae / Schizachyrium / Schizachyrium scoparium) Sporobolus heterolepis (Poaceae / Sporobolus / Sporobolus heterolepis) Allium 'Summer Beauty' (Amaryllidaceae / Allium / Allium x) Hemerocallis 'Happy Returns' (Asphodelaceae / Hemerocallis / Hemerocallis x)	SEA GREEN JUNIPER DENSE YEW EMERALD GREEN AMERICAN ARBORVITAE FEATHER REED GRASS BLUE SWITCHGRASS DWARF FOUNTAIN GRASS TWILIGHT LITTLE BLUESTEM PRAIRIE DROPSEED	30" Wd. 6' Ht. Mature Height = 4'-6' Mature Height = 4'-6' Mature Height = 24-36" Mature Height = 3-4' Mature Height	4' O.C. 30" O.C. 24" O.C. 24" O.C. 24" O.C.
Total: Ornamental Grasses Total:	11 12 10 6 58 33 64 71 33 52 253 86	19% 20% 17% 10% 100% 13% 25% 28% 13% 21% 100% 17%	JS TM TO CK PV PE SS SH AB	Juniperus chinensis 'Sea Green' (Cupressaceae / Juniperus / Juniperus chinensis) Taxus x media 'Densiformis' (Taxaceae / Taxus / Taxus x media) Thuja occidentalis 'Smaragd' (Cupressaceae / Thuja / Thuja occidentalis) Calamagrostis x acutiflora 'Karl Foerster' (Poaceae / Calamagrostis / Calamagrostis x acutiflora) Panicum virgatum 'Heavy Metal' (Poaceae / Panicum / Panicum virgatum) Pennisetum alopecuroides 'Hameln' (Poaceae / Pennisetum / Pennisetum alopecuroides) Schizachyrium scoparium 'Twilight Zone' (Poaceae / Schizachyrium / Schizachyrium scoparium) Sporobolus heterolepis (Poaceae / Sporobolus / Sporobolus heterolepis) Allium 'Summer Beauty' (Amaryllidaceae / Allium / Allium x) Hemerocallis 'Happy Returns' (Asphodelaceae / Hemerocallis / Hemerocallis x)	SEA GREEN JUNIPER DENSE YEW EMERALD GREEN AMERICAN ARBORVITAE FEATHER REED GRASS BLUE SWITCHGRASS DWARF FOUNTAIN GRASS TWILIGHT LITTLE BLUESTEM PRAIRIE DROPSEED SUMMER BEAUTY ONION	30" Wd. 6' Ht. Mature Height = 4'-6' Mature Height = 4'-6' Mature Height = 24-36" Mature Height = 3-4' Mature Height	4' O.C. 30" O.C. 24" O.C. 24" O.C. 24" O.C. 18" O.C. 18" O.C.
Total: Ornamental Grasses Total:	11 12 10 6 58 33 64 71 33 52 253 86 111	19% 20% 17% 10% 100% 13% 25% 28% 13% 21% 100% 17% 22%	JS TM TO CK PV PE SS SH AB HH	Juniperus chinensis 'Sea Green' (Cupressaceae / Juniperus / Juniperus chinensis) Taxus x media 'Densiformis' (Taxaceae / Taxus / Taxus x media) Thuja occidentalis 'Smaragd' (Cupressaceae / Thuja / Thuja occidentalis) Calamagrostis x acutiflora 'Karl Foerster' (Poaceae / Calamagrostis / Calamagrostis x acutiflora) Panicum virgatum 'Heavy Metal' (Poaceae / Panicum / Panicum virgatum) Pennisetum alopecuroides 'Hameln' (Poaceae / Pennisetum / Pennisetum alopecuroides) Schizachyrium scoparium 'Twilight Zone' (Poaceae / Schizachyrium / Schizachyrium scoparium) Sporobolus heterolepis (Poaceae / Sporobolus / Sporobolus heterolepis) Allium 'Summer Beauty' (Amaryllidaceae / Allium / Allium x) Hemerocallis 'Happy Returns' (Asphodelaceae / Hemerocallis / Hemerocallis x) Hemerocallis 'Rosy Retuns' (Asphodelaceae / Hemerocallis / Hemerocallis x) Heuchera 'Georgia Peach'	SEA GREEN JUNIPER DENSE YEW EMERALD GREEN AMERICAN ARBORVITAE FEATHER REED GRASS BLUE SWITCHGRASS DWARF FOUNTAIN GRASS TWILIGHT LITTLE BLUESTEM PRAIRIE DROPSEED SUMMER BEAUTY ONION HAPPY RETURNS DAYLILY ROSY RETURNS DAYLILY GEORGIA PEACH CORAL	30" Wd. 6' Ht. Mature Height = 4'-6' Mature Height = 4'-6' Mature Height = 24-36" Mature Height = 3-4' Mature Height	4' O.C. 30" O.C. 24" O.C. 24" O.C. 24" O.C. 18" O.C. 18" O.C.
Total: Ornamental Grasses Total:	11 12 10 6 58 33 64 71 33 52 253 86 111 103 30	19% 20% 17% 10% 100% 13% 25% 28% 13% 21% 100% 17% 22% 20% 6%	JS TM TO CK PV PE SS SH AB HH HR	Juniperus chinensis 'Sea Green' (Cupressaceae / Juniperus / Juniperus chinensis) Taxus x media 'Densiformis' (Taxaceae / Taxus / Taxus x media) Thuja occidentalis 'Smaragd' (Cupressaceae / Thuja / Thuja occidentalis) Calamagrostis x acutiflora 'Karl Foerster' (Poaceae / Calamagrostis / Calamagrostis x acutiflora) Panicum virgatum 'Heavy Metal' (Poaceae / Panicum / Panicum virgatum) Pennisetum alopecuroides 'Hameln' (Poaceae / Pennisetum / Pennisetum alopecuroides) Schizachyrium scoparium 'Twilight Zone' (Poaceae / Schizachyrium / Schizachyrium scoparium) Sporobolus heterolepis (Poaceae / Sporobolus / Sporobolus heterolepis) Allium 'Summer Beauty' (Amaryllidaceae / Allium / Allium x) Hemerocallis 'Happy Returns' (Asphodelaceae / Hemerocallis / Hemerocallis x) Hemerocallis 'Rosy Retuns' (Asphodelaceae / Hemerocallis / Hemerocallis x) Heuchera 'Georgia Peach' (Saxifragaceae / Heuchera / Heuchera x) Hosta 'Patriot'	SEA GREEN JUNIPER DENSE YEW EMERALD GREEN AMERICAN ARBORVITAE FEATHER REED GRASS BLUE SWITCHGRASS DWARF FOUNTAIN GRASS TWILIGHT LITTLE BLUESTEM PRAIRIE DROPSEED SUMMER BEAUTY ONION HAPPY RETURNS DAYLILY ROSY RETURNS DAYLILY GEORGIA PEACH CORAL BELLS	30" Wd. 6' Ht. Mature Height = 4'-6' Mature Height = 4'-6' Mature Height = 24-36" Mature Height = 3-4' Mature Height	4' O.C. 30" O.C. 24" O.C. 24" O.C. 24" O.C. 18" O.C. 18" O.C. 18" O.C.
Total: Ornamental Grasses Total:	11 12 10 6 58 33 64 71 33 52 253 86 111 103 30 13	19% 20% 17% 10% 100% 13% 25% 28% 13% 21% 100% 17% 22% 20% 6% 3%	JS TM TO CK PV PE SS SH AB HH HR HG	Juniperus chinensis 'Sea Green' (Cupressaceae / Juniperus / Juniperus chinensis) Taxus x media 'Densiformis' (Taxaceae / Taxus / Taxus x media) Thuja occidentalis 'Smaragd' (Cupressaceae / Thuja / Thuja occidentalis) Calamagrostis x acutiflora 'Karl Foerster' (Poaceae / Calamagrostis / Calamagrostis x acutiflora) Panicum virgatum 'Heavy Metal' (Poaceae / Panicum / Panicum virgatum) Pennisetum alopecuroides 'Hameln' (Poaceae / Pennisetum / Pennisetum alopecuroides) Schizachyrium scoparium 'Twilight Zone' (Poaceae / Schizachyrium / Schizachyrium scoparium) Sporobolus heterolepis (Poaceae / Sporobolus / Sporobolus heterolepis) Allium 'Summer Beauty' (Amaryllidaceae / Allium / Allium x) Hemerocallis 'Happy Returns' (Asphodelaceae / Hemerocallis / Hemerocallis x) Hemerocallis 'Rosy Retuns' (Asphodelaceae / Hemerocallis / Hemerocallis x) Heuchera 'Georgia Peach' (Saxifragaceae / Heuchera / Heuchera x)	SEA GREEN JUNIPER DENSE YEW EMERALD GREEN AMERICAN ARBORVITAE FEATHER REED GRASS BLUE SWITCHGRASS DWARF FOUNTAIN GRASS TWILIGHT LITTLE BLUESTEM PRAIRIE DROPSEED SUMMER BEAUTY ONION HAPPY RETURNS DAYLILY ROSY RETURNS DAYLILY GEORGIA PEACH CORAL BELLS PATRIOT HOSTA	30" Wd. 6' Ht. Mature Height = 4'-6' Mature Height = 4'-6' Mature Height = 24-36" Mature Height = 3-4' Mature Height	4' O.C. 30" O.C. 24" O.C. 24" O.C. 24" O.C. 18" O.C. 18" O.C. 18" O.C. 18" O.C.
Total: Ornamental Grasses Total: Perennials	11 12 10 6 58 33 64 71 33 52 253 86 111 103 30 13 168	19% 20% 17% 10% 100% 13% 25% 28% 13% 21% 100% 17% 22% 20% 6% 3% 33%	JS TM TO CK PV PE SS SH AB HH HR	Juniperus chinensis 'Sea Green' (Cupressaceae / Juniperus / Juniperus chinensis) Taxus x media 'Densiformis' (Taxaceae / Taxus / Taxus x media) Thuja occidentalis 'Smaragd' (Cupressaceae / Thuja / Thuja occidentalis) Calamagrostis x acutiflora 'Karl Foerster' (Poaceae / Calamagrostis / Calamagrostis x acutiflora) Panicum virgatum 'Heavy Metal' (Poaceae / Panicum / Panicum virgatum) Pennisetum alopecuroides 'Hameln' (Poaceae / Pennisetum / Pennisetum alopecuroides) Schizachyrium scoparium 'Twilight Zone' (Poaceae / Schizachyrium / Schizachyrium scoparium) Sporobolus heterolepis (Poaceae / Sporobolus / Sporobolus heterolepis) Allium 'Summer Beauty' (Amaryllidaceae / Allium / Allium x) Hemerocallis 'Happy Returns' (Asphodelaceae / Hemerocallis / Hemerocallis x) Hemerocallis 'Rosy Retuns' (Asphodelaceae / Hemerocallis / Hemerocallis x) Heuchera 'Georgia Peach' (Saxifragaceae / Heuchera / Heuchera x) Hosta 'Patriot' (Asparagaceae / Hosta / Hosta x)	SEA GREEN JUNIPER DENSE YEW EMERALD GREEN AMERICAN ARBORVITAE FEATHER REED GRASS BLUE SWITCHGRASS DWARF FOUNTAIN GRASS TWILIGHT LITTLE BLUESTEM PRAIRIE DROPSEED SUMMER BEAUTY ONION HAPPY RETURNS DAYLILY ROSY RETURNS DAYLILY GEORGIA PEACH CORAL BELLS	30" Wd. 6' Ht. Mature Height = 4'-6' Mature Height = 4'-6' Mature Height = 24-36" Mature Height = 3-4' Mature Height	4' O.C. 30" O.C. 24" O.C. 24" O.C. 24" O.C. 18" O.C. 18" O.C. 18" O.C. 18" O.C.
Total: Ornamental Grasses Total:	11 12 10 6 58 33 64 71 33 52 253 86 111 103 30 13 168	19% 20% 17% 10% 100% 13% 25% 28% 13% 21% 100% 17% 22% 20% 6% 3%	JS TM TO CK PV PE SS SH AB HH HR HG	Juniperus chinensis 'Sea Green' (Cupressaceae / Juniperus / Juniperus chinensis) Taxus x media 'Densiformis' (Taxaceae / Taxus / Taxus x media) Thuja occidentalis 'Smaragd' (Cupressaceae / Thuja / Thuja occidentalis) Calamagrostis x acutiflora 'Karl Foerster' (Poaceae / Calamagrostis / Calamagrostis x acutiflora) Panicum virgatum 'Heavy Metal' (Poaceae / Panicum / Panicum virgatum) Pennisetum alopecuroides 'Hameln' (Poaceae / Pennisetum / Pennisetum alopecuroides) Schizachyrium scoparium 'Twilight Zone' (Poaceae / Schizachyrium / Schizachyrium scoparium) Sporobolus heterolepis (Poaceae / Sporobolus / Sporobolus heterolepis) Allium 'Summer Beauty' (Amaryllidaceae / Allium / Allium x) Hemerocallis 'Happy Returns' (Asphodelaceae / Hemerocallis / Hemerocallis x) Hemerocallis 'Rosy Retuns' (Asphodelaceae / Hemerocallis / Hemerocallis x) Heuchera 'Georgia Peach' (Saxifragaceae / Heuchera / Heuchera x) Hosta 'Patriot' (Asparagaceae / Hosta / Hosta x) Liriope muscari 'Big Blue'	SEA GREEN JUNIPER DENSE YEW EMERALD GREEN AMERICAN ARBORVITAE FEATHER REED GRASS BLUE SWITCHGRASS DWARF FOUNTAIN GRASS TWILIGHT LITTLE BLUESTEM PRAIRIE DROPSEED SUMMER BEAUTY ONION HAPPY RETURNS DAYLILY ROSY RETURNS DAYLILY GEORGIA PEACH CORAL BELLS PATRIOT HOSTA	30" Wd. 6' Ht. Mature Height = 4'-6' Mature Height = 4'-6' Mature Height = 24-36" Mature Height = 3-4' Mature Height	4' O.C. 30" O.C. 24" O.C. 24" O.C. 24" O.C. 18" O.C. 18" O.C. 18" O.C.

TOWNHOME FOUNDATION PLANTINGS EXCLUDED FROM OVERALL PLANT LIST

SEE SHEETS 5 & 6 FOR FOUNDATION PLANTINGS



GARY R. WEBER ASSOCIATES, INC. LAND PLANNING ECOLOGICAL CONSULTING

LANDSCAPE ARCHITECTURE 212 SOUTH MAIN STREET WHEATON, ILLINOIS 60187 PHONE: 630-668-7197

HEYDAY 3400 WEST STONEGATE BLVD SUITE 10 ARLINGTON HEIGHTS, IL 60005

CIVIL ENGINEER RWG ENGINEERING 975 E 22ND ST., SUITE 400 WHEATON, IL 60189

VOCON 3142 PROSPECT AVENUE E


CLEVELAND, OH 44115

05.22.2025 **REVISIONS**

05.23.2025 DATE PROJECT NO. HEY2501 CHECKED SHEET NO.

1 05 0



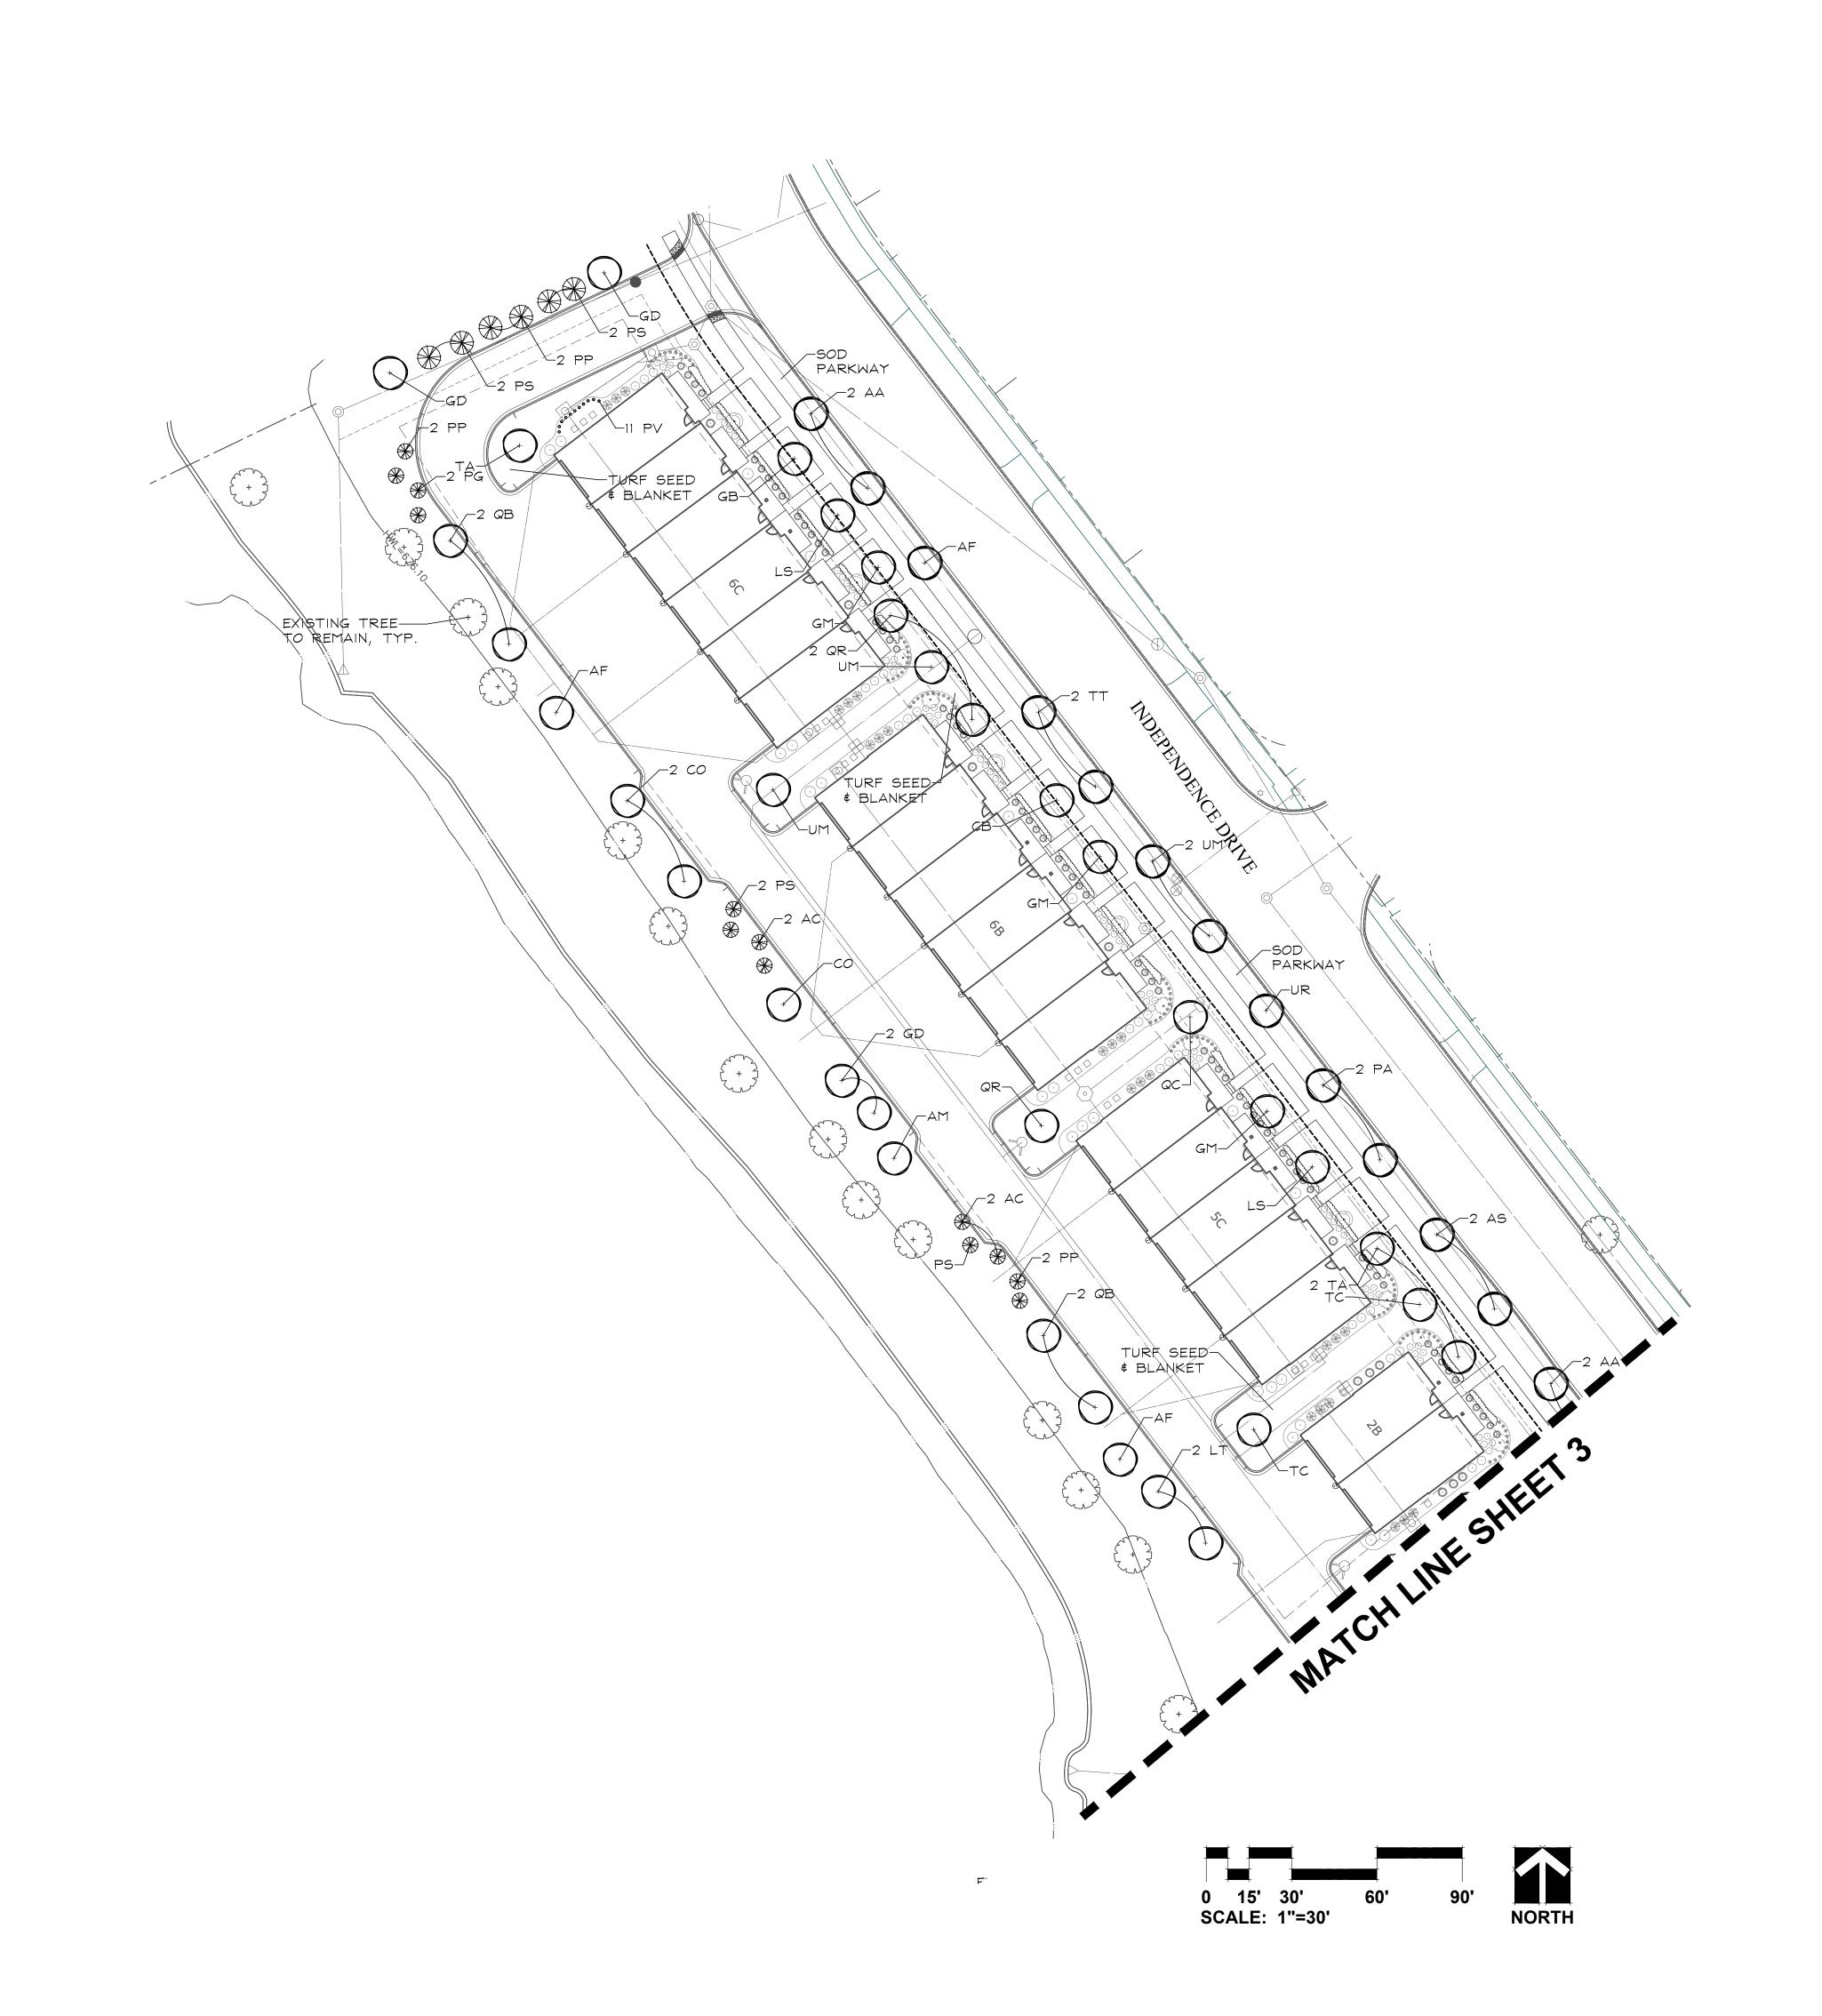



GARY R. WEBER ASSOCIATES, INC. LAND PLANNING
ECOLOGICAL CONSULTING
LANDSCAPE ARCHITECTURE 212 SOUTH MAIN STREET WHEATON, ILLINOIS 60187 PHONE: 630-668-7197

HEYDAY 3400 WEST STONEGATE BLVD SUITE 10 ARLINGTON HEIGHTS, IL 60005

CIVIL ENGINEER RWG ENGINEERING 975 E 22ND ST., SUITE 400 WHEATON, IL 60189 ARCHITECT

VOCON 3142 PROSPECT AVENUE E


CLEVELAND, OH 44115


ORA


HEYDAY AURORA, I ANDSC/


05.22.2025

CHECKED SHEET NO.

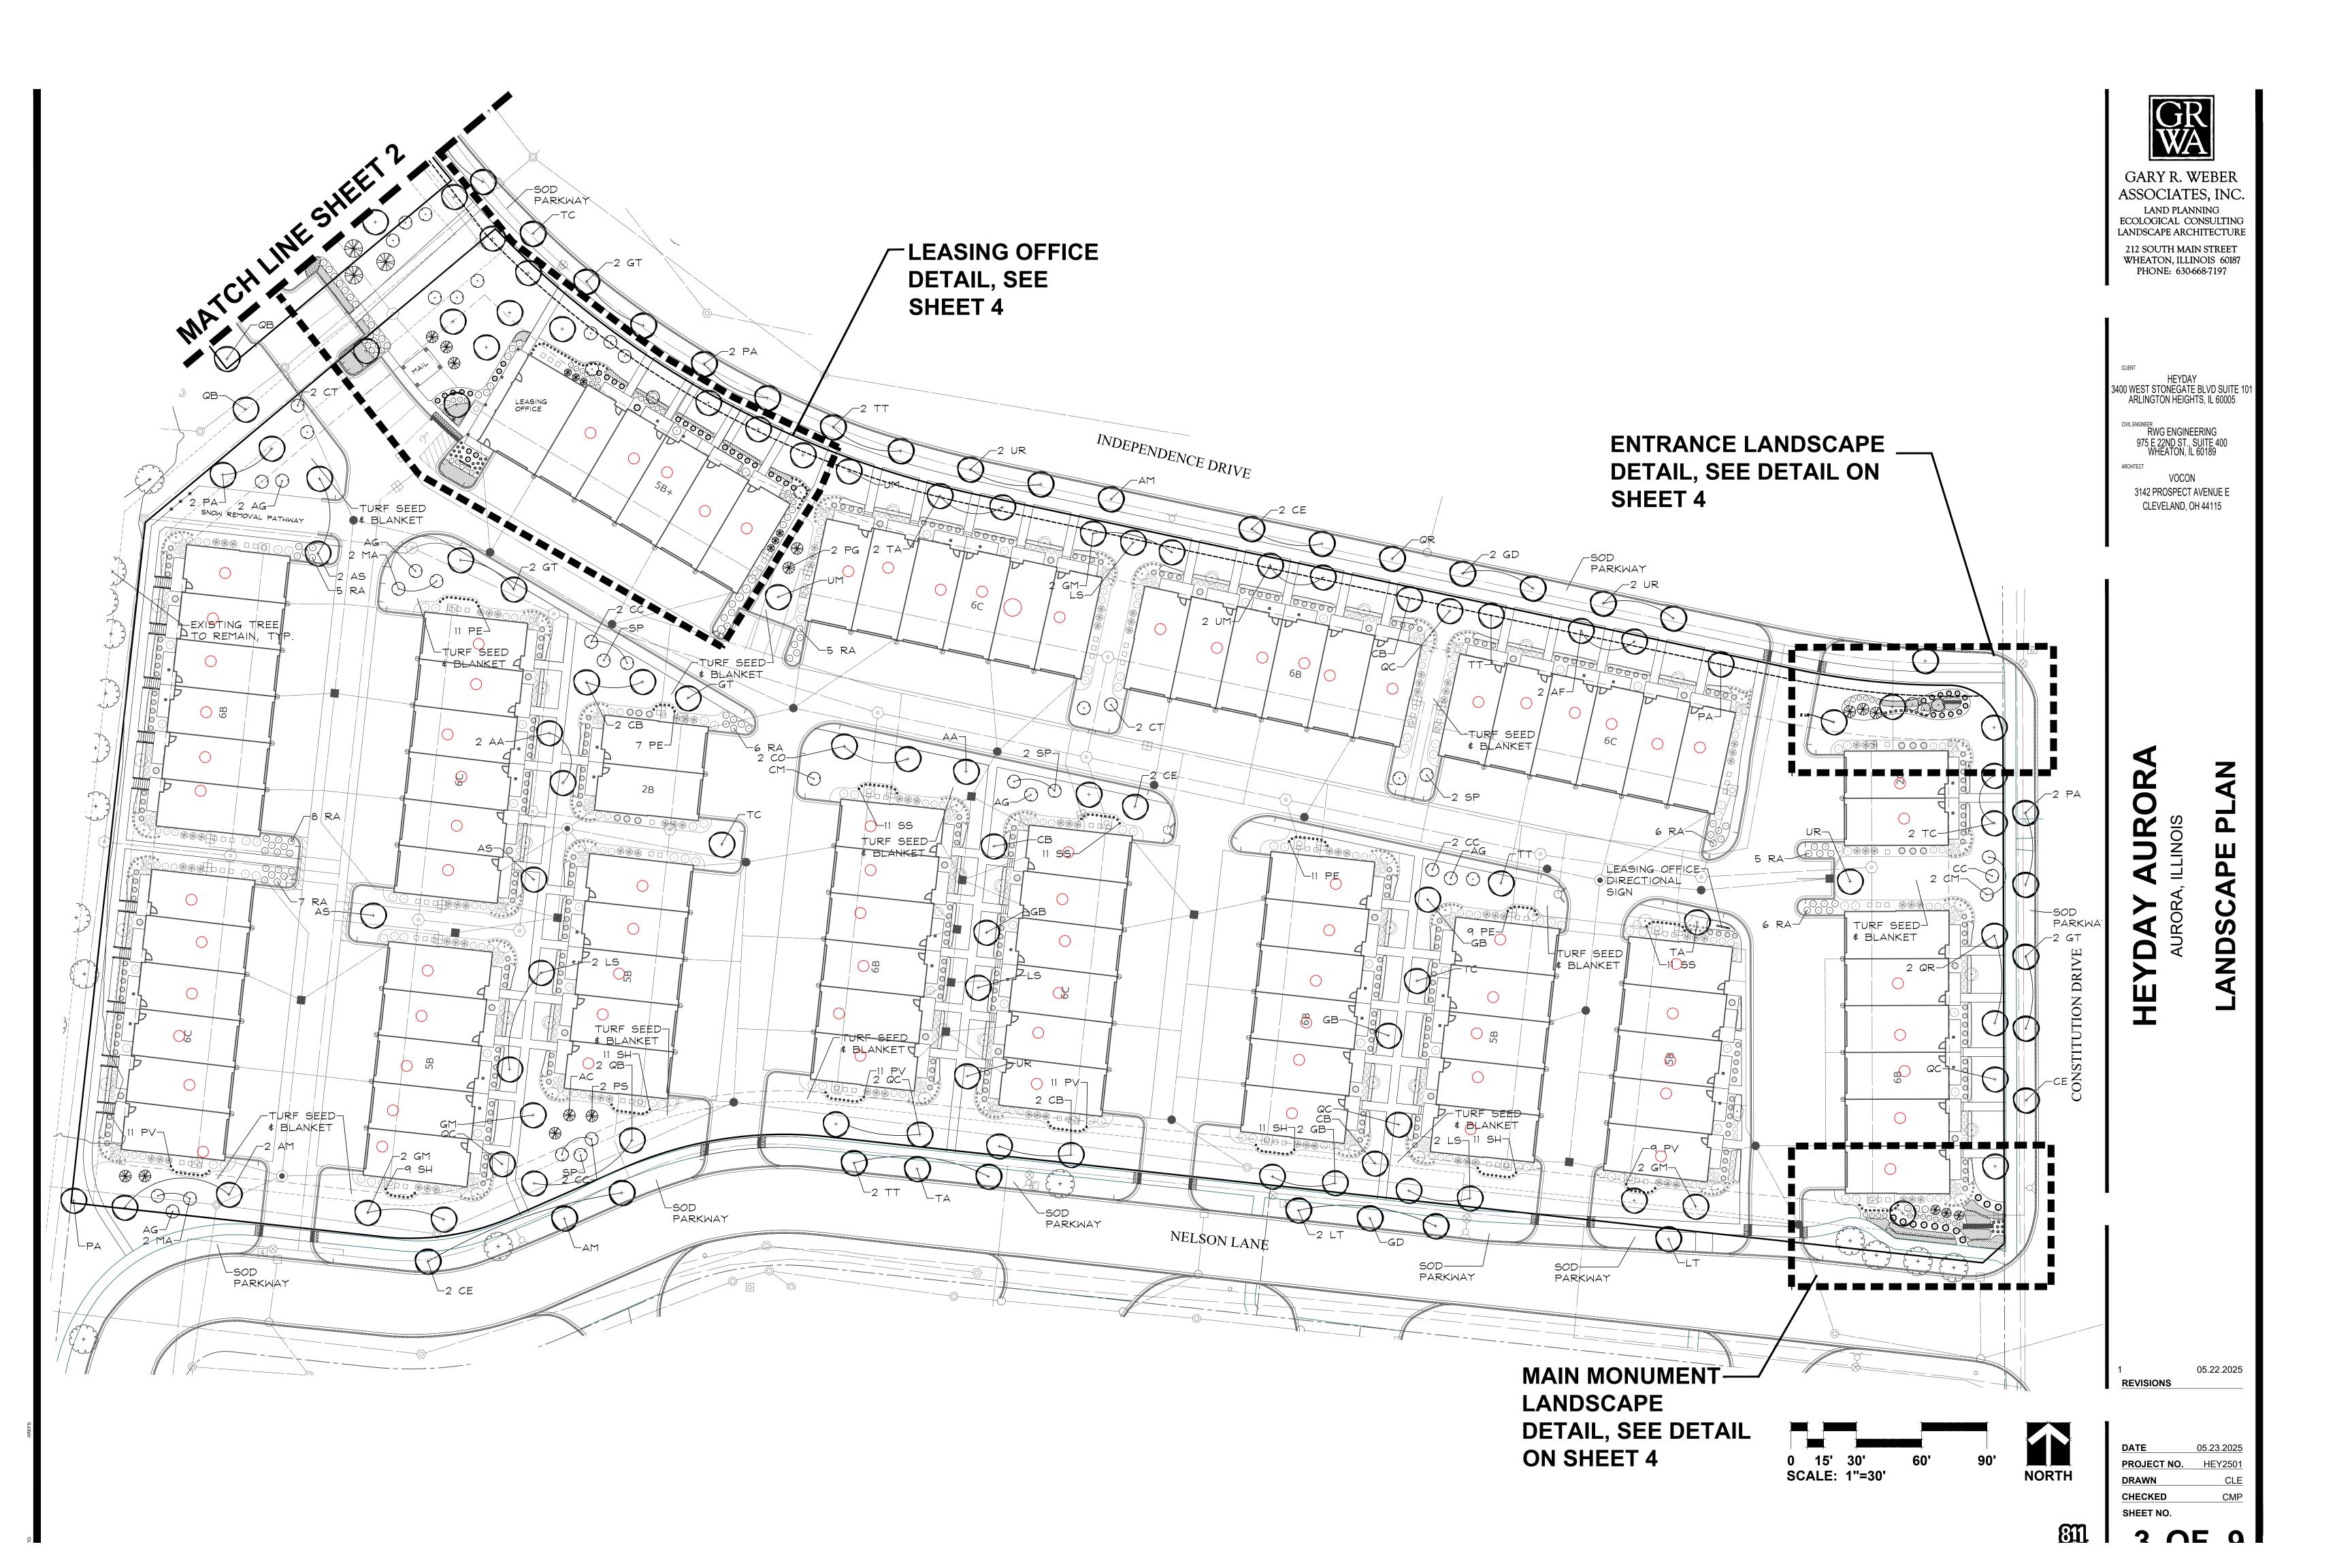

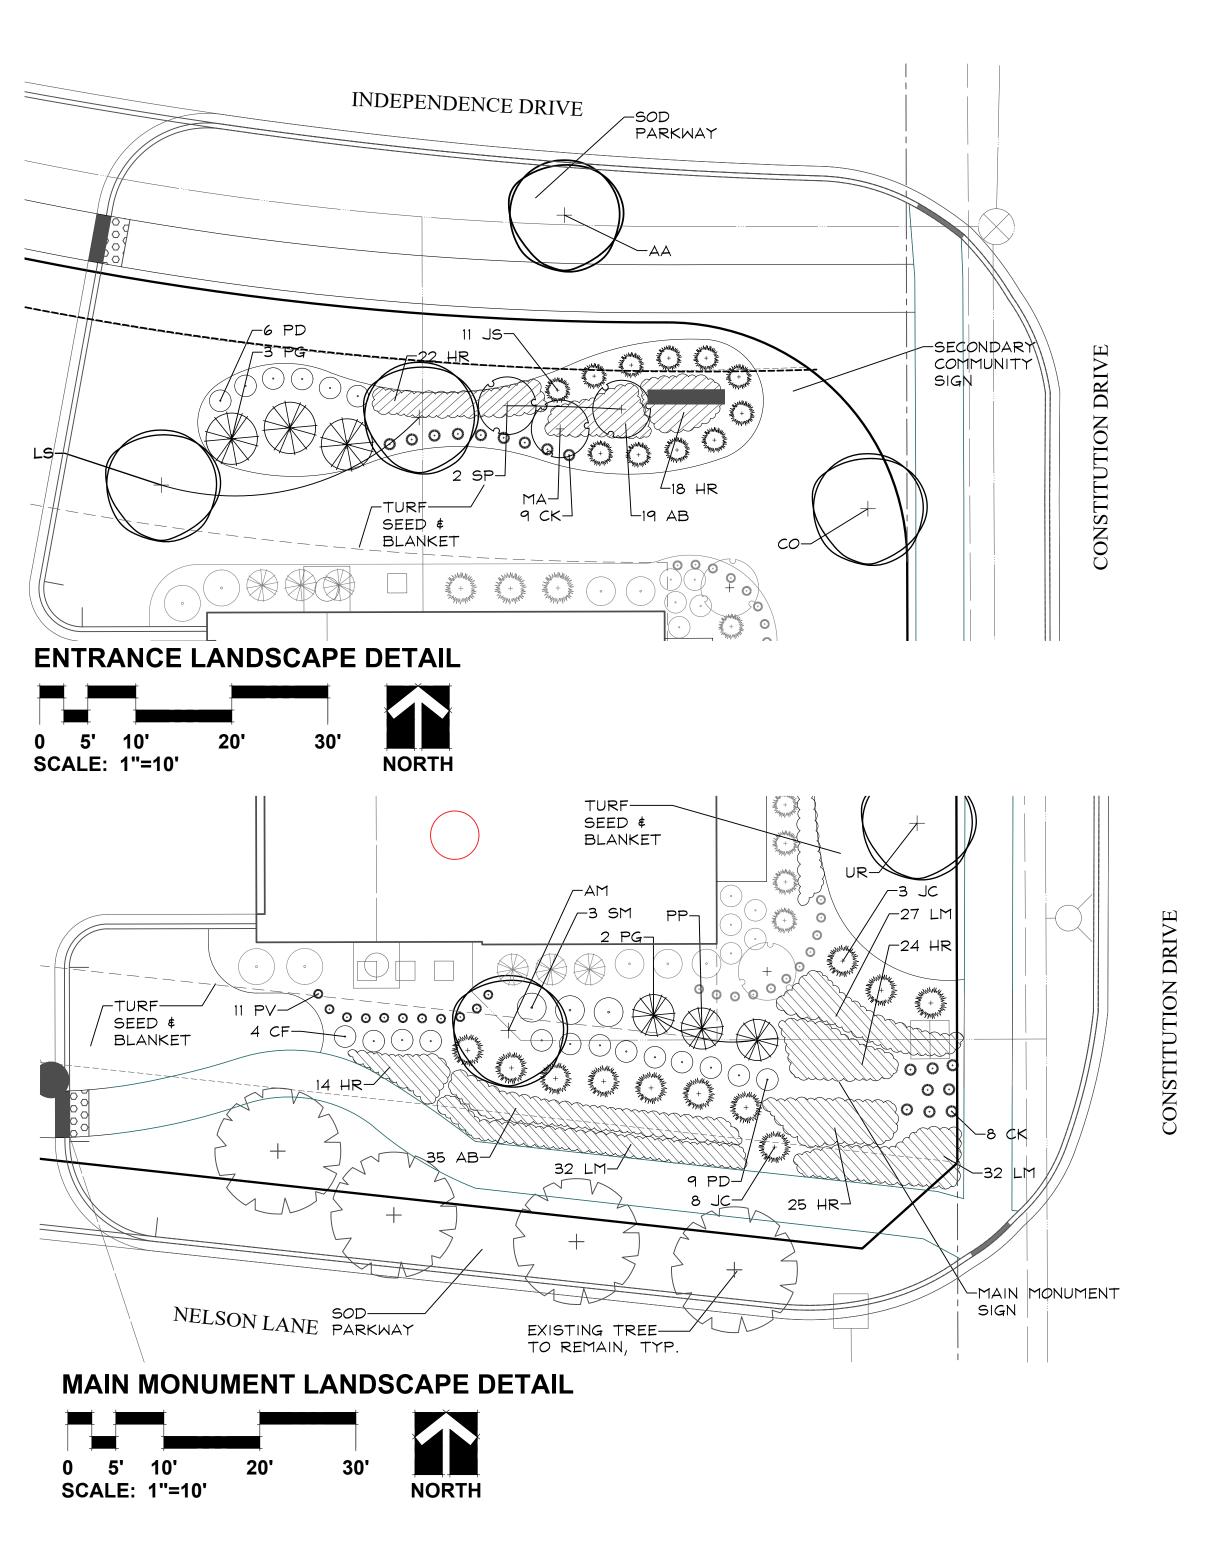

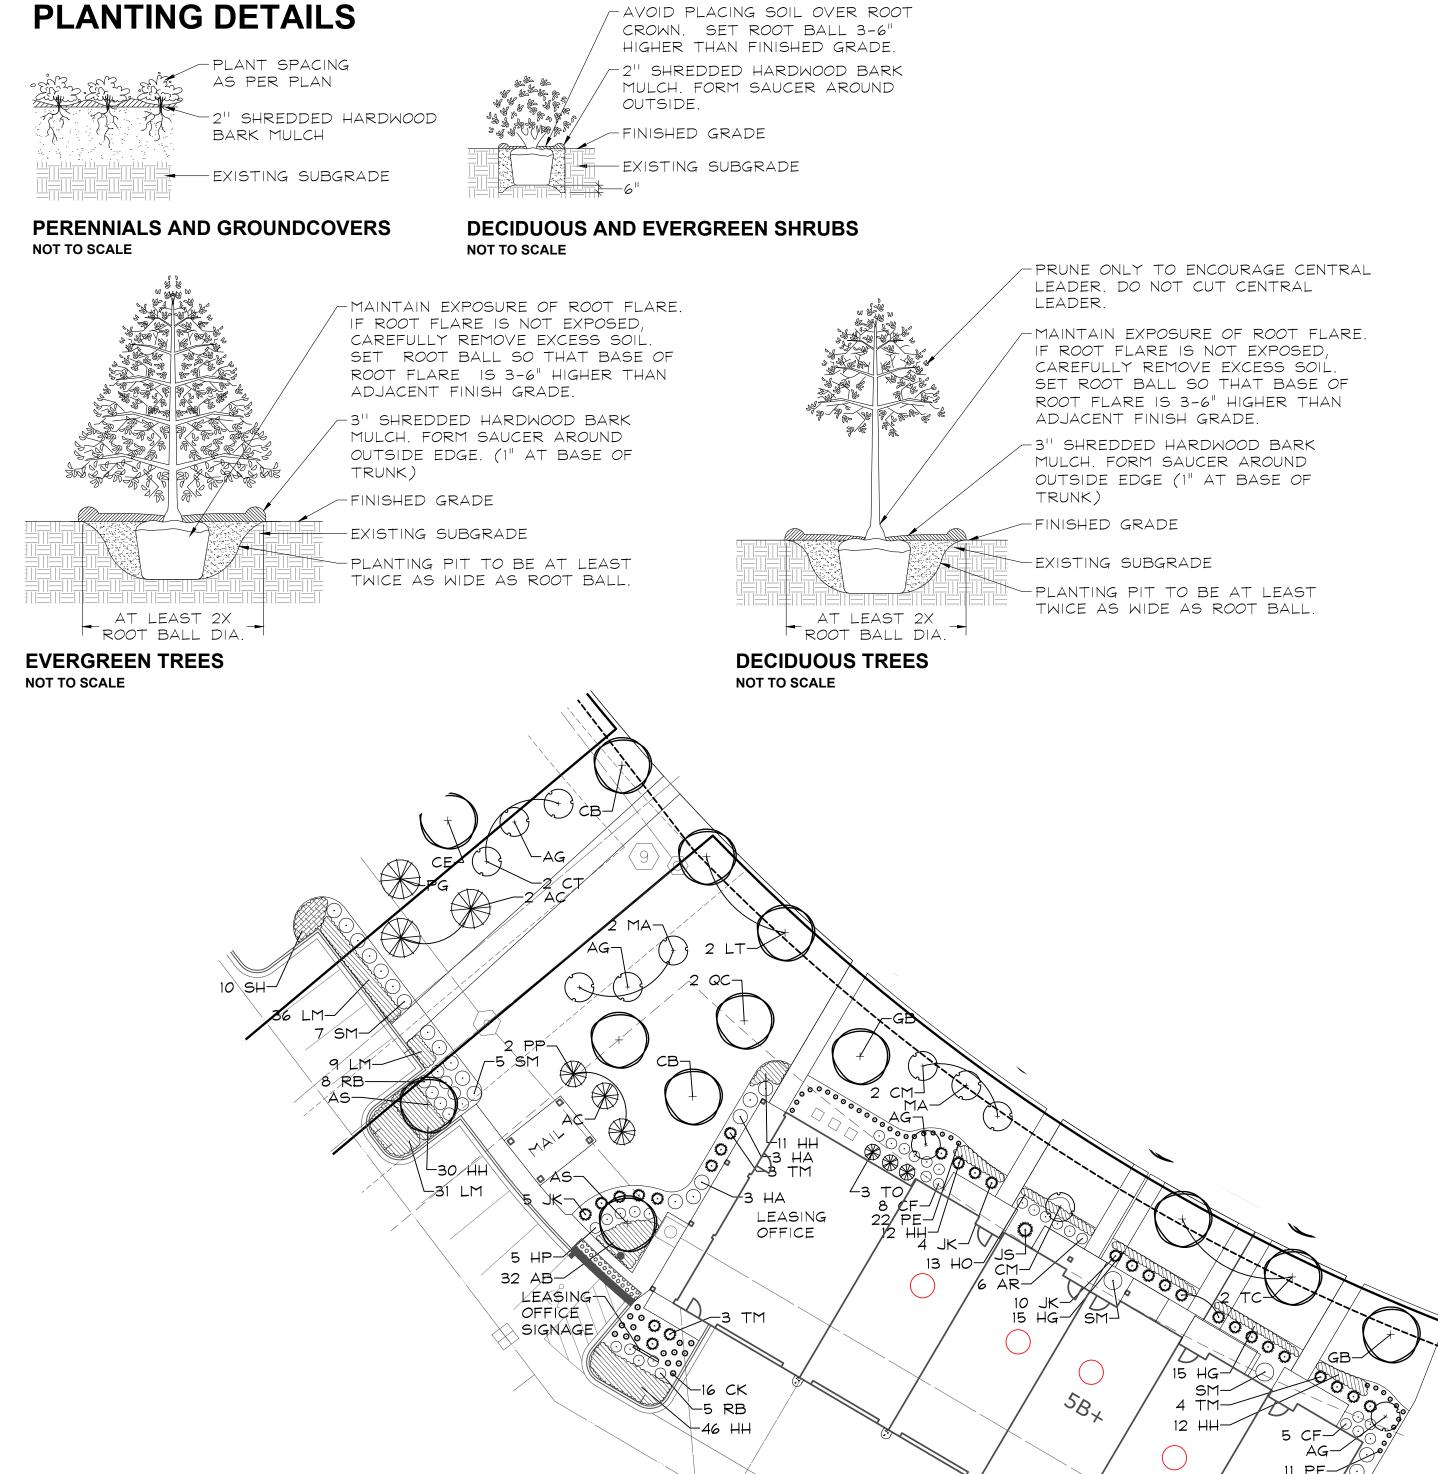

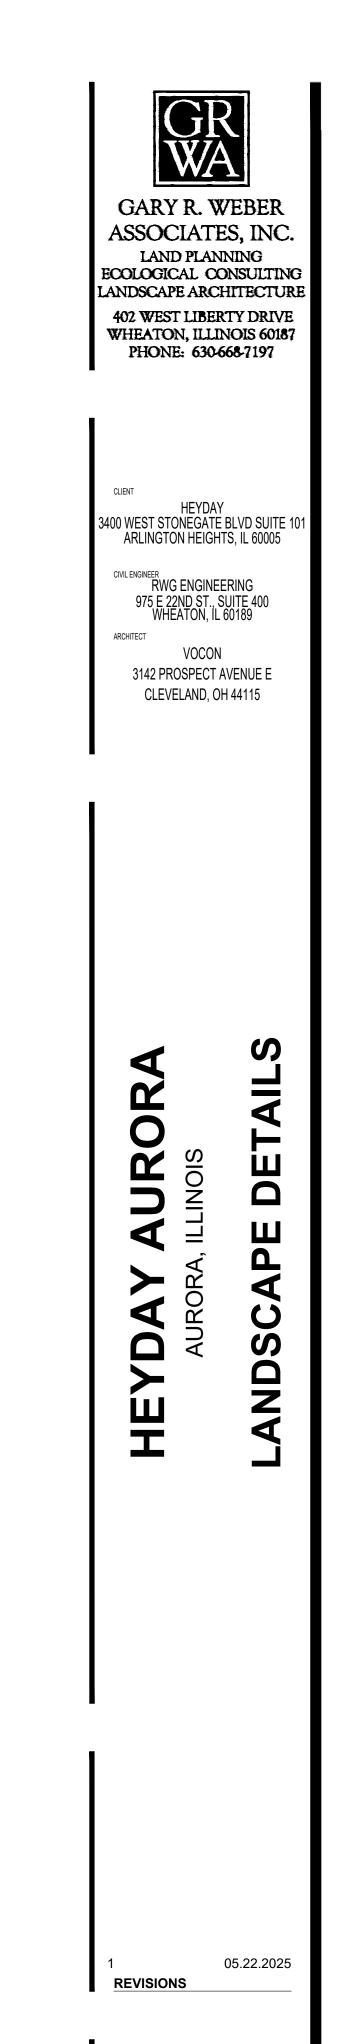

LEASING OFFICE LANDSCAPE DETAIL NORTH 0 10' 20' SCALE: 1"=20'

DATE 05.23.2025 PROJECT NO. HEY2501 CHECKED SHEET NO.



6 UNIT FOUNDATION PLAN PLANT LIST A BUILDINGS 1-2, 7, 12-14, 16, 19 & 21

Вυ	ILDI	NGS 1-2, 1, 12-14, 10, 1	3 CX Z I	
Key	Qty	Botanical/Common Name	Size Remarks	
		ORNAMENTAL TREES		
OT1	2	Amelanchier x grandiflora APPLE SERVICEBERRY	5' Ht.	
OT2	2	Cornus mas 'Golden Glory' GOLDEN GLORY CORNELIANCHERRY DO	5' Tall GWOOD	
		DECIDUOUS SHRUBS		
DS1	10	Cornus sericea 'Farrow' ARCTIC FIRE REDTWIG DOGWOOD	24" Tall	3' O.C.
DS2	12	Rhus aromatica 'Gro-low' GRO-LOW SUMAC	24" Wide	4' O.C.
DS3	6	Hydrangea quercifolia 'Alice' OAKLEAF HYDRANGEA	36" Tall	4' O.C.
DS4	2	Syringa meyeri 'Palabin' DWARF KOREAN LILAC	24" Tall	4' O.C.
DS5	4	Viburnum x juddii JUDD VIBURNUM	36" Tall	5' O.C.
		EVERGREEN SHRUBS		
ES1	18	Juniperus chinensis 'Kallays Compact' KALLAYS COMPACT PFITZER JUNIPER	24" Wide	4' O.C.
ES2	2	Juniperus chinensis 'Sea Green' SEA GREEN JUNIPER	30" Wide	5' O.C.
ET1	6	Thuja occidentalis 'Smaragd' EMERALD GREEN ARBORVITAE	5' Tall	
		PERENNIALS AND ORNAMENTAL GRASS	SES	
P1	24	Hemerocallis 'Happy Returns' HAPPY RETURNS DAYLILY	#1	18" O.C.
P2	26	Hosta 'Patriot' PATRIOT HOSTA	#1	18" O.C.
P3	30	Heuchera 'Palace Purple' PALACE PURPLE CORAL BELLS	#1	18" O.C.
0G1	22	Pennisetum alopecuroides 'Hameln' DWARF FOUNTAIN GRASS	#1	24" O.C.
		MISC. MATERIALS		

C.Y.

6 UNIT FOUNDATION PLAN PLANT LIST B

Key	Qty	Botanical/Common Name	Size	Remarks
		ORNAMENTAL TREES		
0T1	2	Magnolia stellata 'Royal Star' ROYAL STAR MAGNOLIA	5' Tall	
<i>0</i> T2	2	Malus x 'Red Jewel' RED JEWEL CRABAPPLE	5' Tall	
		DECIDUOUS SHRUBS		
DS1	10	Hydrangea paniculata 'SMHPLQF' LITTLE QUICK FIRE HYDRANGEA	24" Tall	3' O.C.
DS2	12	Weigela X 'Dark Horse' DARK HORSE WEIGELA	24" Wide	4' O.C.
DS3	6	Hydrangea paniculate 'Bulk' QUICKFIRE HYDRANGEA	36" Tall	41 O.C.
DS4	2	Syringa meyeri 'Palibin' DWARF KOREAN LILAC	24" Tall	4' O.C.
DS5	4	Viburnum dentatum ARROWWOOD VIBURNUM	36" Tall	5' O.C.
		EVERGREEN SHRUBS		
ES1	18	Taxus x media 'Densiformis' DENSE YEW	24" Wide	4 ¹ O.C.
ES2	2	Juniperus conferta 'Blue Pacific' BLUE PACIFIC JUNIPER	24" Wide	5' O.C.
EΤΊ	6	Thuja occidentalis 'Smaragd' EMERALD GREEN ARBORVITAE	5' Tall	
		PERENNIALS AND ORNAMENTAL GRA	ASSES	
P1	24	Achillea millefolium 'Balvinolet' NEW VINTAGE VIOLET YARROW	#1	18" O.C.
P2	26	Liriope muscari 'Big Blue' BIG BLUE LILYTURF	#1	18" O.C.
P3	30	Sedum 'Autumn Joy' AUTUMN JOY SEDUM	#1	18" O.C.
0G1	22	Miscanthus sinensis 'Purpurascens' PURPLE MAIDEN GRASS	#1	24" O.C.
		MISC. MATERIALS		
	10.5	SHREDDED HARDWOOD MULCH	C.Y.	


∟13 P2 ∟15 P3 ∟15 P3 _OT2 The state of the s STORE Mindle Mi ES2 6 DS2-ES2-5 DS1-└-6 DS2 3 DS3-3 DS3 2 DS5-6 UNIT FOUNDATION PLANTING ± 353 LF ANDSCAPING PROVIDED: 2.7 C.T.E. 34 DECIDUOUS SHRUBS 20 EVERGREEN SHRUBS

TYPICAL 6 UNIT FOUNDATION PLAN SCALE: 1"=10'

5 UNIT FOUNDATION PLAN BUILDINGS 3, 9 & 18

10.5 SHREDDED HARDWOOD MULCH

	T FOUNDATION PLAN DINGS 3, 9 & 18			5 UNIT FOUNDATION PLAN BUILDINGS 11 & 17				
Key	Botanical/Common Name	Size	Remarks	Key		Botanical/Common Name	Size	Remarks
	ORNAMENTAL TREES					ORNAMENTAL TREES		
OT1 2	Amelanchier x grandiflora APPLE SERVICEBERRY	5' Tall		OT1	2	Magnolia stellata 'Royal Star' ROYAL STAR MAGNOLIA	5' Tall	
OT2 1	Cornus mas 'Golden Glory' GOLDEN GLORY CORNELIANCHERRY [5' Tall DOGWOOD		OT2	1	Malus x 'Red Jewel' RED JEWEL CRABAPPLE	5' Tall	
	DECIDUOUS SHRUBS					DECIDUOUS SHRUBS		
DS1 10	Cornus sericea 'Farrow' ARCTIC FIRE REDTWIG DOGWOOD	24" Tall	3' O.C.	DS1	10	Hydrangea paniculata 'SMHPLQF' LITTLE QUICK FIRE HYDRANGEA	24" Tall	3' O.C.
DS2 6	Aronia melanocarpa 'Morton' IROQUOIS BEAUTY CHOKEBERRY	24" Tall	3' O.C.	DS2	6	Weigela X 'Dark Horse' DARK HORSE WEIGELA	24" Wide	4' O.C.
DS3 6	Hydrangea quercifolia 'Alice' OAKLEAF HYDRANGEA	36" Tall	4' O.C.	DS3	6	Hydrangea paniculate 'Bulk' QUICKFIRE HYDRANGEA	36" Tall	4' O.C.
DS4 2	Syringa meyeri 'Palibin' DWARF KOREAN LILAC	24" Tall	4' O.C.	DS4	2	Syringa meyeri 'Palibin' DWARF KOREAN LILAC	24" Tall	4' O.C.
DS4 6	Viburnum 'Juddii' JUDD VIBURNUM	36" Tall	5' O.C.	DS5	6	Viburnum dentatum ARROWWOOD VIBURNUM	36" Tall	5' O.C.
	EVERGREEN SHRUBS					EVERGREEN SHRUBS		
ES1 18	Juniperus chinensis 'Kallay's Compact' KALLAY'S COMPACT JUNIPER	24" Wide	4' O.C.	ES1	18	Taxus x media 'Densiformis' DENSE YEW	24" Wide	4' O.C.
ES2 1	Juniperus chinensis 'Sea Green' SEA GREEN JUNIPER	30" Wide	5' O.C.	ES2	1	Juniperus conferta 'Blue Pacific' BLUE PACIFIC JUNIPER	24" Wide	5' O.C.
ETI 6	Thuja occidentalis 'Smaragd' EMERALD GREEN ARBORVITAE	5' Tall		ET1	6	Thuja occidentalis 'Smaragd' EMERALD GREEN ARBORVITAE	5' Tall	
	PERENNIALS AND ORNAMENTAL GRAS	SSES				PERENNIALS AND ORNAMENTAL GRAS	SES	
P1 24	Hemerocallis 'Happy Returns' HAPPY RETURNS DAYLILY	#1	18" O.C.	P1	24	Hemerocallis 'Rosy Returns' ROSY RETURNS DAYLILY	#1	18" O.C.
P2 13	Hosta 'Patriot' PATRIOT HOSTA	#1	18' O.C.	P3	13	Liriope muscari 'Big Blue' BIG BLUE LILYTURF	#1	18" O.C.
P3 30	Heuchera 'Georgia Peach' GEORGIA PEACH CORAL BELLS	#1	18" O.C.	P2	30	Phlox 'Forever Pink' FOREVER PINK PHLOX	#1	18" O.C.
OG1 22	Pennisetum alopecuroides 'Hameln' DWARF FOUNTAIN GRASS	#1	24" O.C.	0G1	22	Miscanthus sinensis 'Purpurascens' PURPLE MAIDEN GRASS	#1	24" O.C.
	MISC. MATERIALS					MISC.MATERIALS		
9.5	SHREDDED HARDWOOD MULCH	C.Y.			9.5	SHREDDED HARDWOOD MULCH	C.Y.	

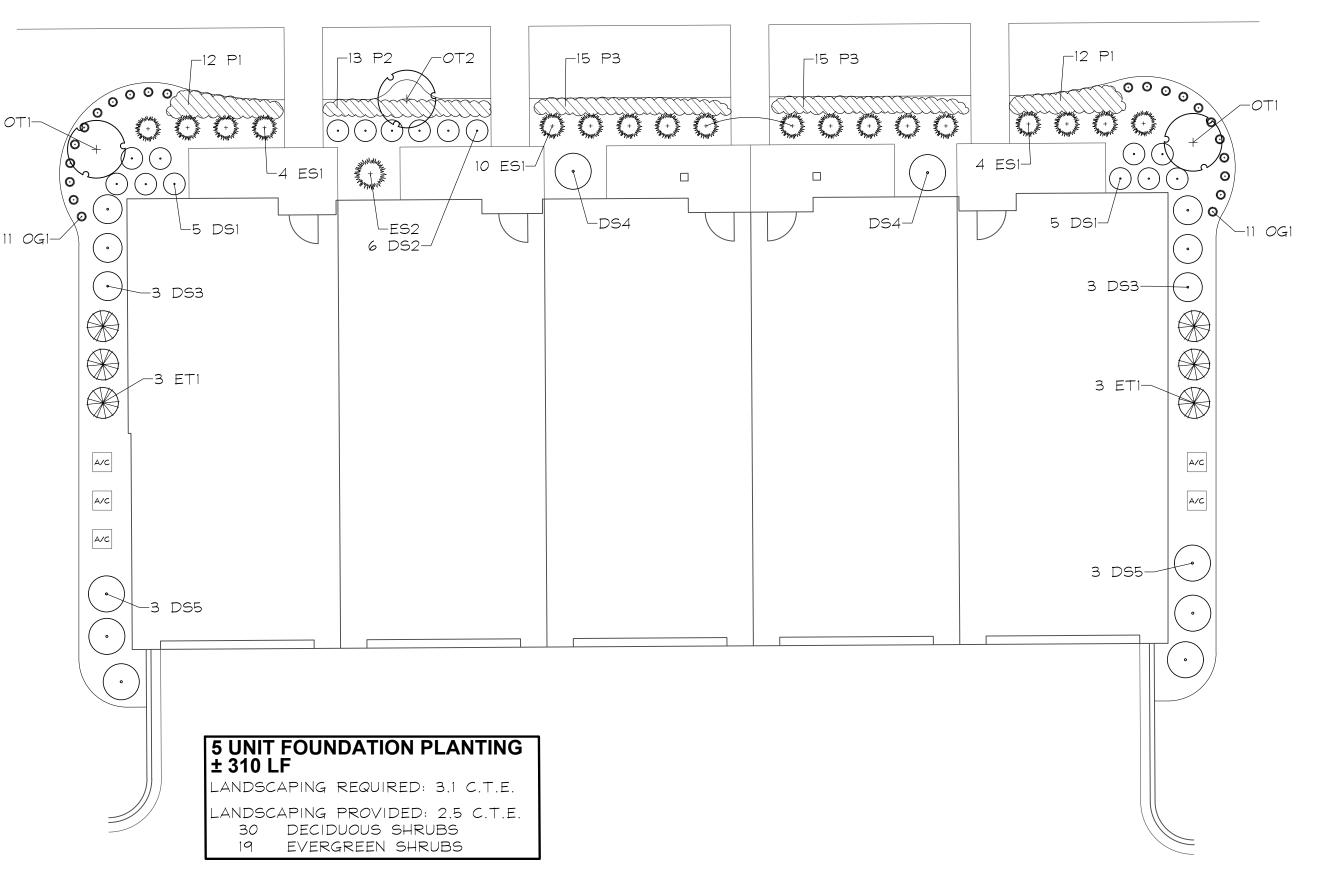

TYPICAL 5 UNIT FOUNDATION PLAN SCALE: 1"=10"

NDSC HEYDAY FOUND,

TYPIC,

05.22.2025

05.23.2025

GARY R. WEBER

ASSOCIATES, INC.

LAND PLANNING ECOLOGICAL CONSULTING LANDSCAPE ARCHITECTURE

212 SOUTH MAIN STREET WHEATON, ILLINOIS 60187 PHONE: 630-668-7197

HEYDAY 3400 WEST STONEGATE BLVD SUITE 10 ARLINGTON HEIGHTS, IL 60005

RWG ENGINEERING 975 E 22ND ST., SUITE 400 WHEATON, IL 60189

VOCON 3142 PROSPECT AVENUE E CLEVELAND, OH 44115

ARCHITECT

CHECKED SHEET NO.

PROJECT NO. HEY2501

REVISIONS



212 SOUTH MAIN STREET WHEATON, ILLINOIS 60187 PHONE: 630-668-7197

HEYDAY 3400 WEST STONEGATE BLVD SUITE 10 ARLINGTON HEIGHTS, IL 60005 CIVIL ENGINEER RWG ENGINEERING 975 E 22ND ST., SUITE 400 WHEATON, IL 60189

> VOCON 3142 PROSPECT AVENUE E

CLEVELAND, OH 44115

4 NDSC,

05.22.2025 REVISIONS

PROJECT NO. HEY2501 CHECKED SHEET NO.

a of a


DUPLEX FOUNDATION PLAN PLANT LIST A

7.0 SHREDDED HARDWOOD MULCH


	ILD	INGS 4 & 20			BU	ILD	ING 10		
Key		Botanical/Common Name	Size	Remarks	Key		Botanical/Common Name	Size	Remarks
		ORNAMENTAL TREES					ORNAMENTAL TREES		
OT1	2	Cornus mas 'Golden Glory' GOLDEN GLORY CORNELIANCHERRY D	5' Tall DOGWOOD		OT1	2	Malus x 'Red Jewel' RED JEWEL CRABAPPLE	5' Tall	
		DECIDUOUS SHRUBS					DECIDUOUS SHRUBS		
DS1	10	Cornus sericea 'Farrow' ARCTIC FIRE REDTWIG DOGWOOD	24" Tall	3' O.C.	DS1	10	Hydrangea paniculata 'SMHPLQF' LITTLE QUICK FIRE HYDRANGEA	24" Tall	3' O.C.
DS2	4	Hydrangea quercifolia 'Alice' OAKLEAF HYDRANGEA	36" Tall	4' O.C.	DS2	4	Syringa meyeri 'Palibin' DWARF KOREAN LILAC	24" Tall	4' O.C.
DS3	4	Viburnum 'Juddii' JUDD VIBURNUM	36" Tall	5' O.C.	DS3	4	Viburnum dentatum ARROWWOOD VIBURNUM	36" Tall	5' O.C.
		EVERGREEN SHRUBS					EVERGREEN SHRUBS		
ES1	10	Juniperus chinensis 'Kallay's Compact' KALLAY'S COMPACT JUNIPER	24" Wide	4' O.C.	ES1	10	Taxus x media 'Densiformis' DENSE YEW	24" Wide	4' O.C.
ES2	6	Juniperus chinensis 'Sea Green' SEA GREEN JUNIPER	30" Wide	5' O.C.	ES2	6	Juniperus conferta 'Blue Pacific' BLUE PACIFIC JUNIPER	24" Wide	5' O.C.
ET1	6	Thuja occidentalis 'Smaragd' EMERALD GREEN ARBORVITAE	5' Tall		ETI	6	Thuja occidentalis 'Smaragd' EMERALD GREEN ARBORVITAE	5' Tall	
		PERENNIALS AND ORNAMENTAL GRAS	SSES				PERENNIALS AND ORNAMENTAL GRA	ASSES	
P1	26	Hemerocallis 'Happy Returns' HAPPY RETURNS DAYLILY	#1	18" O.C.	P1	26	Hemerocallis 'Rosy Returns' ROSY RETURNS DAYLILY	#1	18" O.C.
0G1	20	Pennisetum alopecuroides 'Hameln' DWARF FOUNTAIN GRASS	#1	24" O.C.	OGI	20	Miscanthus sinensis 'Purpurascens' PURPLE MAIDEN GRASS	#1	24" O.C
		MISC. MATERIALS					MISC.MATERIALS		


DUPLEX FOUNDATION PLAN PLANT LIST B

7.0 SHREDDED HARDWOOD MULCH

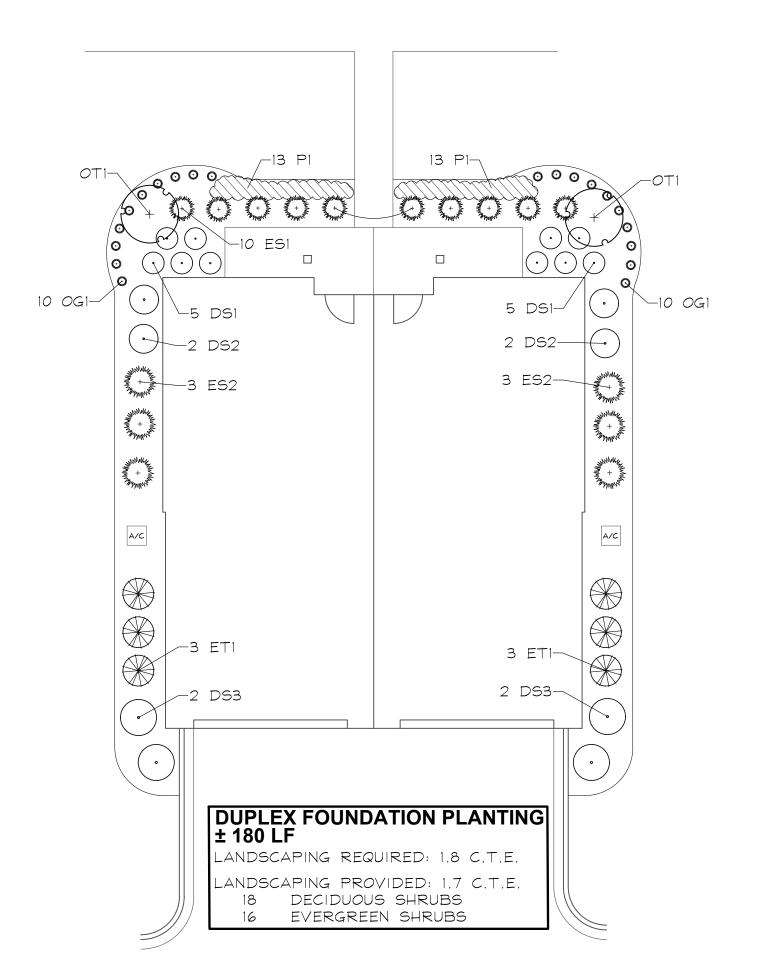


TYPICAL DUPLEX FOUNDATION PLAN SCALE: 1"=10"

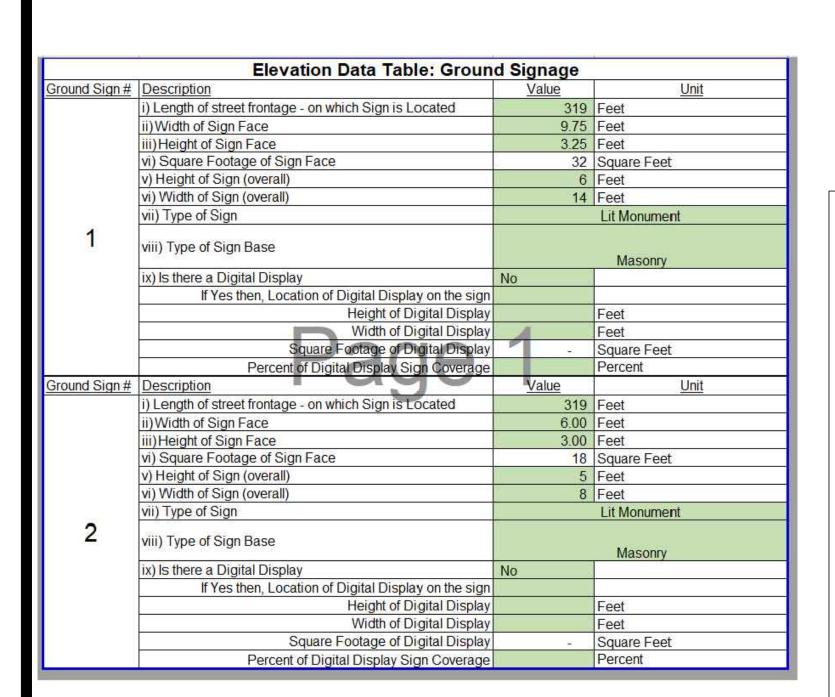


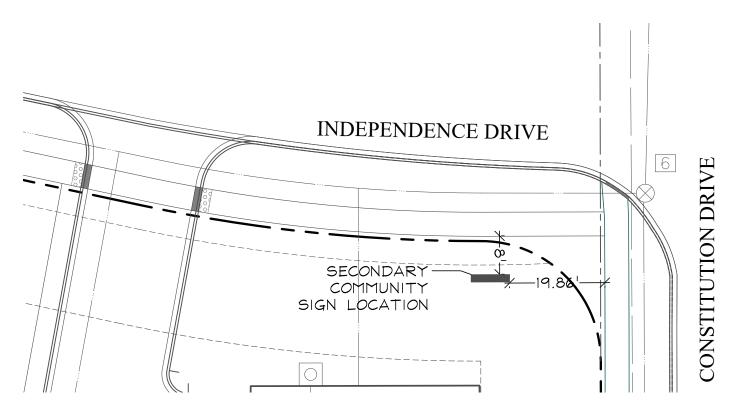


GROUND SIGN #2 LOCATION

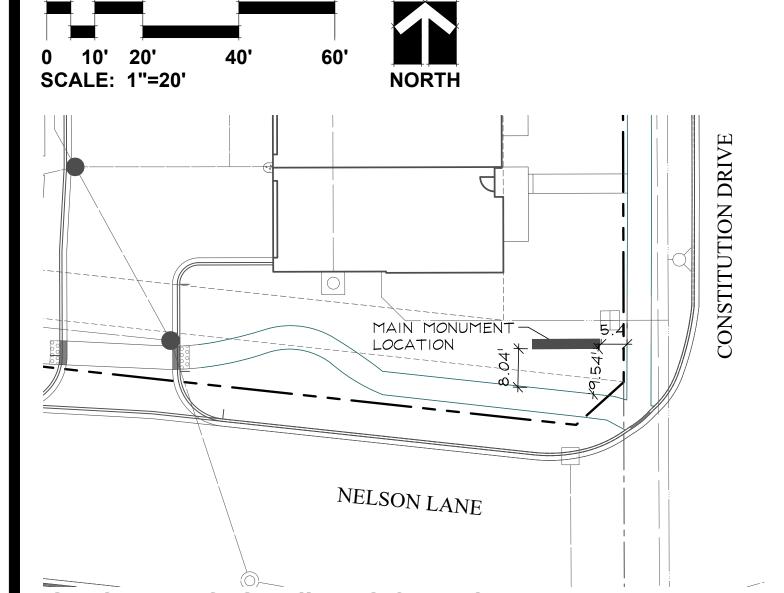


GROUND SIGN #1 LOCATION

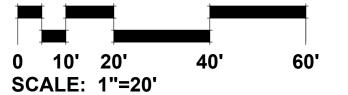



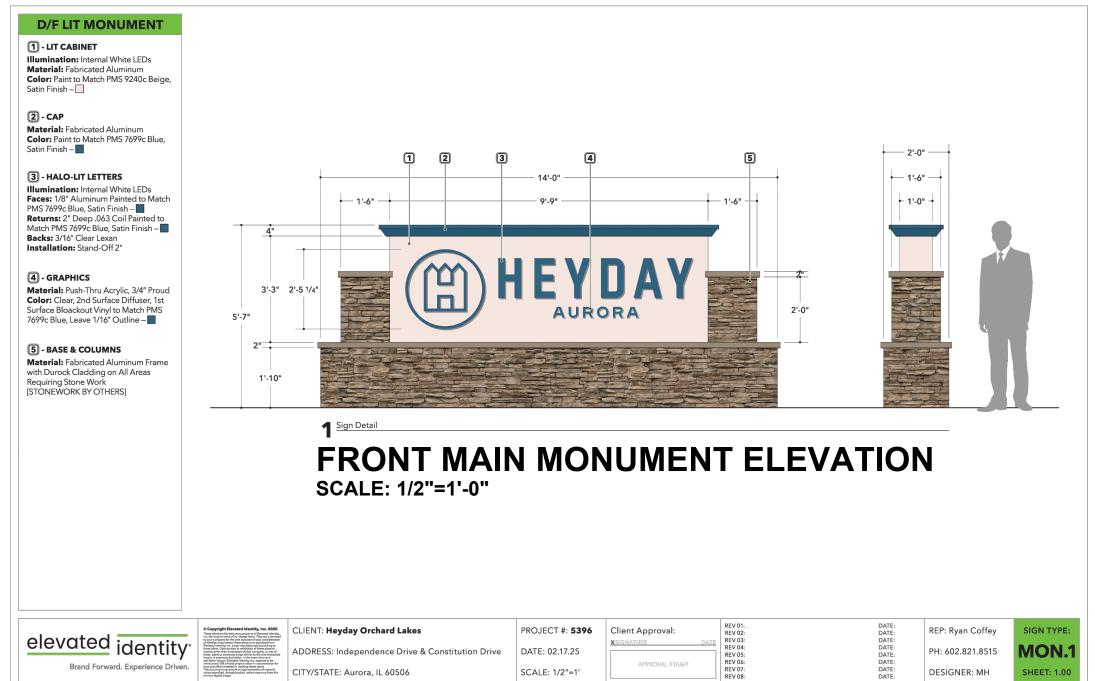

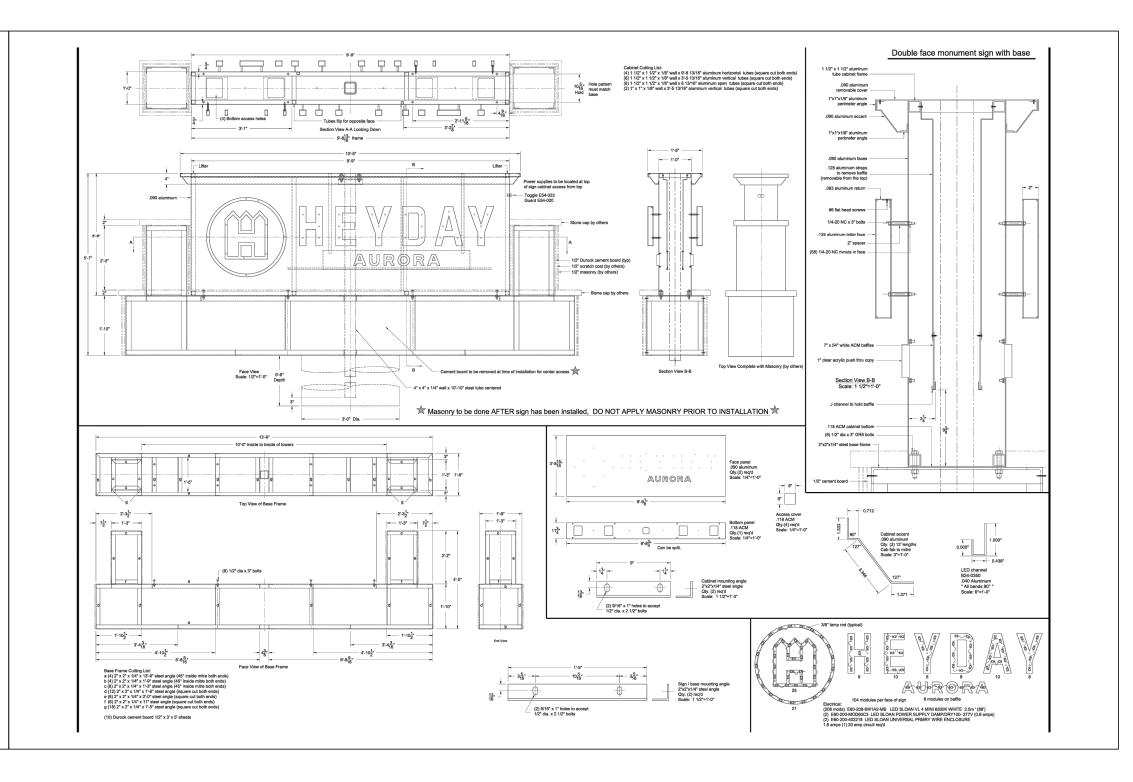

GARY R. WEBER

ASSOCIATES, INC.

LAND PLANNING
ECOLOGICAL CONSULTING
LANDSCAPE ARCHITECTURE

212 SOUTH MAIN STREET
WHEATON, ILLINOIS 60187
PHONE: 630-668-7197

CLIENT
HEYDAY
3400 WEST STONEGATE BLVD SUITE 101
ARLINGTON HEIGHTS, IL 60005

RWG ENGINEERING 975 E 22ND ST., SUITE 400 WHEATON, IL 60189


VOCON 3142 PROSPECT AVENUE E CLEVELAND, OH 44115

HEYDAY AURORA AURORA, ILLINOIS

Q

1 05.22.2025 <u>REVISIONS</u>

DATE 05.23.2025
PROJECT NO. HEY2501
DRAWN CLE
CHECKED CMP
SHEET NO.

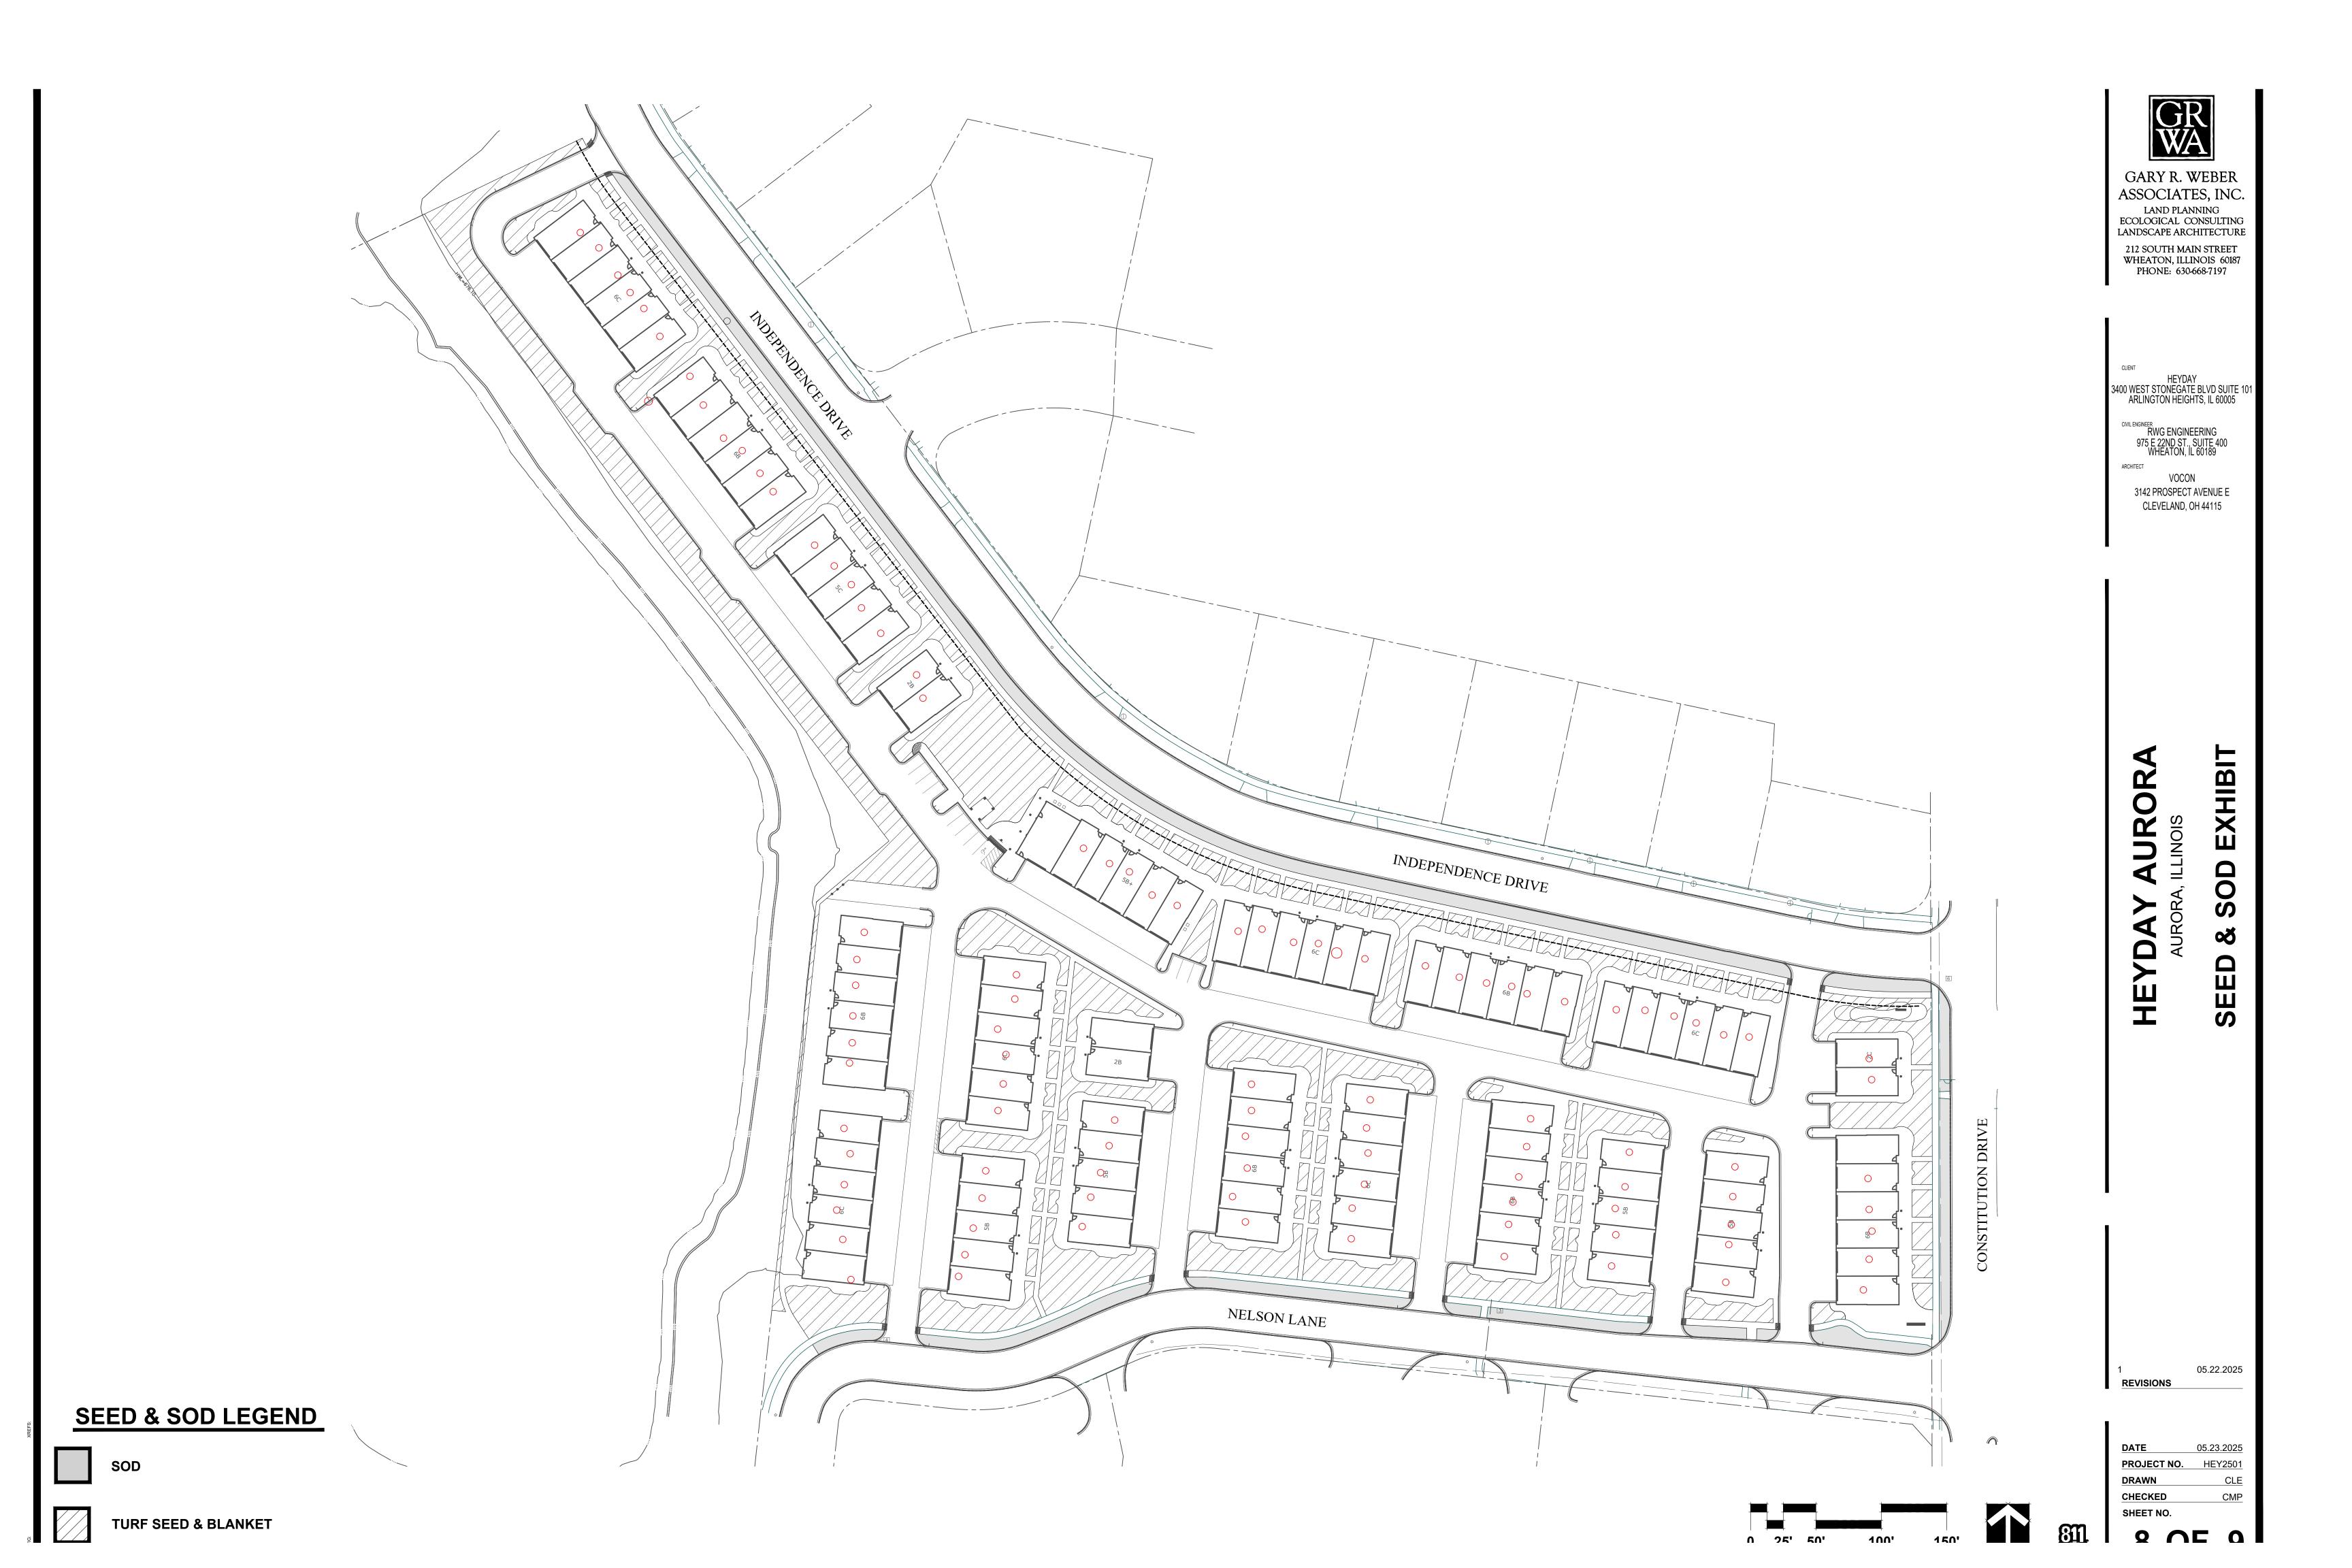

LANDSCAPE WORK PART 1 - GENERAL

1.1 DESCRIPTION OF WORK

The work shall consist of furnishing, transporting and installing all seeds, plants and other materials required for

- 1. The establishment of trees, shrubs, perennial, annual and lawn areas as shown on
- 2. The provision of post-planting management as specified herein; 3. Any remedial operations necessary in conformance with the plans as specified in this
- document; 4. Permits which may be required.

1.2 QUALITY ASSURANCE

A. Work shall conform to State of Illinois Horticultural Standards and local municipal requirements

B. Quality Control Procedures:

- 1. Ship landscape materials with certificates of inspection as required by governmental authorities. Comply with governing regulations applicable to landscape materials.
- 2. Do not make substitutions. If specified landscape material is not obtainable, submit to Landscape Architect proof of non-availability and proposal for use of equivalent
- 3. Analysis and Standards: Package standard products with manufacturer's certified

1.3 SUBMITTALS

A. Plantina Schedule

Submit three (3) copies of the proposed planting schedule showing dates for each type of planting

B. Maintenance Instruction - Landscape Work

Submit two (2) copies of typewritten instructions recommending procedures to be established by the Owner for the maintenance of landscape work for one full year. Submit prior to expiration of required maintenance periods.

Instructions shall include: watering, fertilizing, spraying, mulching and pruning for plant material and trimming groundcover. Instructions for watering, fertilizing and mowing grass areas shall be provided ten (10) days prior to request for inspection for final acceptance. Landscape Architect shall receive copies of all instructions when issued.

- C. Submit two (2) copies of soil test of existing topsoil with recommendations for soil additive requirement to Landscape Architect for review and written approval.
- D. Submit two (2) samples of shredded hardwood bark mulch, erosion control blankets, and all other products and materials as specified on plans to Landscape Architect for review and written approval
- E. Nursery packing lists indicating the species and quantities of material installed must be provided to the Owner and/or City upon request.

- A. Examine and evaluate grades, soils and water levels. Observe the conditions under which work is to be performed and notify Landscape Architect of unsatisfactory conditions. Do not proceed with the work until unsatisfactory conditions have been corrected in an acceptable manner.
- B. Utilities: Review underground utility location maps and plans; notify local utility location service; demonstrate an awareness of utility locations; and certify acceptance of liability for the protection of utilities during course of work. Contractor shall be responsible for any damage to utilities or property.
- C. Excavation: When conditions detrimental to plant growth are encountered such as rubble fill, adverse drainage conditions or obstructions, notify Landscape Architect before planting.

1.5 GUARANTEES

- A. Guarantee seeded and sodded areas through the specified maintenance period and until
- B. Guarantee trees, shrubs, groundcover and perennials for a period of one year after date of acceptance against defects including death and unsatisfactory growth, except for defects resulting from neglect by Owner, abuse or damage by others or unusual phenomena or incidents which are beyond Landscape Installer's control.

LANDSCAPE WORK PART 2 - PLANT MATERIALS

2.1 LAWN SOD

Provide strongly rooted sod, not less than two (2) years old and free of weeds and undesirable native grasses. Provide only sod capable of growth and development when planted (viable, not dormant) and in strips not more than 18" wide x 4' long. Provide sod composed of a 5-way blend of Kentucky Bluegrass such as: Midnight, Allure, Viva, Washington, Liberty.

2.2 LAWN SEED MIXTURE

Grass Seed: Provide fresh, clean, new crop seed complying with the tolerance for purity and germination established by the Official Seed Analysts of North America. Provide seed of the grass species, proportions and maximum percentage of weed seed, as specified.

A. Lawn Seed Mixture - 5 lbs./1,000 sq. ft. 50% Kentucky Bluegrass 98/85

- 15% Cutter Perennial Ryegrass
- 10% Spartan Hard Fescue 10% Edge Perennial Ryegrass
- 10% Express Perennial Ryegrass 5% Pennlawn Creeping Red Fescue
- B. Temporary Lawn Seed Mixture 5 lbs./1,000 sq.ft.
- 40% Kentucky Bluegrass 98/85
- 40% Perennial Ryegrass 20% Annual Ryegrass

2.3 GROUNDCOVERS, PERENNIALS AND ANNUALS

Provide plants established and well-rooted in removable containers or integral peat pots and with not less than the minimum number and length of runners required by ANSI Z60.1 for the pot size shown or listed.

2.4 TREES AND SHRUBS

- A. Name and Variety: Provide nursery grown plant material true to name and variety.
- B. Quality: Provide trees, shrubs and other plants complying with the recommendations and requirements of ANSI Z60.1 "Standard for Nursery Stock" and as further
- C. Deciduous Trees: Provide trees of height and caliper listed or shown and with branching configuration recommended by ANSI Z60.1 for type and species required. Provide single stem trees except where special forms are shown or listed. Provide balled and burlapped (B\$B) deciduous trees.
- D. Deciduous Shrubs: Provide shrubs of the height shown or listed and with not less than the minimum number of canes required by ANSI Z60.1 for the type and height of shrub required. Provide balled and burlapped (B\$B) deciduous shrubs.
- E. Coniferous Evergreen: Provide evergreens of the sizes shown or listed. Dimensions indicate minimum spread for spreading and semi-spreading type evergreens and height for other types. Provide quality evergreens with well-balanced form complying with requirements for other size relationships to the primary dimension shown. Provide balled and burlapped (B\$B) evergreen trees and containerized shrubs.

F. Inspection: All plants shall be subject to inspection and review at the place of growth or upon delivery and conformity to specification requirements as to quality, right of inspection and rejection upon delivery at the site or during the progress of the work for size and condition of balls or roots, diseases, insects and latent defects or injuries. Rejected plants shall be removed immediately from the site.

2.5 PLANTING SOIL MIXTURE

Provide planting soil mixture consisting of clean uncompacted topsoil (stockpiled at site) for all planting pits, perennial, annual and groundcover areas. Topsoil shall be conditioned based on any recommendations resulting from the soil test in 1.3.C.

26 EROSION CONTROL

- A. Lawn Seed Areas Erosion Control Blanket: North American Green DS75, or equivalent
- B. Native Areas Erosion Control Blanket: North American Green \$150, or equivalent approved equal.

2.7 MULCH

Provide mulch consisting of shredded hardwood. Provide sample to Landscape Architect for approval prior to ordering materials.

LANDSCAPE WORK PART 3 - EXECUTION

3.1 PLANTING SCHEDULE

At least thirty (30) days prior to the beginning of work in each area, submit a planting schedule for approval by the Landscape Architect.

3.2 PLANTINGS

A. Sodding New Lawns

- 1. Remove existing grass, vegetation and turf. Dispose of such material legally off-site, do not turn over into soil being prepared for lawns.
- 2. Till to a depth of not less than 6"; apply soil amendments as needed; remove high areas and fill in depressions; till soil to a homogenous mixture of fine texture, remove lumps, clods, stones over 1" diameter, roots and other extraneous matter. Dispose of such material legally off-site.
- 3. Sodded areas shall receive an application of commercial fertilizer at the rate of 10 lbs. per 1,000 sq. ft. and shall have an analysis of 16-8-8.
- 4. Lay sod within 24 hours from time of stripping.
- 5. Lay sod to form a solid mass with tightly fitted joints. Butt ends and sides of sod strips; do not overlap. Stagger strips to offset joints in adjacent courses. Work from boards to avoid damage to subgrade or sod. Tamp or roll lightly to ensure contact with subgrade. Work sifted soil into minor cracks between pieces of sod; remove excess to avoid smothering of adjacent grass
- 6. Water sod thoroughly with a fine spray immediately after planting.

- 1. Remove existing grass, vegetation and turf. Dispose of such material legally off-site. Do not turn over into soil being prepared for lawns.
- 2. Till to a depth of not less than 6"; apply soil amendments; remove high areas and fill in depressions; till soil to a homogenous mixture of fine texture, remove lumps, clods, stones over 1" diameter, roots and other extraneous matter. Dispose of such material legally off-site.
- 3. Seeded lawn areas shall receive an application of commercial fertilizer at the rate of 5 lbs. per 1,000 sq. ft. and shall be 6-24-24. Fertilizer shall be uniformly spread and mixed into the soil to a depth of 1" inches
- 4. Do not use wet seed or seed which is moldy or otherwise damaged in transit or storaae.
- 5. Sow seed using a spreader or seeding machine. Do not seed when wind velocity exceeds five (5) miles per hour. Distribute seed evenly over entire area by sowing equal quantity in two directions at right angles to each other.
- 6. Sow not less than specified rate.
- 7. Rake lawn seed lightly into top 1" of soil, roll lightly and water with a fine spray.
- 8. After the seeding operation is completed, spray a wood fiber mulch (Conweb 2000 with tacifier or approved equal) over the entire grassed area at the rate of 2,000 lbs. per acre. Use a mechanical spray unit to insure uniform coverage. Exercise care to protect buildings, automobiles and people during the application of the mulch.

C. Groundcover and Perennial Beds

Groundcover, perennials, and annuals shall be planted in continuous beds of planting soil mixture a minimum of 8" deep. Install per spacing indicated on plan.

D. Trees and Shrubs

- 1. Set balled and burlapped (B\$B) stock plumb and in center of pit or trench with top of ball at an elevation that will keep the root flare exposed upon backfill and mulching. Remove burlap from top and sides of balls; retain on bottoms. When set, place additional topsoil backfill around base and sides of ball and work each layer to settle backfill and eliminate voids and air pockets. When excayation is approximately 2/3 full, water thoroughly before placing remainder of backfill. Repeat watering until no more is absorbed. Water again after placing final layer of backfill.
- 2. Dish top of backfill to allow for mulching. Provide additional backfill berm around edge of excavations to form shallow saucer to collect water.
- 3. Mulch pits, trenches and planted areas. Provide not less than 2" thickness of mulch and work into top of backfill and finish level with adjacent finish grades. Maintain exposed root flare at all times.
- 4. Prune only injured or dead branches from flowering trees, if any. Protect central leader of tree during shipping and pruning operations. Prune shrubs to retain natural character in accordance with standard horticultural practices.
- 5. Remove and replace excessively pruned or ill-formed stock resulting from improper prunina.
- 6. The Contractor shall be wholly responsible for assuring that all trees are planted in a vertical and plumb position and remain so throughout the life of this contract and guarantee period. Trees may or may not be staked and guyed depending upon the individual preference of the Contractor; however, any bracing procedure(s) must be approved by the Owner prior to its installation.

3.3 LANDSCAPE MAINTENANCE

A. Turf Maintenance Mowing

- a. All litter (i.e. paper, cans and bottles) will be removed from turf and plant bed areas prior to mowing.
- b. All lawn areas will be mowed weekly to a height of 3" from April through November, or as needed. No more than 1/3 of the grass blade is to be removed per cutting. Mowing height may be seasonally adjusted depending upon weather
- c. Mowing patterns shall be altered on a weekly basis wherever possible. Mowing patterns shall create straight lines for a more manicured appearance.
- d. Clippings shall be bagged and removed when clipping buildup is such that the excess clipping lay in an unsightly matted condition on the lawn.
- e. The turf shall be cut in such a manner as to avoid blowing clippings toward structures, patios, air conditioners, and planting beds.
- f. If the turf could potentially be damaged by equipment due to weather, mowing should not be performed.
- g. Turf bordering vertical surfaces such as foundations, fences, and utility boxes shall be trimmed to match the mowing height.

conditions in order to reduce stress and promote healthy turf.

h. Clippinas shall be removed from all pavement areas

Edging

- a. Turf areas adjacent to walks, driveways and curbing will be mechanically edged monthly in a uniform manner.
- b. Shrub beds and tree rings shall be neatly and uniformly edged twice per year; once during the spring cleanup, and again in August or September weather permitting.
- 3. Fertilizer \$ Weed Control
- a. Pesticides must be applied by a licensed individual.
- b. Notice shall be given to the homeowners association or owner's representative week prior to any pesticide application.
- c. The lawn shall be fertilized three (3) times with a high quality granular or liquid formula. The applications should be made approximately in April, May and September. Timing, frequency and rate of application shall be adjusted to meet the development's current needs and conditions
- d. A pre-emergent weed control application for annual grass prevention shall be incorporated into the first turf fertilization in spring.
- e. The entire turf area will be treated one (1) time with a post emergent broad leaf weed control at the appropriate time of year. Spot treatment should be done as
- f. Flags shall be posted throughout the community following each fertilizer application. Remove flags once the application is dry or as directed by the product's label.

B. Planting Bed Maintenance

Pruning

- a. Trees, shrubs and evergreens should be pruned, trimmed or sheared at the appropriate time for each species to maintain the plant's proper form. Methods and timing shall conform to standard horticultural practices. The initial spring pruning will include:
- 1. Removal of dead or injured limbs.
- 2. Removal of branches that are touching structures.
- 3. Shaping and internal thinning of the plant to allow for its natural
- form and habit b. Shrubs will be pruned two (2) additional times at the appropriate time so as not to interfere with flowering.
- c. Trees over 6" in diameter will not be pruned other than removal of low branches
- hazardous to pedestrian traffic and sucker growth which may occur.
- d. Groundcovers should be pruned twice during the season to maintain a neat
- e. Ornamental grasses should be trimmed during the spring cleanup.
- f. All pruning debris shall be removed from the site by the contractor immediately after the work is complete.

- 2. Fertilizer # Weed Control a. Pesticides must be applied by a licensed individual
- b. Notice shall be given to the homeowner's association I week prior to any pesticide
- application. c. Pre-emergent weed control shall be applied at the beginning of the growing season.
- d. Post emergent applications or hand pulling shall be used on any weeds that appear throughout the season
- e. Trees, shrubs and groundcover shall be fertilized one (1) time during the season. The application rate will be determined by the specific needs of the plant material.

C. Spring \$ Fall Cleanup

1. Spring Cleanup

- a. Lawn areas and planting beds will be raked as necessary to remove leaves, dead branches, litter and debris.
- b. All mulch beds shall be cultivated to break up any existing compaction in the
- c. Fresh mulch should be applied to any bare spots in the planting beds. d. Monitor plant health and notify homeowner's association or owner's representative
- e. Debris generated during the cleanup shall be disposed of legally off site.

- a. All lawn areas will have leaves removed either by raking or through the mowing
- process so as to prevent leaf buildup on the turf on a weekly basis. b. All planting beds will have leaves and debris removed at the end of the season.
- c. Perennials without winter interest shall be cut back
- d. Monitor plant health and notify homeowner's association or owner's representative of any dead plants.

3.5 CLEAN UP AND PROTECTION

A. During landscape work, store materials and equipment where directed. Keep

e. Debris generated during the cleanup shall be disposed of legally off site.

pavements clean and work areas and adjoining areas in an orderly condition. B. Protect landscape work and materials from damage due to landscape operations, operations by other trades and trespassers. Maintain protection during installation and maintenance periods. Treat, repair or replace damaged landscape work as

directed by Landscape Architect. 3.5 CLEAN UP AND PROTECTION

- A. During landscape work, store materials and equipment where directed. Keep
- B. Protect landscape work and materials from damage due to landscape operations, operations by other trades and trespassers. Maintain protection during installation and maintenance periods. Treat, repair or replace damaged landscape work as

pavements clean and work areas and adjoining areas in an orderly condition.

directed by Landscape Architect. 3.6 INSPECTION AND ACCEPTANCE

- A. The Landscape Architect reserves the right to inspect seeds, plants, trees and shrubs either at place of growth or at site before planting for compliance with
- B. Supply written affidavit certifying composition of seed mixtures and integrity of plant materials with respect to species, variety and source.

requirements for name, variety, size, quantity, quality and mix proportion.

- C. Notify the Landscape Architect within five (5) days after completing initial and/or supplemental plantings in each area.
- D. When the landscape work is completed, including maintenance, the Landscape Architect will, upon request, make a final inspection to determine acceptability. After final acceptance, the Owner will be responsible for maintenance.



GARY R. WEBER ASSOCIATES, INC LAND PLANNING ECOLOGICAL CONSULTING LANDSCAPE ARCHITECTURE 212 SOUTH MAIN STREET

WHEATON, ILLINOIS 60187

PHONE: 630-668-7197

3400 WEST STONEGATE BLVD SUITE ARLINGTON HEIGHTS, IL 60005

CIVIL ENGINEER RWG ENGINEERING 975 E 22ND ST., SUITE 400 WHEATON, IL 60189 ARCHITECT

> 3142 PROSPECT AVENUE E CLEVELAND. OH 44115

VOCON

Ō

0

里

4

Δ **1** S Z

05.22.2025 REVISIONS

05.23.2025 DATE PROJECT NO. HEY2501 CMP CHECKED SHEET NO.