
# ELEVATIONS

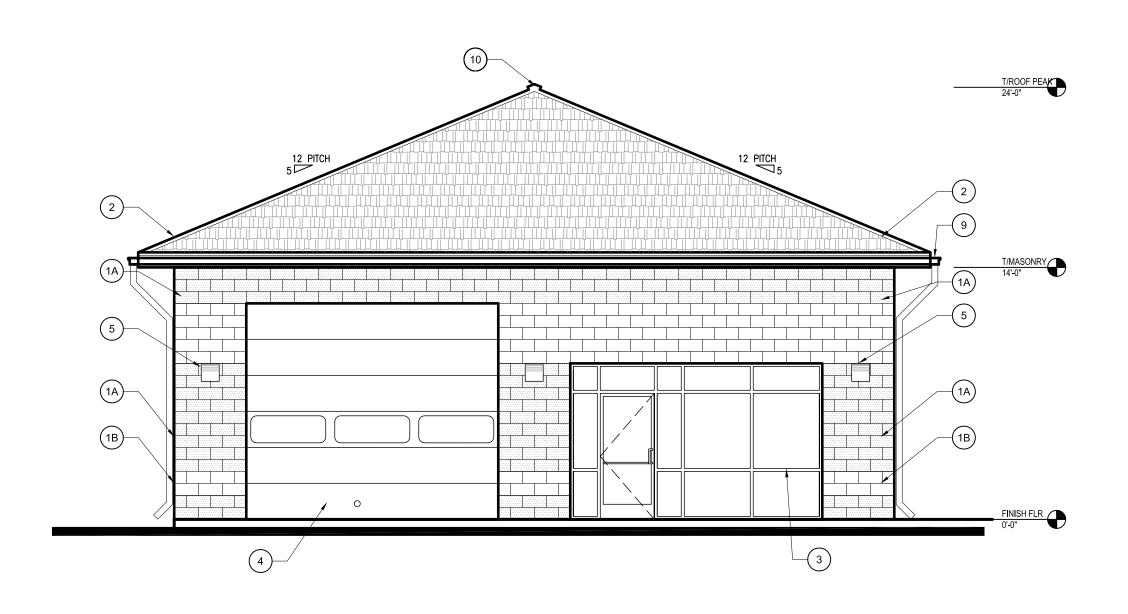

PROPOSED EAST ELEVATION

SCALE: 3/16"=1'-0"

### **EXTERIOR SIGNAGE**


ANY EXTERIOR SIGNAGE WILL REQUIRE A SEPARATE PERMIT

### **EXTERIOR BUILDING ADDRESS**

BUILDING ADDRESS NUMBERS TO BE NO LESS THAN 4" IN HEIGHT AND PROPORTIONATE WIDTH. THE COLOR OF THE NUMBERS MUST CONTRAST SHARPLY WITH THE BACKGROUND COLOR AND BE PLACED ON, ABOVE OR IMMEDIATELY TO THE SIDE OF THE FRONT DOOR OR AT SOME OTHER MORE CONSPICUOUS LOCATION ON THE FRONT OF THE BUILDING IN PLAIN VIEW FROM THE STREET. ROMAN NUMERALS AND SCRIPT NUMBERS ARE NOT ALLOWED.

Α	BUILDING HEIGHT	24'-0"
В	GRADE ELEVATION	0'-0"
C	EXTERIOR MATERIAL LIST	1A 12" SPLIT FACE CMU — COLOR TYPE A — TO BE SELECTED BY ARCHITECT — PROVIDE FOAMED—IN INSULATION  1B 12" SMOOTH FACE CMU — COLOR TYPE B — TO BE SELCTED BY ARCHITECT — PROVIDE FOAMED—IN INSULATION  2 ARCHITECTURAL SHINGLES — REFER TO SECTIONS FOR ROOF CONSTRUCTION SYSTEM  3 DARK ANODIZED ALUMINUM STORFRONT SYSTEM WITH THERMAL BREAK & 1" CLEAR INSULATED GLASS  4 GARAGE DOOR — INSULATED METAL DOOR — PAINT TO MATCH TRIM — SEE DOOR NOTES AND FLOOR PLAN NOTES  5 SECURITY WALL PACK FIXTURE — SEE ELECTRICAL DRAWINGS  6 12" X 12" GLASS BLOCK SET IN MASONRY FLUSH WITH EXTERIOR — BOND BEAM LINTEL WITH SMOOTH CMU SILL  7 HOLLOW METAL DOOR AND FRAME — SEE DOOR SCHEDULE — COLOR TO MATCH ADJACENT WALL — TO BE DETERMINED BY ARCHITECT  8 HIGH OUTPUT LED FLOOD LIGHT — SEE ELECTRICAL DRAWINGS  9 GUTTER WITH DOWNSPOUTS  10 RIDGE VENT (TYPICA) — SEE SECTIONS AND DETAILS
D	PERCENT OF EACH FACADE WHICH WILL BE COVERED WITH BRICK	NORTH: N/A SOUTH: N/A EAST: N/A WEST: N/A
E	TOTAL SQUARE FOOTAGE OF PROPOSED BUILDING	4,000 S.F.

		SULATION TAI			FENESTF Que thermal				TS BY C	COMPONE	ENT		
CLIMATE ZONE	INSULATION ENTIRELY ABOVE DECK	ATTIC AND OTHER	MASS	METAL FRAMED	WOOD FRAMED OR OTHER		SLAB ON GRADE FLR HEATED	OPAQUE DOOR SWINGING	ROLL-UP OR SLIDING DOOR SWINGING	FENESTRATION FIXED U-FACTOR	SHGC	FENESTRATION OPERABLE U-FACTOR	ENTRANCE DOORS U-FACTOR
5 AND MARINE 4	R-30ci	R-38	R-11.4ci		R-13+R-3.8ci OR R-20	R-10 FOR 24 BELOW	R-15 FOR 36 BELOW	U-0.37	R-4.75	0.38	0.40	0.45	0.77
ci = CON	NTINUOS INSULAT	ION											

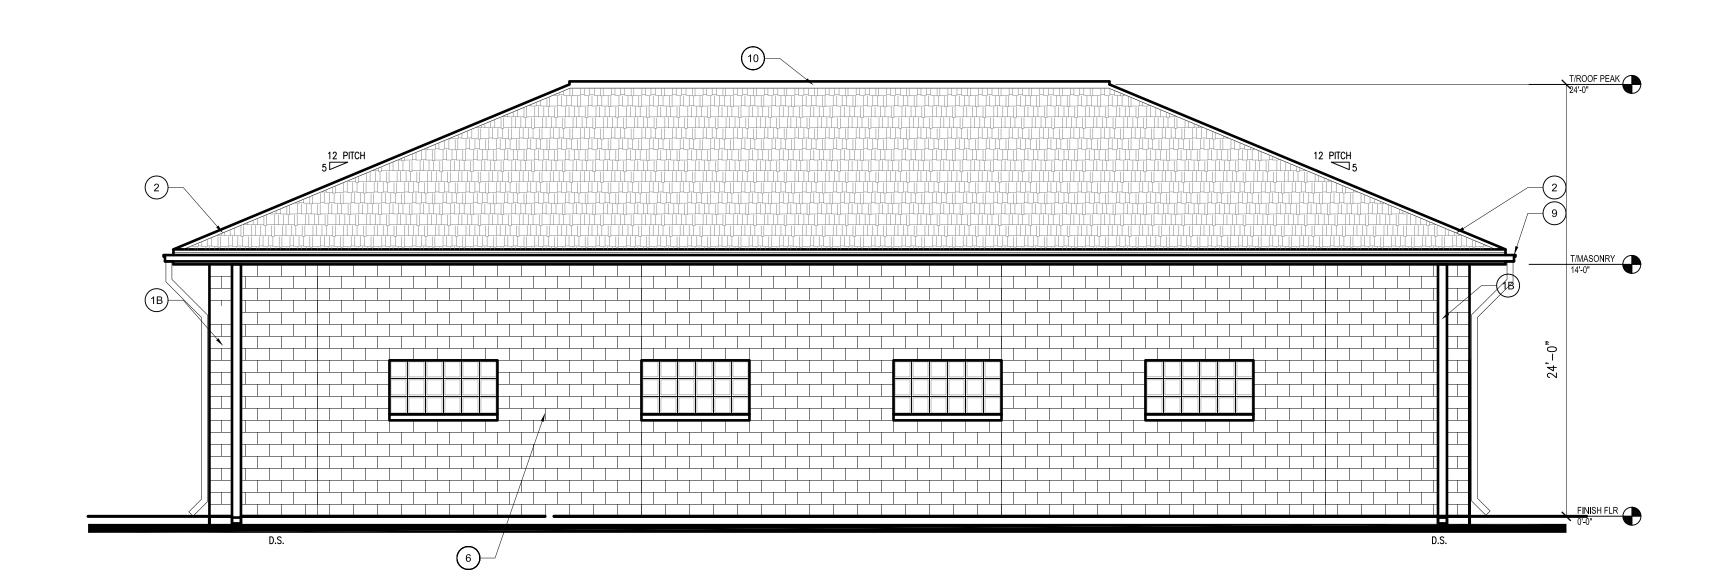

### PROPOSED SOUTH ELEVATION

SCALE: 3/16"=1'-0"



architecture
129 Commercial Drive, Suite 9
Yorkville, Illinois 60560

Phone: 630-385-2945 E-mail: aagama@sbcglobal.net

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ISSUED DATE

FOR APPROVAL

FOR PERMIT 05-22-2017

FOR BID

FOR CONST.

REVISIONS DATE

1
2
3
4

LOT 5 MARSHALL AVE

LOT 5 MARSHALL AVE

AURORA, IL 60505

CLIENT:
JORGE MERA / LILIANA ENRIQUEZ
PHONE: 630-788-5195

JOB NO. 20–082 DATE 12–27–20 FILE 05-236 PLOT SCALE 1:1


OWNER APPROVAL

Signature


SHEET TITLE ELEVATIONS

SHEET NUMBER

# ELEVATIONS

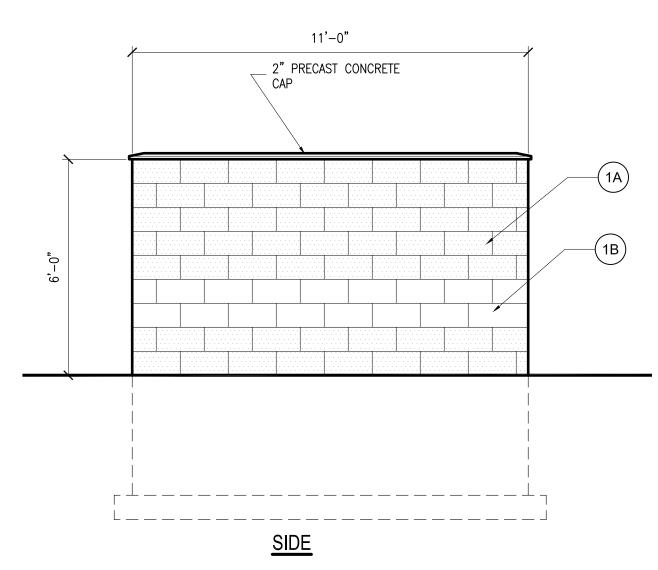

TRASH ENCLOSURE ELEV

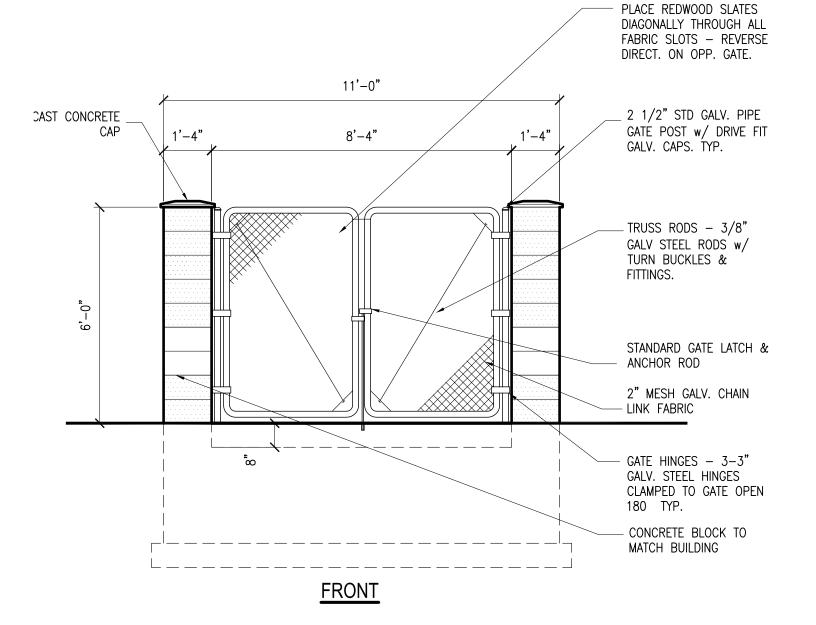


TRASH ENCLOSURE ELEV

architecture 129 Commercial Drive, Suite 9 Yorkville, Illinois 60560

Phone: 630-385-2945 E-mail: aagama@sbcglobal.net


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ISSUED	DATE
FOR APPROVAL	
FOR PERMIT	05-22-2017
FOR BID	

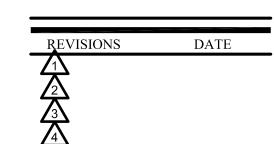

FOR CONST.

### PROPOSED NORTH ELEVATION

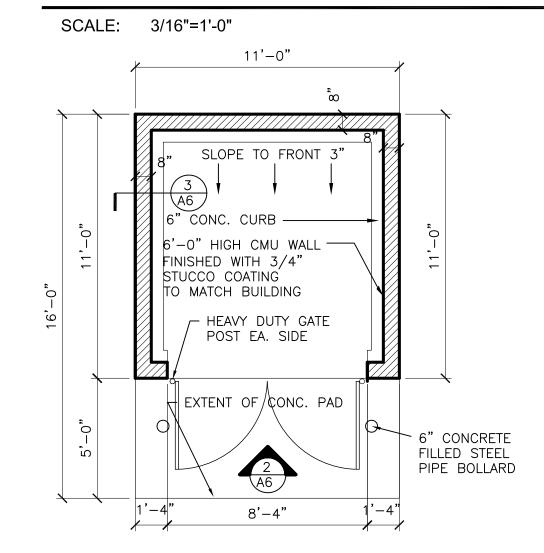


(1B)—


5


(1A)—

(1B)—

SCALE: 1/4"=1'-0"

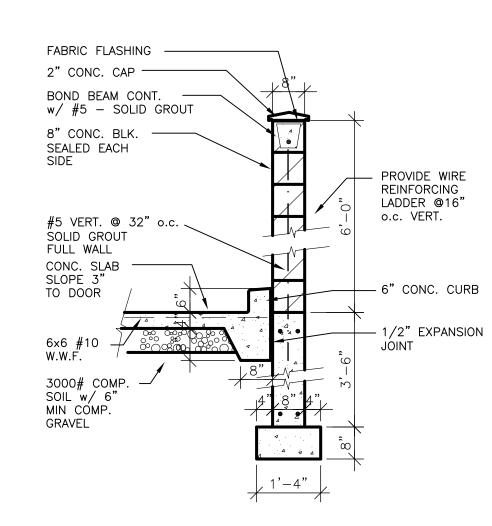

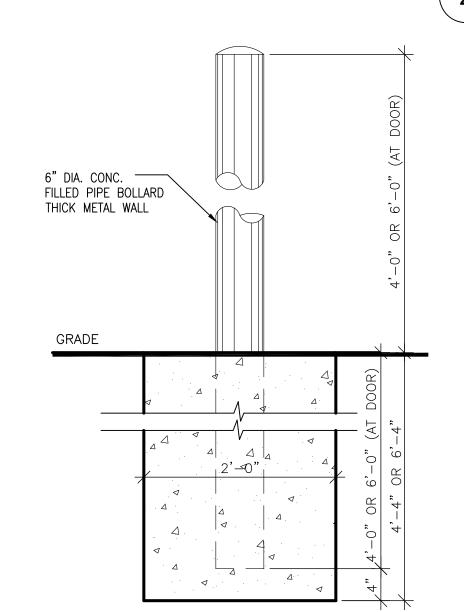

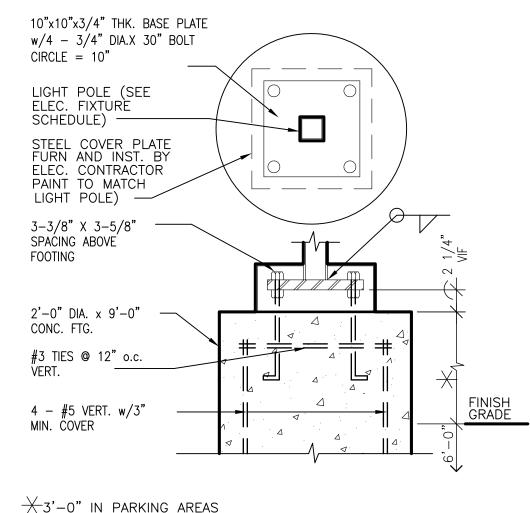


3'-0" IN PARKING AREAS
6" IN LANDSCAPING AREAS
3'-0" IN WALK AREA

SCALE: 1"=1'-0"

### <u>NOTE:</u> SEE SITE PLAN FOR LOCATION TRASH ENCLOSURE PLAN

SCALE: 3/16"=1'-0"



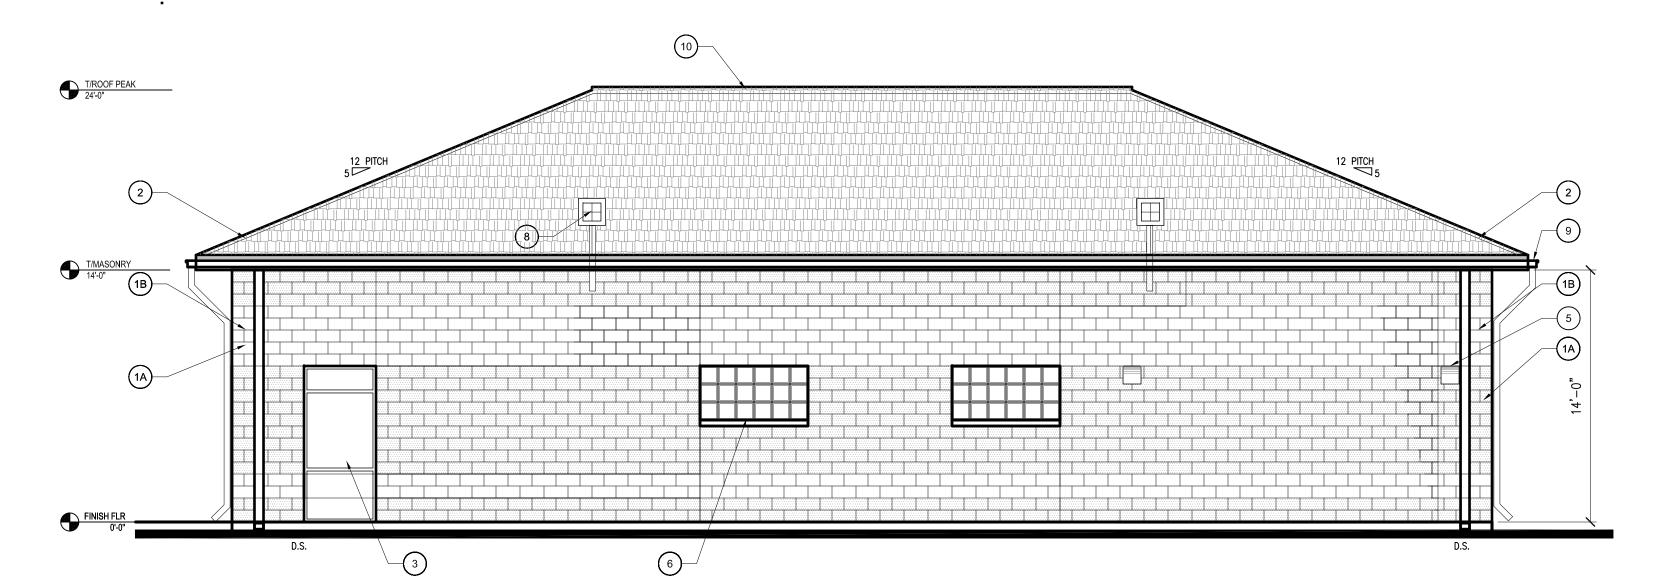

## PROPOSED EAST ELEVATION

BOLLARD DET. SCALE: 1"=1'-0"

## POST BASE DET.

	BUILDING HEIGHT	24'-0"
	GRADE ELEVATION	0'-0"
	EXTERIOR MATERIAL LIST	12" SPLIT FACE CMU — COLOR TYPE A — TO BE SELECTED BY ARCHITECT — PROVIDE FOAMED—IN INSULATION
		18) 12" SMOOTH FACE CMU — COLOR TYPE B — TO BE SELCTED BY ARCHITECT — PROVIDE FOAMED—IN INSULATION
		2 ARCHITECTURAL SHINGLES - REFER TO SECTIONS FOR ROOF CONSTRUCTION SYSTEM
		DARK ANODIZED ALUMINUM STORFRONT SYSTEM WITH THERMAL BREAK & 1" CLEAR INSULATED GLASS
		GARAGE DOOR - INSULATED METAL DOOR - PAINT TO MATCH TRIM - SEE DOOR NOTES AND FLOOR PLAN NOTES
		5 SECURITY WALL PACK FIXTURE - SEE ELECTRICAL DRAWINGS
		6 12" X 12" GLASS BLOCK SET IN MASONRY FLUSH WITH EXTERIOR - BOND BEAM LINTEL WITH SMOOTH CMU SILL
		7 HOLLOW METAL DOOR AND FRAME — SEE DOOR SCHEDULE — COLOR TO MATCH ADJACENT WALL — TO BE DETERMINED BY ARCHITECT
		8 HIGH OUTPUT LED FLOOD LIGHT - SEE ELECTRICAL DRAWINGS
		9 GUTTER WITH DOWNSPOUTS
		10) RIDGE VENT (TYPICA) – SEE SECTIONS AND DETAILS
D	PERCENT OF EACH FACADE WHICH WILL BE COVERED WITH BRICK	NORTH: N/A SOUTH: N/A EAST: N/A WEST: N/A
E	TOTAL SQUARE FOOTAGE OF PROPOSED BUILDING	4,000 S.F.

FILE 05-23 PLOT SCALE 1:1

OWNER APPROVAL

SHEET TITLE **ELEVATIONS** 

SHEET NUMBER A6